
## NOTES:

Schedule

- (I) DIRECT BURIAL POLE SHALL BE RATED FOR WIND VELOCITY PER FBC 2014 5TH EDITION.
- (3) NO. 6 GROUND CONDUCTOR, FURNISHED WITH THE POLE, BONDED AT THE J BOX AT THE BOTTOM OF THE POLE, SEE NOTE #9, AND TO THE EQUIPMENT GROUND CONDUCTOR RAN WITH THE CIRCUIT FROM
- ORIENTATION. PROVIDE PROPER BRACKETS TO MOUNT THE FIXTURE AS SHOWN ON THE PHOTOMETRIC PLAN. COORDINATE WITH THE FACTORY AND PROVIDE BRACKET CUT SHEET TO THE ENGINEER FOR APPROVAL PRIOR TO RELEASE.
- 5 FURNISHED AND INSTALLED IN-LINE BALLAST FUSES IN BUSSMANN "TRON" WEATHERPROOF FUSE
- (6) CONDUIT, EXTEND TO PULL BOX OR NEXT POLE AS REQUIRED.
- $\stackrel{\frown}{}$  3/4" x 10'-0" COPPER CLAD GROUND ROD FOR LIGHTNING PROTECTION. CONNECTION TO THE GROUND ROD SHALL BE MADE VIA A U.L. LISTED MECHANICAL CONNECTION.
- SEE ELECTRICAL SITE PLAN FOR CONDUIT AND WIRE SIZES AND DESTINATION PANEL. WIRE SIZE UP THE POLE SHALL BE SAME SIZE FEEDING THE POLE.
- PROVIDE FLUSH IN GRADE (12"X12"X12" MINIMUM) WEATHERPROOF ELECTRIC HANDHOLE ENCLOSURE. ELECTRICAL HANDHOLE ENCLOSURE SHALL BE PROVIDED AND INSTALLED IN ACCORDANCE WITH N.E.C. ARTICLE 314.30 "HANDHOLE ENCLOSURES". THESE BOXES SHALL BE USED AS PULL BOXES ONLY, NO TERMINATIONS SHALL BE MADE IN THESE BOXES EXCEPT FOR THE GROUND CONDUCTOR. LOCATE BOX WITHIN 3'-O" OF POLE BASE, WHERE POSSIBLE. THE BOX SHALL BE LOCATED IN A LANDSCAPE AREA ONLY AND NOT SUSCEPTIBLE TO ANY TRAFFIC CONDITION. COVER SHALL BE RATED FOR THE LOAD IMPOSED UPON IT, AND SHALL BE PROVIDED WITH LOGO STATING
- DEPTH OF THE EMBEDMENT OF THE POLE SHALL BE AS RECOMMENDED BY POLE MANUFACTURER TO MEET REQUIRED WIND LOADING. MINIMUM EMBODIMENT SHALL NOT BE LESS THAN 8'-0".

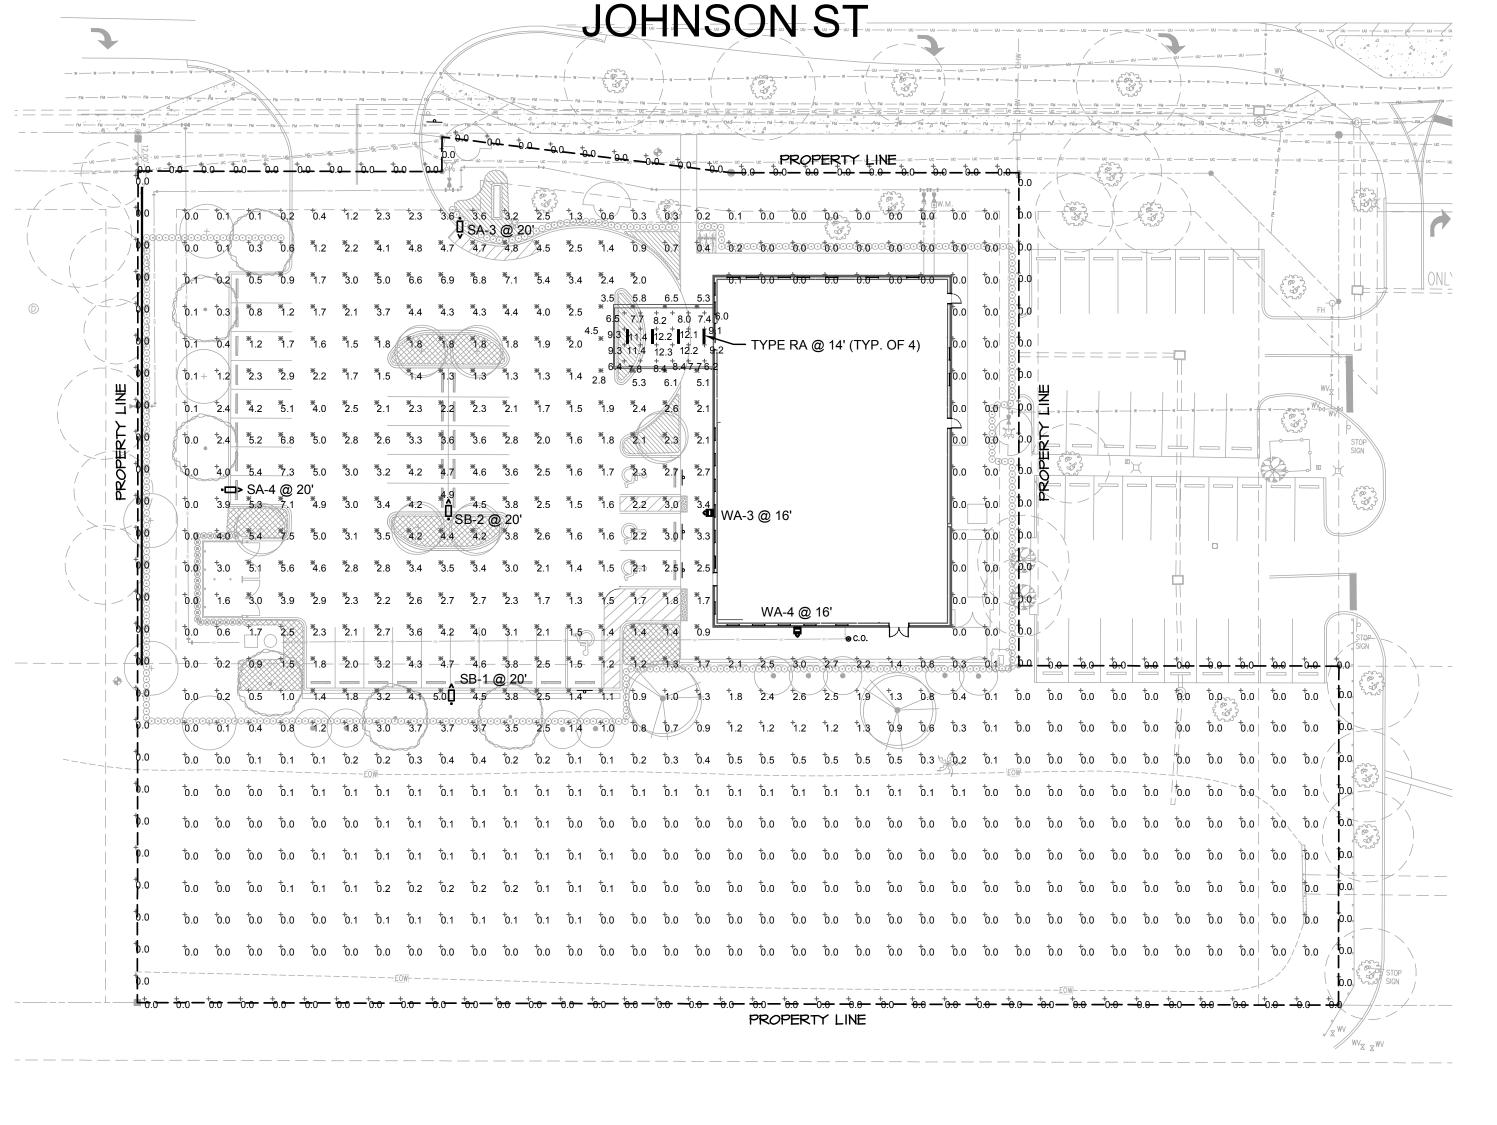

## FIXTURE NOTE:

Surface Schedule

FIXTURE SHOWN ON THIS SHEET IS FOR <u>REFERENCE ONLY.</u>
SEE ACTUAL FIXTURE SCHEDULE ELSE WHERE IN THIS DOCUMENTS FOR ACTUAL CATALOG NUMBER AND DESCRIPTION.

## NOTES:

SEE CUT SPECIFICATION SHEETS ON EO.2.

- 2. ALL FIXTURES ARE 40K IN TEMPERATURE.
- 3. FIXTURES UNDER CANOPY ARE RECESSED.
- 4. ALL SITE AND BUILDING LIGHTS PROPOSED ON THIS PROJECT ARE DESIGNED AS FULL CUTOFF CLASSIFICATION WITH ZERO UP LIGHT COMPONENTS.



THESE PHOTOMETRICS ARE INTENDED FOR DESIGN AND EVALUATION PURPOSES ONLY. THE POINT-BY-POINT SHOWN IS BASED ON A COMPUTER LIGHTING PROGRAM WITH APPROXIMATED PARAMETERS. THEREFORE, THESE PHOTOMETRICS MAY VARY FROM ACTUAL FIELD CONDITIONS.

Symbol	Label	Quantity	Manufacturer	Catalog Number	Description	Lamp	Number Lamps	Filename	Lumens Per Lamp	Light Loss Factor	Wattage
•□>	SA	2	Lithonia Lighting	DSX1 LED 60C 1000 40K BLC MVOLT DS	DSX1 LED WITH 60 LEDs @1000 mA, 4000K, BACKLIGHT CONTROL OPTIC	LED	1	DSX1_LED_60C_ 1000_40K_BLC_ MVOLT.ies	16630	0.9	209
>	SB	2	Lithonia Lighting	DSX1 LED 60C 1000 40K T5M MVOLT DS HS	DSX1 LED with 60 LEDs @ 1000 mA , 4000K , TYPE 5 MEDIUM OPTICS WITH HOUSE-SIDE SHIELD	LED	1	DSX1_LED_60C_ 1000_40K_T5M_ MVOLT_HS.ies	17219	0.9	209
Ê	WA	2	Lithonia Lighting	40K T3S MVOLT	DSXW1 LED WITH (2) 10 LED LIGHT ENGINES, TYPE T3S OPTIC, 4000K, @ 1000mA.	LED	1	DSXW1_LED_20 C_1000_40K_T3 S_MVOLT.ies	7650	0.9	73.2
	RA		Melalumen lighting	1L40K-4-M-C-L3-1-R-4	METALUMEN RM4DOD SERIES 4 FT. STRIP LED LUMINAIRE WITH FROSTED LENS	LED Array 30x1 304mmx19mm 5630 package	4	RM4DOD-1L35K- 4-M-L3.ies	718	0.9	23.89

Lum	inaire L	_ocation	s							
		L	_ocation							
No.	Label	х	Υ	Z	МН	Orientation	Tilt	х	Y	Z
6	RA	224.62	265.33	14.00	14.00	0.00	0.00	224.62	265.33	0.00
8	RA	216.62	265.33	14.00	14.00	0.00	0.00	216.62	265.33	0.00
10	RA	208.62	265.33	14.00	14.00	0.00	0.00	208.62	265.33	0.00
12	RA	200.62	265.33	14.00	14.00	0.00	0.00	200.62	265.33	0.00
3	SA	148.41	305.91	20.00	20.00	180.00	0.00	148.41	303.16	0.00
4	SA	74.00	221.24	20.00	20.00	90.00	0.00	76.75	221.24	0.00
1	SB	145.67	156.00	20.00	20.00	0.00	0.00	145.67	158.75	0.00
2	SB	145.00	212.00	20.00	20.00	0.00	0.00	145.00	214.75	0.00
3	WA	227.06	214.00	16.00	16.00	270.00	0.00	227.06	214.00	0.00
4	WA	253.84	177.00	16.00	16.00	180.00	0.00	253.84	177.00	0.00

Statistics						
Description	Symbol	Avg	Max	Min	Max/Min	Avg/Mii
FRONT CANOPY	+	9.2 fc	12.4 fc	6.0 fc	2.1:1	1.5:1
OVERALL SITE	+	1.2 fc	7.5 fc	0.0 fc	N/A	N/A
PAVED AREAS	Т ж	3.0 fc	7.5 fc	0.5 fc	15.0:1	6.0:1
PROE\PERTY LINES	1 +	0.0 fc	0.0 fc	0.0 fc	N/A	N/A

	Relieci	arioc	Normal				
Name	Front	Back	Х	Υ	Z	Area(ft2)	
Solid						•	
Bottom	0%	0%	0.00	0.00	-1.00	8140.00	
Side 1	0%	0%	0.00	1.00	0.00	2220.00	
Side 2	0%	0%	1.00	0.00	0.00	3300.00	
Side 3	0%	0%	0.00	-1.00	0.00	2220.00	
Side 4	0%	0%	-1.00	0.00	0.00	3300.00	
Тор	0%	0%	0.00	0.00	1.00	8140.00	
Solid							
Bottom	50%	50%	0.00	0.00	-1.00	620.00	
Side 1	50%	50%	0.00	1.00	0.00	31.00	
Side 2	50%	50%	1.00	0.00	0.00	20.00	
Side 3	50%	50%	0.00	-1.00	0.00	31.00	
Side 4	50%	50%	-1.00	0.00	0.00	20.00	
Тор	50%	50%	0.00	0.00	1.00	620.00	
Solid							
Bottom	50%	50%	0.00	0.00	-1.00	59.03	
Side 1	50%	50%	-1.00	0.00	0.00	19.99	
Side 2	50%	50%	0.00	1.00	0.00	31.14	
Side 3	50%	50%	1.00	0.00	0.00	0.81	
Side 4	50%	50%	0.00	-1.00	0.00	30.48	
Side 5	50%	50%	1.00	0.00	0.00	18.52	
Side 6	50%	50%	0.00	1.00	0.00	30.52	
Side 7	50%	50%	1.00	0.00	0.00	0.69	
Side 8	50%	50%	0.00	-1.00	0.00	31.06	
Side 9	50%	50%	-0.32	-0.95	0.00	0.12	
Тор	50%	50%	0.00	0.00	1.00	59.03	

CHEHAYEB & ASSOCIATES, INC. CONSULTING PROFESSIONAL ENGINEERS 3702 AZEELE ST. (813) 876-1415 TAMPA, FL 33609

www.chehayeb.com

LIC. #49521 SOUHEIL S. CHEHAYEB CERT. #7340

SOUHEIL S CHEHAYEB LICENSE NO. 49521

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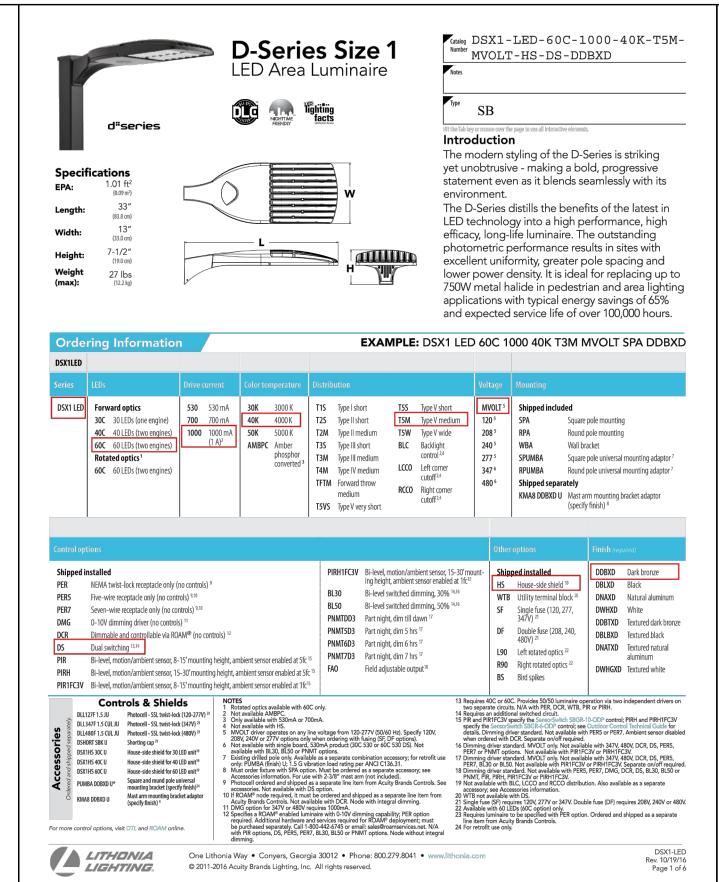
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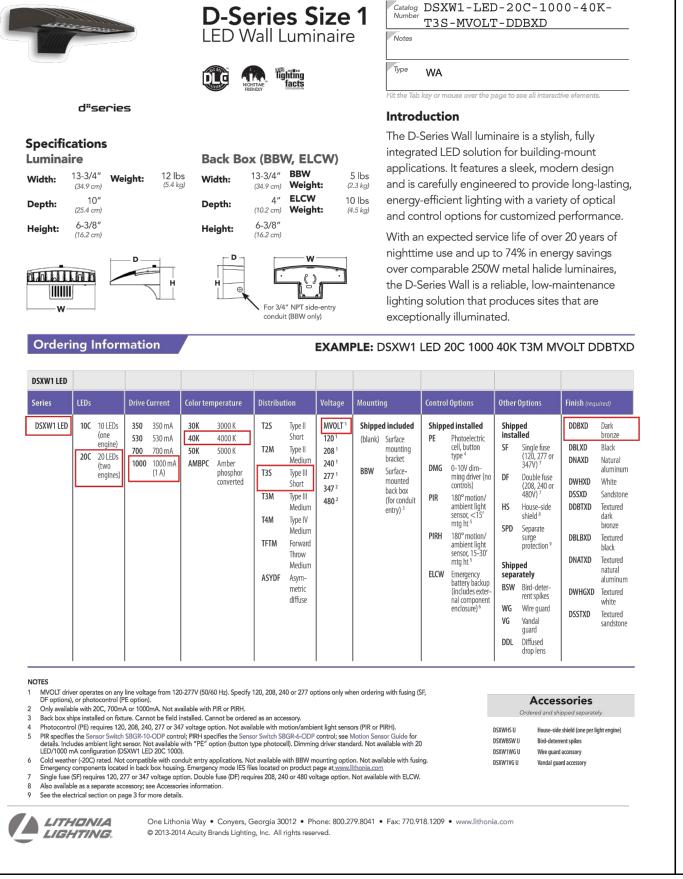
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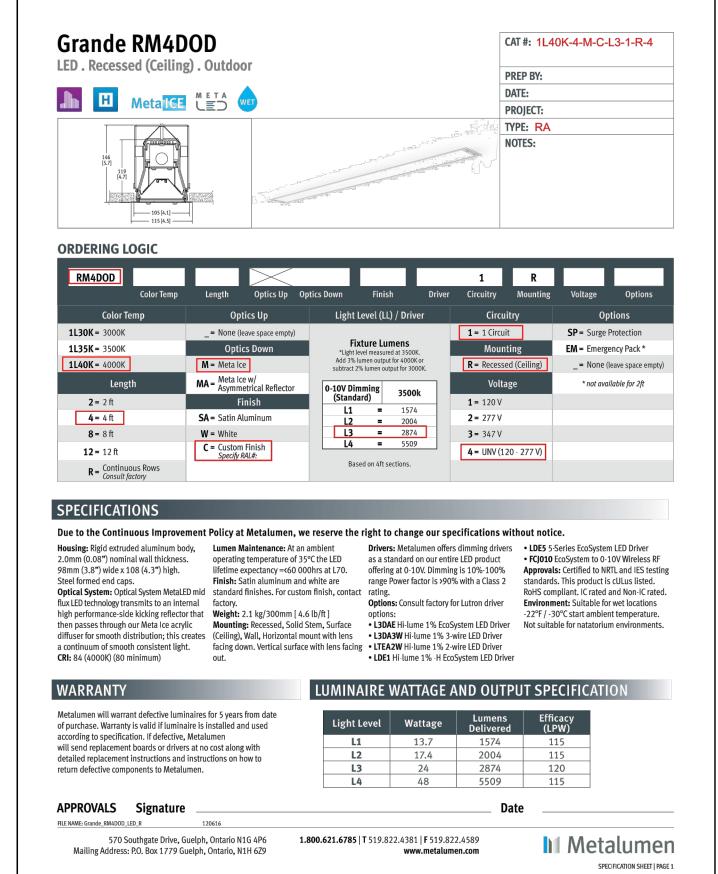
SCALE AS SHOWN JOB No. 010133-01-011 **DATE** 06-28-17

FILE









FIXTURE NOTE:

FIXTURE SHOWN ON THIS SHEET IS FOR REFERENCE ONLY. SEE ACTUAL FIXTURE SCHEDULE ELSE WHERE IN THIS DOCUMENTS FOR ACTUAL CATALOG NUMBER AND DESCRIPTION.

CHEHAYEB & ASSOCIATES, INC. CONSULTING PROFESSIONAL ENGINEERS 3702 AZEELE ST. TAMPA, FL 33609 (813) 876–1415

LIC. #49521 SOUHEIL S. CHEHAYEB CERT. #7340 17-74

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Ш 3302 S, R

SOUHEIL S CHEHAYEB LICENSE NO. 49521 PLAN STATUS XX/XX/XX XXXXX DATE DESCRIPTION

SC RR SC |DESIGN | DRAWN | CHKD SCALE AS SHOWN

JOB No. 010133-01-011 **DATE** 06-28-17 FILE