

FIBER INSTALLATION

INVITATION FOR BID # TS-25-14

Issuance of Solicitation: Tuesday, August 12, 2025

Questions Due Date: Monday, August 25, 2025

Bid Submission Deadline: Tuesday, September 9, 2025

THE CITY OF PEMBROKE PINES
PROCUREMENT DEPARTMENT
8300 SOUTH PALM DRIVE
PEMBROKE PINES, FLORIDA 33025
(954) 518-9020

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- A City FDOT Approved Plans
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- D Specimen Contract Contractual Services Agreement

WWWWWWW - Sample Insurance Certificate



SECTION 1 - NOTICE

Notice is hereby given that the City Commission of the City of Pembroke Pines is seeking sealed proposals for:

IFB # TS-25-14

Fiber Installation

Solicitations may be found on the City of Pembroke Pines website under the Procurement Department at http://www.ppines.com/index.aspx?NID=667, and may be downloaded directly from the OpenGov platform at https://procurement.opengov.com/portal/pembrokepines.

For Technical Support, proposers can reach the OpenGov Service Desk between 7:00 am to 10:00 pm from Monday through Friday via the following methods:

o Chat (preferred method): Click the button in the lower right-hand corner of the portal.

o E-mail: <u>procurement-support@opengov.com</u>

o Phone: 1 (650) 336-7167

If additional help is needed with downloading the solicitation package please contact the Procurement Department at (954) 518-9020 or by email at purchasing@ppines.com. The Procurement Department hours are between 7:00 am to 6:00 pm on Monday through Thursday and is located at 8300 South Palm Drive, Pembroke Pines, FL 33025.

Bidders shall submit all questions regarding this bid via the City's e-Procurement Portal, located at https://procurement.opengov.com/portal/pembrokepines. Please note the deadline for submitting questions. All answers will be posted on the City's e-Procurement Portal. Bidders may also click "Follow" on this bid to receive an email notification when answers are posted. It is the bidder's responsibility to check the portal for updates. Only written responses issued through the OpenGov platform will be considered official for interpretations or clarifications.

Proposals will be accepted until 2:00 pm on Tuesday, September 9, 2025, electronically at https://procurement.opengov.com/portal/pembrokepines/projects/185362.

<u>Bid Opening:</u> The sealed electronic proposals will be publicly opened at 2:30 pm, on the bid due date, by the City Clerk's Office, in the <u>City Clerk's Office Conference Room located on the 4th Floor in the Charles F. Dodge City Center/City Hall Administration Building, located at 601 City Center Way, Pembroke Pines, Florida, 33025.</u>

<u>Virtual Bid Opening:</u> In light of public health concerns and to ensure accessibility for all, the City encourages interested parties and the public to participate virtually via live streaming instead of attending the meeting in person. As a result, meetings may be a combination of in-person and virtual, all as provided by law. To virtually attend the bid opening, please use the Cisco Webex Meetings platform.

Virtual Meeting Details:



City of Pembroke Pines

o WebEx Meeting Link: https://ppines.webex.com/meet/purchasing

o Cisco Webex Meeting Number: 717 019 586

o Join by Phone Number: +1-408-418-9388

The public may download the **Cisco Webex Meetings app** from https://www.webex.com/downloads.html/.

To ensure an efficient meeting process, participants are requested to mute their audio and camera during the meeting. While the public is welcome to attend the virtual bid opening, <u>please note that active participation and commenting will not be allowed during the proceedings.</u>

For further information about the bid opening or assistance in accessing the virtual meeting, please contact:

Ivan Ospinal or other Procurement Staff in the Procurement Department City of Pembroke Pines
8300 South Palm Drive,
Pembroke Pines, FL 33025
(954) 518-9020 or 954-518-9020
purchasing@ppines.com



SECTION 2 - GENERAL PROJECT INFORMATION & TIMELINE

2.1 Project Timeline

The work shall be completed within 120 calendar days from issuance of the City's Notice to Proceed (NTP), with an estimated start date of **October 1, 2025**.

2.2 Tentative Schedule of Events

Issuance of Solicitation (Posting Date):	August 12, 2025
Pre-Bid Meeting (Mandatory):	August 21, 2025, 10:00am
	Fire Station 89 - 13000 Pines Blvd, Pembroke Pines, FL 33027
Question Due Date:	August 25, 2025, 11:30pm
Issuance of Final Answers to Questions:	August 28, 2025
Bid Submission Deadline:	September 9, 2025, 2:00pm
Bid Opening:	Will be held at 2:30 pm on the day of bid submissions are due.
Evaluations by Staff:	To Be Determined (TBD)

2.3 Mandatory Pre-Bid Meeting/Site Visit

There will be a MANDATORY scheduled pre-bid meeting on Thursday, August 21, 2025 at 10:00 am. Meeting location will be at the Fire Station 89 - 13000 Pines Blvd, Pembroke Pines, FL 33027

A. **Proof of Attendance: Vendor**s may be required to sign in at any of the meetings to show proof of attendance. It is the **Vendor**'s responsibility to make sure that they sign in at the meeting.

2.4 Follow-Up Pre-Bid Meeting(s)

Follow-Up Meetings: In the event that a Vendor cannot attend the scheduled pre-bid meeting, or if a Vendor would like a follow up visit to the site, they may request a site visit by contacting **Ivan Ospinal** at (954) 518-9020. We urge all Vendors to attend the scheduled meeting, as a separate or follow-up meeting may not be afforded to the requester due to scheduling and availability of staff to assist with any additional meetings. In addition, if making a request for a separate or follow-up meeting, Vendors are urged to make these requests as early as possible.



2.5 Estimated Project Cost

\$100,000

2.6 Grant/Federal Funding

Not applicable for this project.

2.7 Proposal Security/Bid Bond

A Proposal Security shall not be required for this project.

2.8 Payment and Performance Bonds

Payment and Performance Bonds shall not be required for this project.



SECTION 3 - PURPOSE AND BACKGROUND

3.1 Purpose

The City of Pembroke Pines is seeking bids from qualified firms, hereinafter referred to as the Contractor, to upgrade to fiber optic cabling at two locations, replacing the existing over-the-air connection, in accordance with the terms, conditions, and specifications contained in this solicitation.

This project is designed to enhance network reliability, speed, and bandwidth between City facilities through the installation of fiber optic cabling at two locations. This upgrade will provide secure, high-performance connectivity to support essential City operations, communications, and future technology demands. It will replace the current over-the-air connection and related circuits, improving service delivery and operational efficiency.

This bid package includes two different locations:

- Fire Station 79 to Soccer Park
- Fire Station 89 to Pines Art Center

Please note that vendors may choose to submit proposals for both locations or only one, based on their capacity and interest.

If submitting for only one location, please clearly indicate which one in your proposal.

3.2 Background

Pembroke Pines, Florida, ranked as the eleventh largest city among the state's four hundred plus municipalities and the second largest in Broward County, maintains a welcoming small-town ambiance that resonates with its residents. Located conveniently in southwest Broward County, the city provides seamless access to major highways, employment centers, entertainment venues, parks, golf courses, and a diverse array of dining and shopping options.

With a population of approximately 170,000 residents spread across 32.68 square miles, Pembroke Pines is renowned as one of the best cities to live in America. The city boasts 28 superior parks, lush landscaping, and a distinctive South Florida charm that contributes to its natural beauty. Notably recognized as 2024's Best Place to Raise a Family in Florida, and 2024's Best City of Hispanic Entrepreneurs by WalletHub, Pembroke Pines also earned a place as the on Money Magazine's esteemed Best Places to Live list in 2014, as the sole Florida representative, ranking in at #32 in the nation.

Incorporated in 1960, Pembroke Pines is celebrated as a safe and desirable community, having received accolades such as the All-America City designation. The city's commitment to arts and culture, exceptional schools, diverse population, numerous parks, and forward-thinking approach in an ever-evolving world make it a standout destination.



City of Pembroke Pines

Pembroke Pines is also the home to the largest municipal-run charter school system in the nation, serving over 6,000 students across five separate campuses. The City's award-winning charter school system is located in the Broward County School District, which is the sixth largest school district in the nation.



SECTION 4 - SCOPE OF WORK

4.1 General Summary

Below is the general list of the services required for the installation. It is not intended to be complete. Fire Station 79 to Soccer Park - Refer to Attachment A City FDOT Approved Plans

Fire Station 89 to Pines Art Center - Refer to Attachment B - City Approved Plans - Complete Project Limits; Attachment C - City Approved Plans - Pines BLVD Crossing Only

The project involves the following generalized descriptions of work:

- **Project Routes:** Install underground fiber optic cabling from Fire Station 79 to West Pines Soccer Field (Project 1) and from Fire Station 89 to Pines Art Center (Project 2) to improve inter-facility communications.
- **Construction Method:** Utilize directional boring to install 1.5" HDPE conduits at depths ranging from 36" to 120", tailored to roadway and jurisdiction requirements.
- **Handholes & Utility Avoidance:** Install multiple 30"x48"x36" handholes for fiber access and slack management, with conduit routes determined by soft digs and Sunshine 811 utility locates.
- **Compliance Standards:** Ensure full compliance with City of Pembroke Pines and FDOT construction standards, including ADA accessibility and erosion control.
- **Site Restoration:** Fully restore all disturbed areas including pavement, sidewalks, and landscaping to pre-construction condition.

4.2 Locations

- Fire Station 89 13000 Pines Blvd, Pembroke Pines, FL 33027 to Pines Art Center (Walter C Young) at 901 NW 129Tth Ave, Pembroke Pines, FL 33028
- Fire Station 79 19900 Pines Blvd, Pembroke Pines, FL 33029 to West Pines Soccer Bldg. at 350 SW 196th Ave, Pembroke Pines, FL 33029

4.3 Notice Regarding Mandatory Pre-Bid Site Visit Requirements

Please note that attendance at the mandatory pre-bid site visit is required in order to be eligible to submit a bid. If you are unable to attend the scheduled site visit, you may request a second site visit; however, approval and scheduling will depend on staff availability.



An attendance sheet will be provided and must be signed at each site as proof of attendance. Vendors who do not attend either the original or an approved alternate site visit will not be eligible to participate in the bid.



SECTION 5 - PRICE PROPOSAL / BID TABLE

The vendor must provide their pricing electronically through the designated line items listed on the Bid Sheet/Pricing Table via the City's e-Procurement portal on OpenGov.

Vendor Notes: The bid tables includes a "Vendor Notes" column for any additional comments regarding the requested line item(s). A comment is preferred in the "Vendor Notes" column. If the vendor does not need to submit any comments, they may leave it blank or enter N/A or similar.

Payment & Performance Bonds: The table includes a section for the vendor to submit pricing for Payment & Performance Bonds. If the total cumulative base proposal amount does not exceed \$200,000 and a Payment and Performance Bond is not required, please enter "0" on the "If Applicable, Cost for Payment and Performance Bond" column for each line item.

Primary Responses: The initial Bid Table is for the primary responses so that the vendors can submit the requested goods and/or services.

Line Item	Description	Quantity	Unit of Measure	Unit Cost	Total	Vendor Notes
1-1	Lump Sum Cost for Fiber Installation - Fire Station 79 to Soccer Park	1	Lump Sum			
TOTAL						

Line Item	Description	Quantity	Unit of Measure	Unit Cost	Total	Vendor Notes
2-1	Lump Sum Cost for Fiber Installation - Fire Station 89 to Pines Art Center	1	Lump Sum			
TOTAL						



SECTION 6 - SUBMITTAL DOCUMENTS

Bids must be submitted electronically at https://procurement.opengov.com/portal/pembrokepines on or before 2:00 pm on Tuesday, September 9, 2025. Please note vendors should be registered on OpenGov under the name of the organization that they are operating as and it should match the organization name on the documents that they are submitting and utilizing when responding to the solicitation. In addition, the vendor must complete the required documents in this_section and provide any additional information requested throughout this solicitation. Any additional information requested in the solicitation should be scanned and uploaded. The City recommends for proposers to submit their proposals as soon as they are ready to do so. Please allow ample time to submit your proposals on the https://procurement.opengov.com/portal/pembrokepines website. Proposals may be modified or withdrawn prior to the deadline for submitting Proposals.

PLEASE DO NOT SUBMIT ANY PROPOSALS VIA MAIL, E-MAIL OR FAX.

Prospective proposers interested in responding to this solicitation are requested to provide all of the applicable information listed in this section. Submittals that do not respond completely to all of the requirements specified herein may be considered non-responsive and eliminated from the process. Brevity and clarity are encouraged.

1 CONFIRMATION TO BIND

1 ((DISTRIBUTION TO DIND
1.1	I certify that I have read, understood and agree to the terms in this solicitation, and that I am authorized to submit this response on behalf of my company.*
☐ Please	confirm
*Response	e required
2 CF	ERTIFICATION OF INSURANCE COMPLIANCE AND INTENT TO PROCURE
	ED COVERAGE
However,	endors are not required to purchase any additional insurance in order to submit a bid. they must certify that they either currently hold, or are able and willing to obtain, all assurance coverages, endorsements, and limits prior to award and execution of the contract.
2.1 □ Please	I certify that, if awarded this contract, I will be required to obtain and maintain all insurance policies as detailed in the INSURANCE REQUIREMENTS Section of this solicitation before any work may commence, and throughout the life of the contract.* confirm
*Response	e required
2.2 □ Yes □ No	Do you confirm that you will only use insurance carriers licensed to do business in the State of Florida and rated no less than "A" as to management, and no less than "Class VI as to financial strength by A.M. Best, and that you understand all endorsements required (e.g., Additional Insured, Waiver of Subrogation, etc.) must be included?*



*Response	e required
2.3	Do you currently carry insurance policies that meet or exceed the minimum requirements outlined in the INSURANCE REQUIREMENTS section of this solicitation?*
□ Yes	outlined in the hyberd hyeld relativity section of this solicitation.
*Response	e required
2.3.1 with th	Please upload your current certificate(s) of insurance that demonstrate compliance insurance requirements outlined in this solicitation.*
2.3.2 insuran Condit	Please upload documentation showing that you have obtained a letter from your ace broker or carrier, such as a Letter of Intent to Insure, Evidence of Insurability, or a sional Certificate of Insurance.* sentation should show that:
• Yo	ou can obtain the required insurance.
	e limits and types of coverage will meet the INSURANCE REQUIREMENTS outlined in esolicitation.
• Yo	ou will provide a COI upon contract award.
*Respo	onse required
2.3.3	equals "No" Please upload your current certificate(s) of insurance.* onse required
2.4 □ Yes □ No	Do you believe you are exempt from one or more insurance requirements (e.g., Workers' Compensation)?*
*Response	e required
When 6	equals "Yes"
	Please upload written documentation requesting an exemption on your company ead, subject to City approval.* onse required
2.5 □ Yes	Do you plan on using subcontractors for this project?*



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□ No	
Response 1	required
When eq	uals "Yes"
2.5.1 covered □ Yes	Do you acknowledge that all subcontractors must also carry the same insurance or be under your policy, and that proof of such coverage must be provided to the City?*
□ No	
*Respon	se required

3 REFERENCE # 1

The minimum experience for this project is **five (5) years**. Provide specific examples of similar experience conducting licensed work of equal or similar scope of work, preferably delivered by the proposed team members. A **minimum of 3** references should be from the last **five years** and should be capable of explaining and confirming your firm's capacity to successfully complete the scope of work outlined herein. As part of the proposal evaluation process, the City may conduct an investigation of references, including a record check or consumer affairs complaints. Proposers' submission of a proposal constitutes acknowledgment of the process and consent to investigate. The City is the sole judge in determining Proposers qualifications. In this section you will have the ability to enter information for 5 different references including their contact details and specific project information.

Please note that the City prefers references who are not current employees of the City of Pembroke Pines, as we generally do not contact our own employees for reference checks.

Proposers are advised to confirm that:

- A. Each reference provided by the Respondent has up to date contact persons and contact information;
- B. The contact person provided for each reference is someone who has personal knowledge of the Proposer's performance during the referenced project; and
- C. The contact person for each reference has been contacted by the Proposer regarding this specific bid submittal and such person confirmed their willingness to serve as a reference.
- 3.1 Reference Contact Information Name of Firm, City, County or Agency* *Response required
- 3.2 Reference Contact Information Reference's Business Address*
- *Response required
- 3.3 Reference Contact Information Reference's Contact Name & Title* *Response required



3.4 *Response	Reference Contact Information - Reference's E-mail Address* required
3.5 *Response	Reference Contact Information - Reference's Phone Number* required
3.6 □ Yes □ No	Project Information - Was your firm the prime contractor for the listed project?*
*Response	required
3.7 *Response	Project Information - Name of Contactor Performing the Work* required
3.8 *Response	Project Information - Name and location of the project* required
3.9 *Response	Project Information - Nature of the firm's responsibility on the project and work for which staff was responsible for*
-	Project Information - Project Duration*
3.11 *Response	Project Information - Completion (Anticipated) Date* required
3.12 *Response	Project Information - Size of Project* required
3.13 *Response	Project Information - Cost of Project* required
4 RE	FERENCE # 2
4.1 *Response	Reference Contact Information - Name of Firm, City, County or Agency* required
4.2 *Response	Reference Contact Information - Reference's Business Address* required
4.3 *Response	Reference Contact Information - Reference's Contact Name & Title* required
4.4 *Response	Reference Contact Information - Reference's E-mail Address* required
4.5 *Response	Reference Contact Information - Reference's Phone Number* required



4.6 □ Yes □ No	Project Information - Was your firm the prime contractor for the listed project?*
*Response	required
4.7 *Response	Project Information - Name of Contactor Performing the Work* required
4.8 *Response	Project Information - Name and location of the project* required
4.9 *Response	Project Information - Nature of the firm's responsibility on the project and work for which staff was responsible for* required
4.10 *Response	Project Information - Project Duration* required
4.11 *Response	Project Information - Completion (Anticipated) Date* required
4.12 *Response	Project Information - Size of Project* required
4.13 *Response	Project Information - Cost of Project* required
5 RE	FERENCE # 3
	Reference Contact Information - Name of Firm, City, County or Agency*
	Reference Contact Information - Reference's Business Address*
response	required
•	Reference Contact Information - Reference's Contact Name & Title*
5.3 *Response	Reference Contact Information - Reference's Contact Name & Title* required Reference Contact Information - Reference's E-mail Address*
5.3 *Response 5.4 *Response	Reference Contact Information - Reference's Contact Name & Title* required Reference Contact Information - Reference's E-mail Address* required Reference Contact Information - Reference's Phone Number*
5.3 *Response 5.4 *Response 5.5 *Response	Reference Contact Information - Reference's Contact Name & Title* required Reference Contact Information - Reference's E-mail Address* required Reference Contact Information - Reference's Phone Number*



5.7 *Response	Project Information - Name of Contactor Performing the Work* required
5.8 *Response	Project Information - Name and location of the project* required
	Project Information - Nature of the firm's responsibility on the project and work for which staff was responsible for*
*Response	required
5.10 *Response	Project Information - Project Duration* required
5.11 *Response	Project Information - Completion (Anticipated) Date* required
5.12 *Response	Project Information - Size of Project* required
5.13 *Response	Project Information - Cost of Project* required
6 RE	FERENCE # 4
6.1	Reference Contact Information - Name of Firm, City, County or Agency
6.2	Reference Contact Information - Reference's Business Address
6.3	Reference Contact Information - Reference's Contact Name & Title
6.4	Reference Contact Information - Reference's E-mail Address
6.5	Reference Contact Information - Reference's Phone Number
6.6	Project Information - Was your firm the prime contractor for the listed project?
☐ Yes	
□ No	
6.7	Project Information - Name of Contactor Performing the Work
6.8	Project Information - Name and location of the project
6.9	Project Information - Nature of the firm's responsibility on the project and work for which staff was responsible for
6.10	Project Information - Project Duration
6.11	Project Information - Completion (Anticipated) Date
6.12	Project Information - Size of Project
6.13	Project Information - Cost of Project
7 RE	FERENCE # 5



City of Pembroke Pines

7.1	Reference Contact Information - Name of Firm, City, County or Agency
7.2	Reference Contact Information - Reference's Business Address
7.3	Reference Contact Information - Reference's Contact Name & Title
7.4	Reference Contact Information - Reference's E-mail Address
7.5	Reference Contact Information - Reference's Phone Number
7.6 □ Yes	Project Information - Was your firm the prime contractor for the listed project?
□ No	
7.7	Project Information - Name of Contactor Performing the Work
7.8	Project Information - Name and location of the project
7.9	Project Information - Nature of the firm's responsibility on the project and work for which staff was responsible for
7.10	Project Information - Project Duration
7.11	Project Information - Completion (Anticipated) Date
7.12	Project Information - Size of Project
7.13	Project Information - Cost of Project
8	PROJECT DOCUMENTS
Q 1	PROPOSERS BACKGROUND INFORMATION FORM*

8.1 PROPOSERS BACKGROUND INFORMATION FORM*

- a. Please download the attached document, complete all required fields, and upload the completed form here.
- Proposers_Background_Inform...

9 SWORN STATEMENT ON PUBLIC ENTITY CRIMES UNDER FLORIDA STATUTES CHAPTER 287.133(3)(a)

- 9.1 SWORN STATEMENT ON PUBLIC ENTITY CRIMES FORM*
 - a. Please download the attached document, complete all required fields, and upload the completed form here.
 - Sworn_Statement_on_Public_E...

*Response required

- 9.2 Public Entity Crimes Status*
 - Which option did you select on the Sworn Statement on Public Entity Crimes Form:
 - A) Neither the entity submitting this sworn statement, nor any officers, directors, executives, partners, shareholders, employees, members, or agents who are active in management of the entity, nor any affiliate of the entity have been charged with and convicted of a public entity crime subsequent to July 1, 1989.

^{*}Response required



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- B1) The entity submitting this sworn statement, or one or more of the officers, directors, executives, partners, shareholders, employees, members, or agents who are active in management of the entity, or an affiliate of the entity has been charged with and convicted of a public entity crime subsequent to July 1, 1989, AND There has been a proceeding concerning the conviction before a hearing officer of the State of Florida, Division of Administrative Hearings. The final order entered by the hearing officer did not place the person or affiliate on the convicted vendor list. (Please attach a copy of the final order.)
- B2) The entity submitting this sworn statement, or one or more of the officers, directors, executives, partners, shareholders, employees, members, or agents who are active in management of the entity, or an affiliate of the entity has been charged with and convicted of a public entity crime subsequent to July 1, 1989, AND The person or affiliate was placed on the convicted vendor list. There has been a subsequent proceeding before a hearing officer of the State of Florida, Division of Administrative Hear¬ings. The final order entered by the hearing officer determined that it was in the public interest to remove the person or affiliate from the convicted vendor list. (Please attach a copy of the final order.)
- B3) The entity submitting this sworn statement, or one or more of the officers, directors, executives, partners, shareholders, employees, members, or agents who are active in management of the entity, or an affiliate of the entity has been charged with and convicted of a public entity crime subsequent to July 1, 1989, AND The person or affiliate has not been placed on the convicted vendor list. (Please describe any action taken by or pending with the Department of General Services.)

\square A) No convictions.
\square B1) Convicted, final order did not place on the convicted vendor list
☐ B2) Convicted, listed, then removed.
☐ B3) Convicted, not listed, action pending.
*Response required
9.3 Did you select option B1 or B2 above?* ☐ Yes
□ No
*Response required
When equals "Yes"



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9.3.1 Florida, Di *Response	Please upload a copy of the final order issued by the hearing officer of the State of vision of Administrative Hearings.* required
9.4 Di □ Yes □ No	d you select option B3 above?*
*Response red When equa	•
9.4.1 Services.* *Response	Please describe any action taken by or pending with the Department of General required

10 EQUAL BENEFITS CERTIFICATION FOR DOMESTIC PARTNERS AND ALL MARRIED COUPLES

- 10.1 EQUAL BENEFITS CERTIFICATION FORM*
 - a. Please download the attached document, complete all required fields, and upload the completed form here.
 - Equal Benefits Certificatio...
- *Response required
- 10.2 Equal Benefits Status*
 - Which option did you select on the Equal Benefits Certification Form:
 - A. Contractor currently complies with the requirements of this section; or
 - B. Contractor will comply with the conditions of this section at the time of contract award; or
 - C. Contractor will not comply with the conditions of this section at the time of contract award: or
 - D. Contractor does not comply with the conditions of this section because of the following allowable exemption (Check only one box below):
 - 1. The Contractor does not provide benefits to employees' spouses in traditional marriages;
 - 2. The Contractor provides an employee the cash equivalent of benefits because the Contractor is unable to provide benefits to employees' Domestic Partners or spouses despite making reasonable efforts to provide them. To meet this exception, the Contractor shall provide a notarized affidavit that it has made reasonable efforts to provide such benefits. The affidavit shall state



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the efforts taken to provide such benefits and the amount of the cash equivalent. Cash equivalent means the amount of money paid to an employee with a Domestic Partner or spouse rather than providing benefits to the employee's Domestic Partner or spouse. The cash equivalent is equal to the employer's direct expense of providing benefits to an employee's spouse;

- 3. The Contractor is a religious organization, association, society, or any nonprofit charitable or educational institution or organization operated supervised or controlled by or in conjunction with a religious organization, association, or society;
- 4. The Contractor is a governmental agency;

The contractor is a governmental agency,					
 □ A) Contractor currently complies. □ B) Will comply by contract award. □ C) Will not comply. 					
 □ D1) Does not comply due to an exemption: No spousal benefits for anyone. □ D2) Does not comply due to an exemption: Provides cash equivalent after trying. □ D3) Does not comply due to an exemption: Religious or related nonprofit. □ D4) Does not comply due to an exemption: Government agency. *Response required 					
10.3 Did you select option D2 above?* ☐ Yes ☐ No					
*Response required					
When equals "Yes" 10.3.1 Please upload a notarized affidavit detailing the reasonable efforts made to provide benefits to employees' Domestic Partners or spouses, along with the amount of the cash equivalent provided.* *Response required					
11 DRUG-FREE WORKPLACE CERTIFICATION					
VENDOR DRUG FREE WORKPLACE CERTIFICATION FORM* a. Please download the attached document, complete all required fields, and upload the completed form here.					
• <u>Vendor_Drug-Free_Workplace</u>					
*Response required					
11.2 Drug-Free Status* ☐ Complies fully.					



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 \square Does not comply.

*Response required

12 STANDARD DOCUMENTS

The following documents are standard documents that the City generally requires for every solicitation. As a result, we recommend vendors to keep these documents updated and readily available so that they can be easily uploaded for each project that the vendor would like to participate in. In the event that the City does not have one of the forms or documents listed below for your company, the City may reach out to your company after the bid has closed to obtain the document(s).

12.1 NON-COLLUSIVE AFFIDAVIT*

- a. Please download the attached document, complete all required fields, and upload the completed form here.
- Non-Collusive_Affidavit.pdf
- *Response required

12.2 SCRUTINIZED COMPANY CERTIFICATION*

- a. Please download the attached document, complete all required fields, and upload the completed form here.
- <u>Scrutinized_Company_Certifi...</u>
- *Response required

12.3 E-VERIFY SYSTEM CERTIFICATION*

- a. Please download the attached document, complete all required fields, and upload the completed form here.
- b. Effective January 1, 2021, pursuant to Section 448.095. Florida Statues, the City may not enter into a contract with a vendor/contractor/subcontractor unless that vendor/contractor/subcontractor is registered with and uses the E- Verify system administered by the U.S. Department of Homeland Security ("DHS").
- c. Contractor shall also require all subcontractors to provide an affidavit attesting that the subcontractor does not employ, contract with, or subcontract with, an unauthorized alien. The Contractor shall maintain a copy of such affidavit for the duration of the contract.
- E-Verify_System_Certificati...

^{*}Response required



City of Pembroke Pines

12.4 HUMAN TRAFFICKING AFFIDAVIT*

- a. Please download the attached document, complete all required fields, and upload the completed form here.
- Human_Trafficking_Affidavit...

13 VENDOR REGISTRATION

- Do you currently have a City of Pembroke Pines Vendor Number registered in the PaymentWorks System?*
 - The City of Pembroke Pines utilizes OpenGov as its e-Procurement platform for solicitation and bid submission purposes. However, please be advised that vendor registration for onboarding and processing payments is handled separately through the City's Accounts Payable Division using PaymentWorks, a secure online vendor management platform.
 - All vendors that will be submitting invoices and requiring payments from the City are required to register on the PaymentWorks platform. If the vendor is not currently registered with the City via PaymentWorks and does not have a Vendor Number, the City will have to invite the vendor to register.
 - For formal solicitations such as this project, the Procurement Department will send PaymentWorks registration invitations to vendor(s) who are under active consideration for award. Please be aware that not all vendors who submit proposals will receive an invitation, in order to manage system usage and avoid onboarding vendors who are unlikely to receive payments from the City.
 - Invitations will typically be sent to the contact listed on the submitted Vendor Information Form.

□ Yes □ No
*Response required
When equals "Yes"
13.1.1 What is your Vendor Number?* *Response required

13.2 VENDOR INFORMATION FORM*

- a. Please download the attached document, complete all required fields, and upload the completed form here.
- Vendor_Information_Form.pdf

^{*}Response required



*Response required

13.3 FORM W-9 (REVISED MARCH 2024)*

- a. Please download the attached document, complete all required fields, and upload the completed form here.
- b. Note Please use the March 2024 version of the form as previously dated versions of this form may delay the processing of any payments to the selected vendor.
- Form_W-9_(Rev_March_2024).pdf

14 OPTIONAL DOCUMENTATION

14.1 TRADE SECRETS

- a. The Proposer's response to this solicitation is a public record pursuant to Florida law, which is subject to disclosure by the City under the State of Florida Public Records Law, Florida Statutes Chapter 119.07 ("Public Records Law"). The City shall permit public access to all documents, papers, letters or other material submitted in connection with this solicitation and the Contract to be executed for this solicitation, subject to the provisions of Chapter 119.07 of the Florida Statutes.
- b. Any language contained in the Proposer's response to the solicitation purporting to require confidentiality of any portion of the Proposer's response to the solicitation, except to the extent that certain information is in the City's opinion a Trade Secret pursuant to Florida law, shall be void. If a Proposer submits any documents or other information to the City which the Proposer claims is Trade Secret information and exempt from Florida Statutes Chapter 119.07 ("Public Records Laws"), the Proposer shall clearly designate that it is a Trade Secret and that it is asserting that the document or information is exempt. The Proposer must specifically identify the exemption being claimed under Florida Statutes 119.07. The City shall be the final arbiter of whether any information contained in the Proposer's response to the solicitation constitutes a Trade Secret.
- c. EXCEPT FOR CLEARLY MARKED PORTIONS THAT ARE BONA FIDE TRADE SECRETS PURSUANT TO FLORIDA LAW, DO NOT MARK YOUR RESPONSE TO THE SOLICITATION AS PROPRIETARY OR CONFIDENTIAL. DO NOT MARK YOUR RESPONSE TO THE SOLICITATION OR ANY PART THEREOF AS COPYRIGHTED. ALL DOCUMENTS THAT THE FIRM PURPORTS TO BE CONFIDENTIAL, PROPRIETARY OR A TRADE SECRET SHALL BE UPLOADED TO THE OPENGOV WEBSITE AS A SEPARATE ATTACHMENT, IN THIS SECTION, CLEARLY IDENTIFYING THE EXEMPTION BEING CLAIMED UNDER FLORIDA STATUTES 119.07.

^{*}Response required



City of Pembroke Pines

d. The city's determination of whether an exemption applies shall be final, and the proposer agrees to defend, indemnify, and hold harmless the city and the city's officers, employees, and agent, against any loss or damages incurred by any person or entity as a result of the city's treatment of records as public records.

14.2 FINANCIAL STATEMENTS

- a. The City is <u>NOT</u> requesting the vendor to submit any financial statements for this project and prefers if the vendor does not submit financial statements. In addition, if the City needs a copy of the vendor's financial statements, the City can contact the vendor after the bid due date to request those documents. However, if the vendor does submit the financial statements, they should be uploaded in this section.
- b. Any claim of confidentiality on financial statements must be asserted at the time of submittal. The firm must identify the specific statute that authorizes the exemption from the Public Records Law. Please note that the financial statement exemption provided for in Section 119.071(1)c, Florida Statutes only applies to submittals in response to a solicitation for a "public works" project.

14.3 ALTERNATIVES

- a. If you are submitting an alternative product, please upload any related information in this section (such as specification sheets, etc.).
- b. In addition, pursuant to the "Brand Names" Section included in the GENERAL TERMS AND CONDITIONS Section if and wherever in the specifications a brand name, make, name of manufacturer, trade name, or vendor catalog number is mentioned, it is for the purpose of establishing a grade or quality of material only. Since the City does not wish to rule out other competition and equal brands or makes, the phrase "OR EQUAL" is added. However, if a product other than that specified is bid, Proposers shall indicate on their proposal and clearly state the proposed substitution and deviation. It is the vendor's responsibility to provide any necessary documentation and samples within their bid submittal to prove that the product is equal to that specified. Such samples are to be furnished before the date of bid opening, unless otherwise specified. Additional evidence in the form of documentation and samples may be requested if the proposed brand is other than that specified. The City retains the right to determine if the proposed brand shall be considered as an approved equivalent or not.

14.4 ADDITIONAL INFORMATION

a. Please provide any additional information that you deem necessary to complete your proposal in this section, if it has not been requested in another section.



City of Pembroke Pines

14.5 PROFESSIONAL LICENSES

a. If applicable, please upload any professional licenses that may be required to perform the services outlined in the solicitation.

15 VENDOR CLASSIFICATION

- Is your firm a Local Pembroke Pines Vendor (LPPV) and Local Broward County Vendor (LBCV)?*
 - a. The evaluation of competitive bids is subject to section 35.36 of the City's Procurement Procedures which, except where contrary to federal and state law, or any other funding source requirements, provides that preference be given to local businesses. To satisfy this requirement, the vendor shall affirm in writing its compliance with either of the following objective criteria as of the bid or proposal submission date stated in the solicitation. A local business shall be defined as:
 - 1. "Local Pembroke Pines Vendor" shall mean a business entity which has maintained a permanent place of business with full-time employees within the City limits for a minimum of one (1) year prior to the date of issuance of a bid or proposal solicitation. The permanent place of business may not be a post office box. The business location must actually distribute goods or services from that location. In addition, the business must have a current business tax receipt from the City of Pembroke Pines, OR;
 - 2. "Local Broward County Vendor" shall mean or business entity which has maintained a permanent place of business with full-time employees within the Broward County limits for a minimum of one (1) year prior to the date of issuance of a bid or proposal solicitation. The permanent place of business may not be a post office box. The business location must actually distribute goods or services from that location. In addition, the business must have a current business tax receipt from the Broward County or the city within Broward County where the business resides.
 - b. A preference of five percent (5%) of the total evaluation point, or five percent (5%) of the total price, shall be given to the Local Pembroke Pines Vendor(s); A preference of two and a half percent (2.5%) of the total evaluation point for local, or two and a half percent (2.5%) of the total price, shall be given to the Local Broward County Vendor(s).

☐ Yes
□ No
*Response required
When equals "Yes"



15.1.1 Please indicate your Local Vendor Status* □ Local Pembroke Pines Vendor (LPPV) □ Local Broward County Vendor (LBCV)					
When equals	"Yes"				
	Local Vendor Preference Certification* . Please download the attached document, complete all required fields, and upload the completed form here.				
• Local_V	endor Preference Cer				
*Response re	equired				
When equals	"Yes"				
	Local Business Tax Receipts* If claiming Local Vendor Preference, please upload any previous business tax receipts to indicate that the business entity has maintained a permanent place of business for a minimum of one (1) year.				
*Response required					
a. T	our firm a Veteran Owned Small Business (VOSB)?* The evaluation of competitive bids is subject to section 35.37 of the City's Procurement Procedures which, except where contrary to federal and state law, or any other funding source requirements, provides that preference be given to veteran owned small businesses. To satisfy this requirement, the vendor shall affirm in writing its compliance with the following objective criteria as of the bid or proposal ubmission date stated in the solicitation.				
а	A preference of two and a half percent (2.5%) of the total evaluation point, or two and half percent (2.5%) of the total price, shall be given to the Veteran Owned Small Business (VOSB).				
□ Yes □ No					
*Response requ	ired				
	Upload the "Determination Letter" from the United States Department of Veteran er notifying the business that they have been approved as a Veteran Owned Small				
When equals	"Yes"				



15.2.2 15.3 □ Yes □ No	Upload Veteran Owned Small Business Certification(s) from any relevant agency(ies) Is your firm a Minority-Owned Business Enterprise (MBE)?*
*Response	required
When e	quals "Yes"
15.3.1 (MBE)* <i>Select a</i>	Please indicate the classification of your Minority-Owned Business Enterprise **Il that apply**
□ Afric	can-American MBE
	n-American MBE
	anic-American MBE
-	ve-American MBE
☐ Othe	r option not listed above
*Respon	nse required
When e	quals "Yes"
15.3.2	 MBE Certification Documentation* 1. Upload your MBE Certification Documentation here, preferably with the State of Florida's Office of Supplier Diversity. If you have multiple MBE certifications, please combine them into one (1) document and upload.
*Respon	nse required
15.4 □ Yes □ No	Is your firm a Woman-Owned Business Enterprise (WBE)?*
^k Response	required
When e	quals "Yes"
15.4.1	WMBE Certification Documentation* 1. Upload your WMBE Certification Documentation here, preferably with the State of Florida's Office of Supplier Diversity. If you have multiple WMBE certifications, please combine them into one (1) document and upload.
*Respon	nse required
15.5 □ Yes □ No	Is your firm a HubZone Business / Labor Surplus Area Firm?*



*Response required
When equals "Yes"
 15.5.1 HubZone Business / Labor Surplus Area Firm Certification Documentation* 1. Upload your HubZone Business / Labor Surplus Area Firm Certification Documentation, preferably with the U.S. Small Business Administration (SBA). If you have multiple certifications, please combine them into one (1) document and upload.
*Response required
15.6 Is your firm a Broward County Small Business Enterprise (SBE)?* ☐ Yes ☐ No
*Response required
When equals "Yes"
 SBE Cerification Documentation* Upload your SBE Certification Documentation from Broward County's Office of Economic and Small Business Development (OESBD). If you have multiple certifications, please combine them into one (1) document and upload.
*Response required
15.7 Is your firm a Broward County Business Enterprise (CBE)?* ☐ Yes ☐ No
*Response required
When equals "Yes"
15.7.1 CBE Certification Documentation* 1. Upload your CBE Certification Documentation from Broward County's Office of Economic and Small Business Development (OESBD). If you have multiple certifications, please combine them into one (1) document and upload.
*Response required
15.8 Is your firm a Broward County Disadvantaged Business Enterprise (DBE)?* ☐ Yes ☐ No
*Response required
When equals "Yes"



E PINES City of Pembroke Pines

15.8.1 DBE Certification Documentation*

1. Upload your DBE Certification Documentation from Broward County's Office of Economic and Small Business Development (OESBD). If you have multiple certifications, please combine them into one (1) document and upload.

*Response required

15.9	Does your firm have a Vendor Classification that was not listed above?*
☐ Yes	
□ No	

*Response required

When equals "Yes"

15.9.1 Other Vendor Classification Certification Documentation*

1. Upload your other Certification Documentation here. If you have multiple certifications, please combine them into one (1) document and upload.

*Response required



SECTION 7 - EVALUATION OF PROPOSALS & PROCESS SELECTION


7.1 Qualifying & Selecting Firms

- A. Staff will evaluate all responsive proposals received from proposers who meet or exceed the bid requirements contained in the solicitation. Evaluations shall be based upon the information and references contained in the proposals as submitted.
- B. Staff will make a recommendation to the City Commission for award of contract.
- C. The contract shall be awarded to the most responsive/responsible bidder whose bid is determined to be the most advantageous to the City taking into consideration the evaluation criteria.

PROJECT: KMV-PP-24-001 - FIRE STATION 79 TO WEST PINES SOCCER FIELD BUILDING ADDRESS: 19900 PINES BLVD, PEMBROKE PINES, FL 33029 - ENGINEERING



LINETYPES

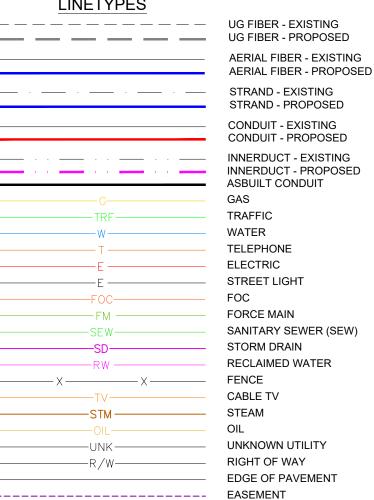



SITE LOCATION



PAGE: -

SUMMARY DATA					
JOB DESCRIPTION	FTG				
DIRECTIONAL BORE	1900'				
HAND TRENCH	10'				
EXISTING CONDUIT	90'				
HANDHOLE	4				

PERMITTING JURISDICTION: * CITY OF PEMBROKE PINES

DATE SUBMITTED 05/28/2024 PLAT BOOK: -

TWP: 51S RNG: 39E SEC:14

CONTACTS

PEMBROKE PINES

JOHN L.ENGLAND **DESIGN ENGINEER**

PHONE: (954) 518-8905 JENGLAND@PPINES.COM

KMV FIBERTELECOM INC

SANDRA KARINA VARGAS

10604 NW 48TH ST

CORAL SPRINGS FL 33076

PHONE: 954-937-5239

KARINAV@KMVFIBERTELECOM.COM

SITE INDEX

01 OF 14 - COVER SHEET/SITE LOCATION

02 OF 14 - OVERALL MAP

03 OF 14 - CONSTRUCTION NOTES

04 OF 14 TO 06E OF 14 - PLAN VIEWS & PROFILES

07 OF 14 - PHOTOGRAPHS

08 OF 14 TO 11 OF 14 - TYPICAL


12 OF 14 TO 14 OF 14 - MOTS

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PEMBROKE **PINES**

PROJECT NUMBER: KMV-PP-24-001 LOCATION: 19900 PINES BLVD PEMBROKE PINES EL 33029 DRAWING NAME: KMV-PP-24-001 - FIRE STATION 79 TO WEST PINES SOCCER



CONSTRUCTION NOTES

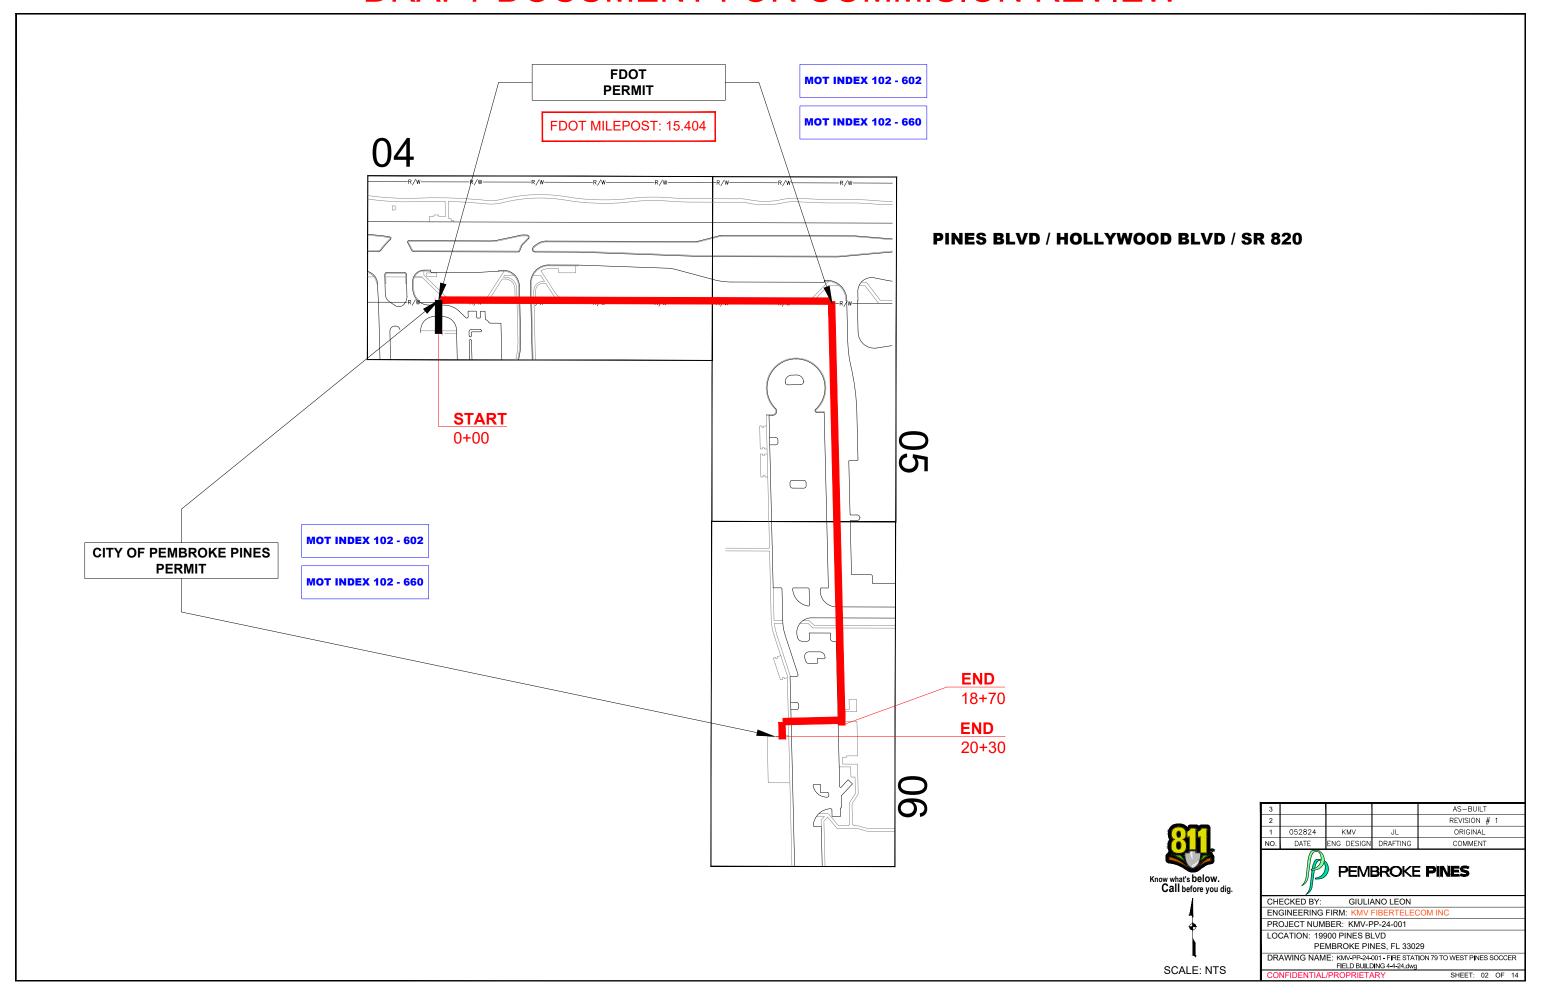TYPICAL UNDERGROUND CONSTRUCTION:

- RESTORE ALL SURFACES TO EQUAL OR BETTER CONDITION.
- CONTRACTOR TO VERIFY ALL MEASUREMENTS AND DISTANCES PRIOR TO CONSTRUCTION
- CONTRACTOR TO VERIFY LOCATION AND CONDITION OF EXISTING CONDUIT PRIOR TO CONSTRUCTION.
- CONTRACTOR SHALL VERIFY ALL PLANS, EXISTING DIMENSIONS AND CONDITIONS ON THE JOB SITE AND IMMEDIATELY NOTIFY THE ENGINEER IN
 WRITING OF ANY DISCREPANCIES BEFORE PROCEEDING WITH THE WORK.
- MAINTAIN A MIN BENDING RADIUS OF 5' ON ALL DUCT CONFIGURATION.
- ANY CHANGES ON PROPOSED RUNNING LINE HAVE TO GET APPROVAL FROM BLUE STREAM CONSTRUCTION MANAGER

FOR CONSTRUCTION:

- EXTREME CAUTION TO BE TAKEN TO CONTAIN SLURRY AROUND WORK AREAS NEAR WETLANDS TO AVOID ANY WATER QUALITY ISSUES!
- LOCATIONS, ELEVATIONS LOCATIONS, ELEVATIONS AND DIMENSIONS OF EXISTING UTILITIES, STRUCTURES AND OTHER SITE FEATURES SHOWN ON THE DRAWINGS ARE BASED ON LIMITED INVESTIGATION TECHNIQUES AND SHOULD BE CONSIDERED APPROXIMATE ONLY. PLEASE CONTACT SUNSHINE STATE ONE-CALL AT 1-800-432-4770
- CAUTION: EXISTING UNDERGROUND UTILITIES IN AREA. NO ELEVATION RECORDS FOR EXISTING UTILITIES AVAILABLE. CONTRACTOR SHOULD CONTACT SUNSHINE 811, LOCATE ALL UTILITIES AND VERIFY ALL DEPTHS PRIOR TO CONSTRUCTION

CITY OF PEMBROKE PINES GENERAL NOTES

- THE CITY OF PEMBROKE PINES ASSUMES NO RESPONSIBILITY OR LIABILITY FOR THE LOCATIONS AND ELEVATIONS OF CITY UTILITIES AS REFLECTED ON THE DRAWINGS BASED UPON INFORMATION PROVIDED FROM CITY RECORDS NOR DOES THE CITY GUARANTEE THE COMPLETENESS OF THE CITY UTILITIES INFORMATION AS PROVIDED FROM CITY RECORDS. IT IS THE RESPONSIBILITY OF THE CONTRACTOR AND UTILITY OWNER TO FIELD LOCATE AND FIELD VERIFY ALL EXISTING UTILITIES IN THE WORK AREA FOR THE ENTIRE LIMITS OF THE PROJECT.
- A MINIMUM OF 7.5" OF HORIZONTAL SEPARATION AND A MINIMUM OF 18" OF VERTICAL SEPARATION SHALL BE MAINTAINED TO ALL CITY OF PEMBROKE PINES UTILITIES, UNLESS OTHERWISE APPROVED BY THE CITY ENGINEER.
- ALL CROSSINGS OF THE PROPOSED DIRECTIONAL BORE AND OPEN TRENCH INSTALLATION WITH CITY UTILITIES SHALL
 BE VERIFIED FOR CONFIRMATION OF MINIMUM VERTICAL SEPARATION REQUIREMENTS BY WAY OF "SOFT DIG"
 METHODS PRIOR TO THE START OF CONSTRUCTION.
- CONTRACTOR SHALL CALL "SUNSHINE ONE" AT 1-800-432-4770 OR 811 A MINIMUM OF 72 HOURS PRIOR TO THE START OF CONSTRUCTION TO ALLOW FOR "FIELD LOCATES" OF ALL EXISTING UTILITIES WITHIN THE PROJECT LIMITS.
- ALL STREET, SIDEWALK AND SWALE (SOD) RESTORATION SHALL COMPLY WITH CITY STANDARDS AND/OR SPECIFICATIONS, UNLESS THE STANDARDS AND/OR SPECIFICATIONS OF ANOTHER PERMITTING GOVERNMENTAL AGENCY SUPPERCEDES THOSE OF THE CITY.
- A M.O.T. PLAN PREPARED BY A F.D.O.T. CERTIFIED M.O.T. ENGINEER SHALL BE SUBMITTED FOR CONSTRUCTION PERMIT BASED UPON THE SCOPE OF THE PROPOSED PROJECT AND EXISTING ROADWAY/STREET CONDITIONS.
- A PRECONSTRUCTION MEETING IS REQUIRED TO BE HELD WITH THE ENVIRONMENTAL SERVICES/ENGINEERING DIVISION AS A PREREQUISITE TO THE CITY'S RELEASE OF THE CONSTRUCTION PERMIT.
- MAINTENANCE OF TRAFFIC (M.O.T.) SHALL BE PROVIDED BY A F.D.O.T. CERTIFIED M.O.T. CONTRACTOR

DESIGN TICKET

FDOT GENERAL NOTES:

- EXISTING F.D.O.T. DRAINAGE SYSTEM SHALL BE PROTECTED AT ALL TIMES BY THE PERMITTEE. ANY DAMAGE TO THE F.D.O.T. DRAINAGE SYSTEM (STRUCTURES OR PIPES) SHALL BE REPAIRED/REPLACED BY THE PERMITTEE AT NO COST TO THE DEPARTMENT.
- EXISTING GAS MAIN SHALL BE PROTECTED AT ALL TIMES DURING EXCAVATION, DRILLING AND CONDUIT INSTALLATION ACTIVITIES. UTILITY GAS
 COMPANY SHALL BE PRESENT AT THE PRE-CONSTRUCTION MEETING AND GIVE WRITTEN CLEARANCE PRIOR TO COMMENCEMENT OF ANY PERMIT
 OPERATIONS
- ANY DAMAGE TO CONCRETE SIDEWALK, CURB AND GUTTER, PEDESTRIAN CURB RAMPS, AND TRAFFIC SEPARATORS SHOULD BE RESTORED PER FDOT STANDARDS PLANS INDEX NO. 522-001, 520-001, 522-002, AND 520-020, ADA STANDARDS, AND FDOT STANDARD SPECIFICATION 522. DAMAGED SIDEWALK, CURB AND GUTTER, AND TRAFFIC SEPARATORS SHALL BE RESTORED WITH FULL FLAGS/JOINT TO JOINT AT THE PERMITTEES EXPENSE; PATCHING IS NOT PERMITTED. IMPACTED PEDESTRIAN RAMPS SHALL BE REPLACED COMPLETELY; HANDHOLES MUST NOT BE LOCATED WITHIN PEDESTRIAN RAMPS. MAKE SURE TO FURNISH APPROPRIATE EXPANSION JOINTS PER FDOT STANDARDS PLANS INDEX 350-001. IMPACTED DETECTABLE WARNING SURFACES NEED TO BE RESTORED IN ACCORDANCE WITH FDOT STANDARD PLANS INDEX NO. 522-002 AND SPECIFICATION 527.
- WHERE PEDESTRIAN FACILITIES ARE DETOURED, BLOCKED, OR CLOSED DURING THE WORK, PLEASE ENSURE TO PROVIDE SAFE ALTERNATE
 ACCESSIBLE ROUTES THROUGH OR AROUND THE WORK ZONE THAT MEETS THE REQUIREMENTS OF THE ADA STANDARDS AND FDOT STANDARD
 PLAN INDEX 102-660.
- RESTORATION OF SODDING AND TURF SHOULD BE DONE ACCORDING TO FDOT 2023-2024 STANDARD INDEX No 570-001.
- PROVIDE PROTECTION TO THE EXISTING TREES AND AVOID ANY IMPACT TO THE ROOTS. WHEN CONSTRUCTION AFFECTS TREE ROOTS
 OR CANOPY, PROVIDE TRIMMING PER FDOT STANDARD PLANS INDEX 110-100.
- PROVIDE APPROPRIATE EROSION CONTROL DEVICES DURING CONSTRUCTION.
- LANDSCAPING, TREES, SOD SHALL BE REPLACED AT THE COST OF THE PERMITTEE
- THE CONTRACTOR SHALL COORDINATE WITH BROWARD COUNTY DEPARTMENT OF TRANSPORTATION AND PUBLIC WORKS (DTPW), TRAFFIC SIGNALS & SIGNS DIVISION AT LEAST 5 WORKING DAYS PRIOR TO ANY WORK DONE AT SIGNALIZED INTERSECTIONS, WHICH EITHER CLOSE ANY LANES, NEED CHANGES IN THE SIGNAL OPERATION OF TIMING, DAMAGE OR HINDER ANY SIGNAL SENSOR, OR DAMAGE ANY CABLE OR SIGNAL EQUIPMENT.
- PERMITTEE IS RESPONSIBLE FOR LOCATING ALL UNDERGROUND FACILITIES PRIOR TO DIRECTIONAL DRILLING/TRENCH WORK AND
 ASSUMES ALL RESPONSIBILITY FOR ANY DAMAGE DONE TO UNDERGROUND FACILITIES AND ABOVE GROUND FACILITIES. DIRECTIONAL
 BORING SHALL BE CONDUCTED ACCORDING TO LATEST SECTION 555 OF FDOT'S STANDARD SPECIFICATIONS AND 3.16.9.1 OF THE 2017
 U.A.M. OPEN TRENCH SHALL BE CARRIED OUT PER 3.16.4. OF 2017 U.A.M
- CONDUIT INSTALLATION SHALL ADHERE TO THE LATEST FDOT STANDARD PLANS INDEX NO. 630-001
- ACCORDING TO SECTION 3.10 OF 2017 U.A.M, WHEN UNDERGROUND AND AERIAL UTILITIES OCCUPY THE SAME ROADSIDE, UNDERGROUND UTILITIES SHALL NOT BE PLACED WITHIN THREE (3) FEET OF THE RW LINE.
- DAMAGED SIDEWALK, CURB AND GUTTER, AND TRAFFIC SEPARATORS SHALL BE RESTORED WITH FULL FLAGS/JOINT TO JOINT AT THE PERMITTEES EXPENSE; PATCHING IS NOT PERMITTED. RESTORATION SHALL MATCH EXISTING CONCRETE PATTERN, PAVERS, AND COLOR. IMPACTED PEDESTRIAN RAMPS AND DRIVEWAYS SHALL BE REPLACED COMPLETELY. INCLUDE 1 FOOT OF LEVEL EMBANKMENT FOR EROSION AND ENSURE TO NOT CREATE ANY DROP OFF HAZARDS AS SHOWN ON FDM FIGURE 222.4.1. IMPACTED DETECTABLE WARNING SURFACES NEED TO BE RESTORED IN ACCORDANCE WITH FDOT STANDARD PLANS INDEX NO. 522-002 AND SPECIFICATION 527
- PROPOSED HANDHOLES MUST ADHERE TO LATEST FDOT STANDARD PLANS INDEX NO. 635-001". ENSURE ALL HANDHOLE LIDS ON SIDEWALK ARE FLUSH AND ADA COMPLIANT. MAINTAIN THE TEMPORARY PATCHES AROUND THE HANDHOLE BOX EDGES AND/OR ANYWHERE ELSE WHERE SIDEWALK HAS BEEN IMPACTED/DAMAGED BY THE DB WORK OR UTILITY INSTALLATION, SO IT PROVIDES A SMOOTH -ALL WEATHER SURFACES ALWAYS. ONCE THE HANDHOLE IS INSTALLED THE LID MUST BE KEPT IN PLACE, BOLTED, AND SECURED.
- TEMPORARY BARRIERS FOR PEDESTRIAN DETOURS MUST COMPLY WITH THE LATEST FDOT STANDARD PLANS INDEX NO. 102-100.
- RESTORATION OF SODDING AND TURF SHOULD BE DONE ACCORDING TO FDOT 2023-24 DESIGN STANDARDS INDEX 570-010.
- PERMITTEE MUST TAKE PICTURES OF THE EXISTING STREET LIGHTNING SYSTEM WORKING-DURING NIGHT-TIME-WITHIN THE LIMITS OF
 THIS PROPOSED JOB PRIOR TO BEGIN SAID WORK. TO AVOID FUTURE DISPUTE ABOUT UNFORESEEN DAMAGES TO THE LIGHTNING
 SYSTEM.
- CONTAMINATED SITES LOCATED WITHIN A 500-FOOT RADIUS OF THE PROJECT AREA THAT COULD IMPACT THE FDOT ROW HAVE BEEN
 IDENTIFIED. THE PERMITTEE SHALL ASSURE THAT ANY ACTIONS CARRIED OUT ARE IN ACCORDANCE WITH ALL ENVIRONMENTAL
 REGULATORY REQUIREMENTS.
- ANY ABOVEGROUND FEATURES THAT MAY BE IMPACTED BY PROPOSED WORK MUST BE IDENTIFIED TO BE
 ADJUSTED/RELOCATED/REPLACED. IF SIGNS ADD ARE DAMAGED, THESE MUST BE REPLACED ACCORDING THE LATEST FDOT STANDARD
 PLANS INDEX NO. 700-101. ENSURE LATERAL OFFSET AND CLEAR ZONE STANDARDS ARE BEING A DHERED TO.

3				AS-BUILT
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NO.	DATE	ENG DESIGN	DRAFTING	COMMENT
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CHECKED BY: GIULIANO LEON
ENGINEERING FIRM: KMV FIBERTELEO


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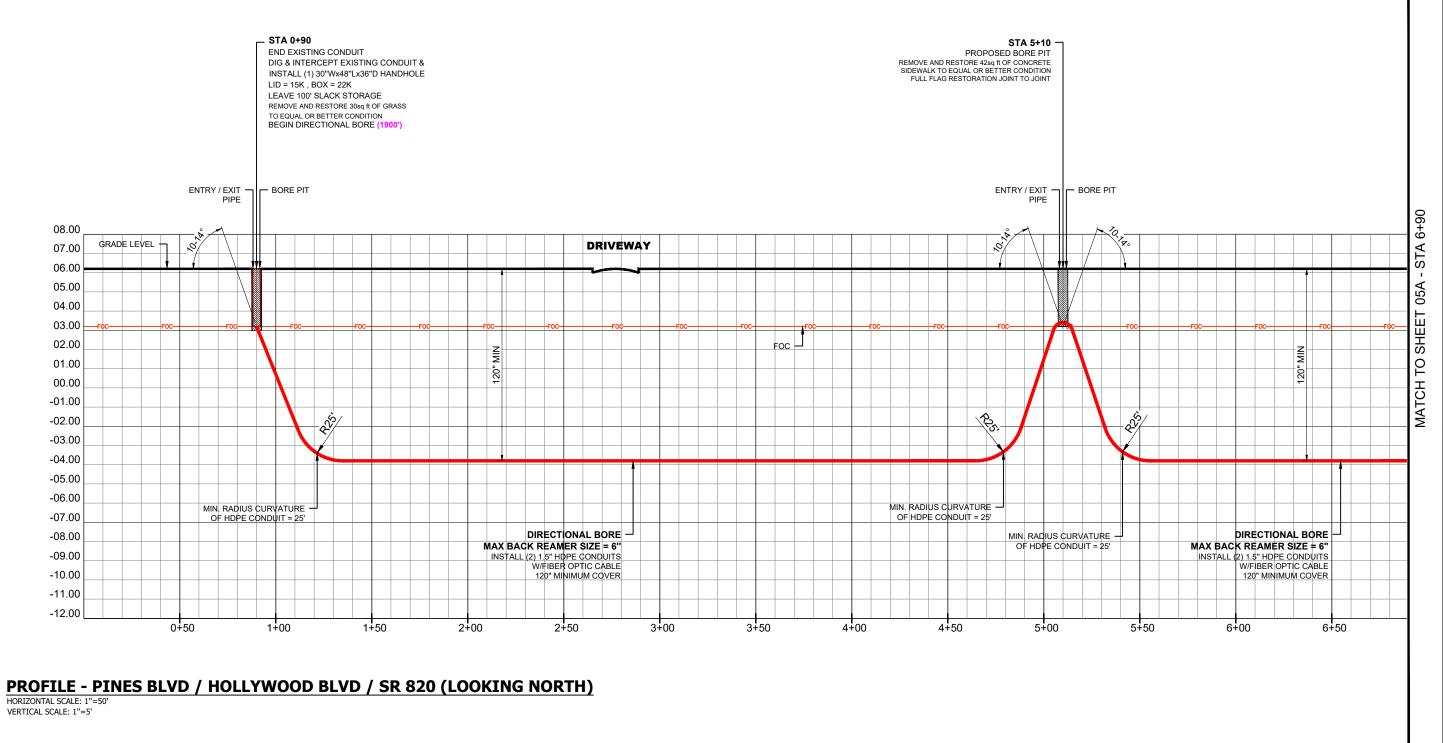
PEMBROKE PINES, FL 33029

DRAWING NAME: KMV-PP-24-001 - FIRE STATION 79 TO WEST PINES SOCCER

FIELD BUILDING 4-4-24.dwg

SHEET: 03 OF 14



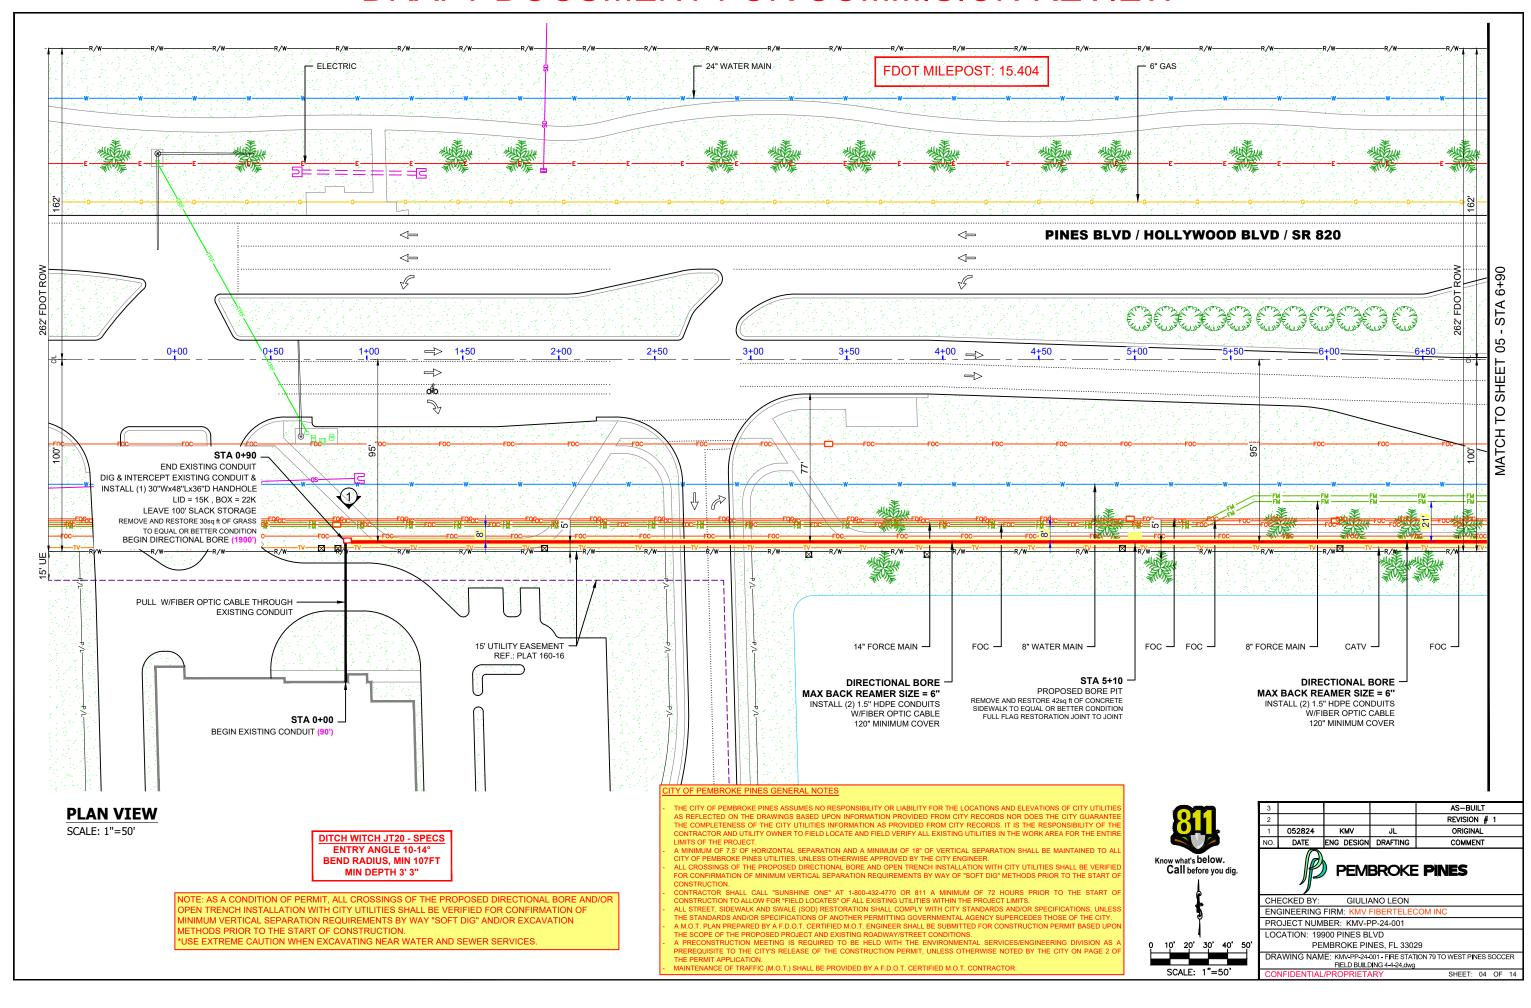

RECORD ON UTILITY PLANS CONSTRUCTION CONTRACTOR SHALL CALL LOCATES AND SOFT DIG TO DETERMINE UTILITY ELEVATION BEFORE CONSTRUCTION.

ENTRY ANGLE 10-14° **BEND RADIUS, MIN 107FT** MIN DEPTH 3' 3"



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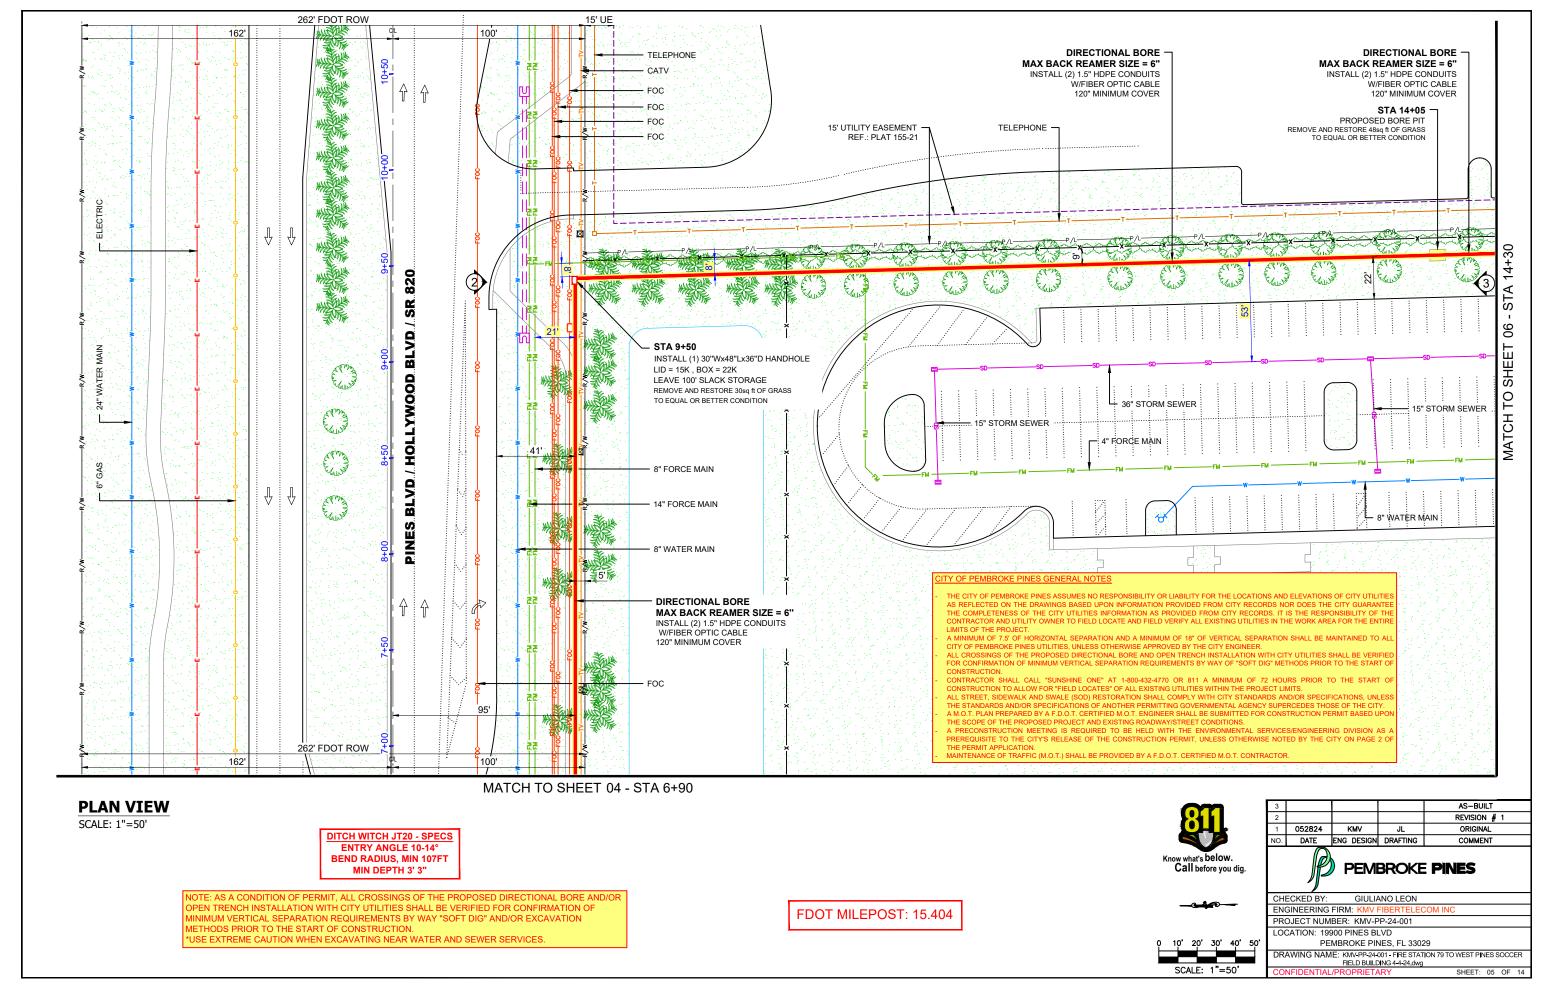
GIULIANO LEON ENGINEERING FIRM: K


PROJECT NUMBER: KMV-PP-24-001

LOCATION: 19900 PINES BLVD PEMBROKE PINES, FL 33029 DRAWING NAME: KMV-PP-24-001 - FIRE STATION 79 TO WEST PINES SOCCER

FIELD BUILDING 4-4-24 dwg

SHEET: 04A OF 14



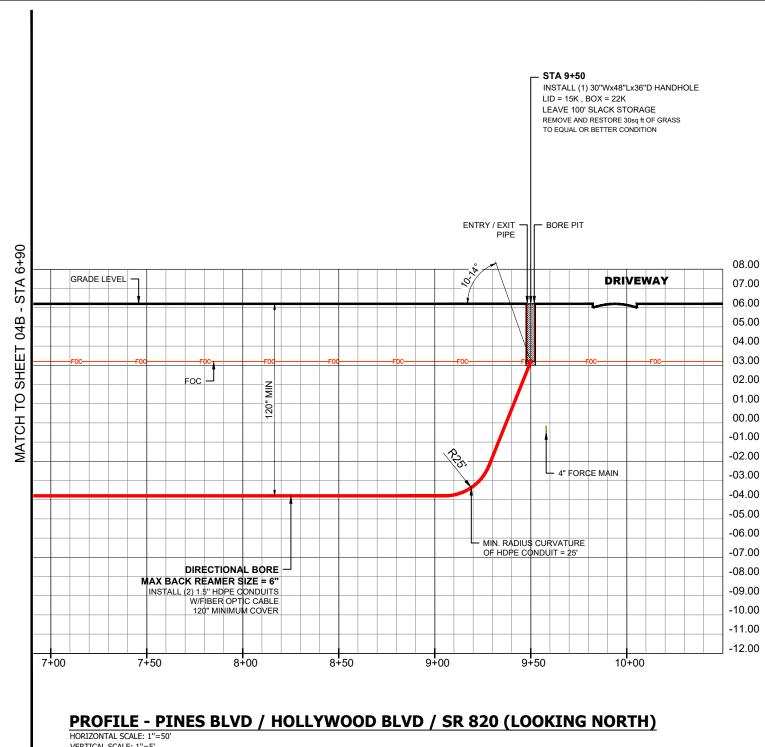


VERTICAL SCALE: 1"=5'

RECORD ON UTILITY PLANS CONSTRUCTION CONTRACTOR SHALL CALL LOCATES AND SOFT DIG TO DETERMINE UTILITY ELEVATION BEFORE CONSTRUCTION.

ENTRY ANGLE 10-14° **BEND RADIUS, MIN 107FT** MIN DEPTH 3' 3"



3				AS-BUILT		
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NO.	DATE	ENG DESIGN	DRAFTING	COMMENT		

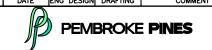

GIULIANO LEON


ENGINEERING FIRM: KI PROJECT NUMBER: KMV-PP-24-001

LOCATION: 19900 PINES BLVD PEMBROKE PINES, FL 33029

DRAWING NAME: KMV-PP-24-001 - FIRE STATION 79 TO WEST PINES SOCCER

FIELD BUILDING 4-4-24.dwg

SHEET: 05A OF 14

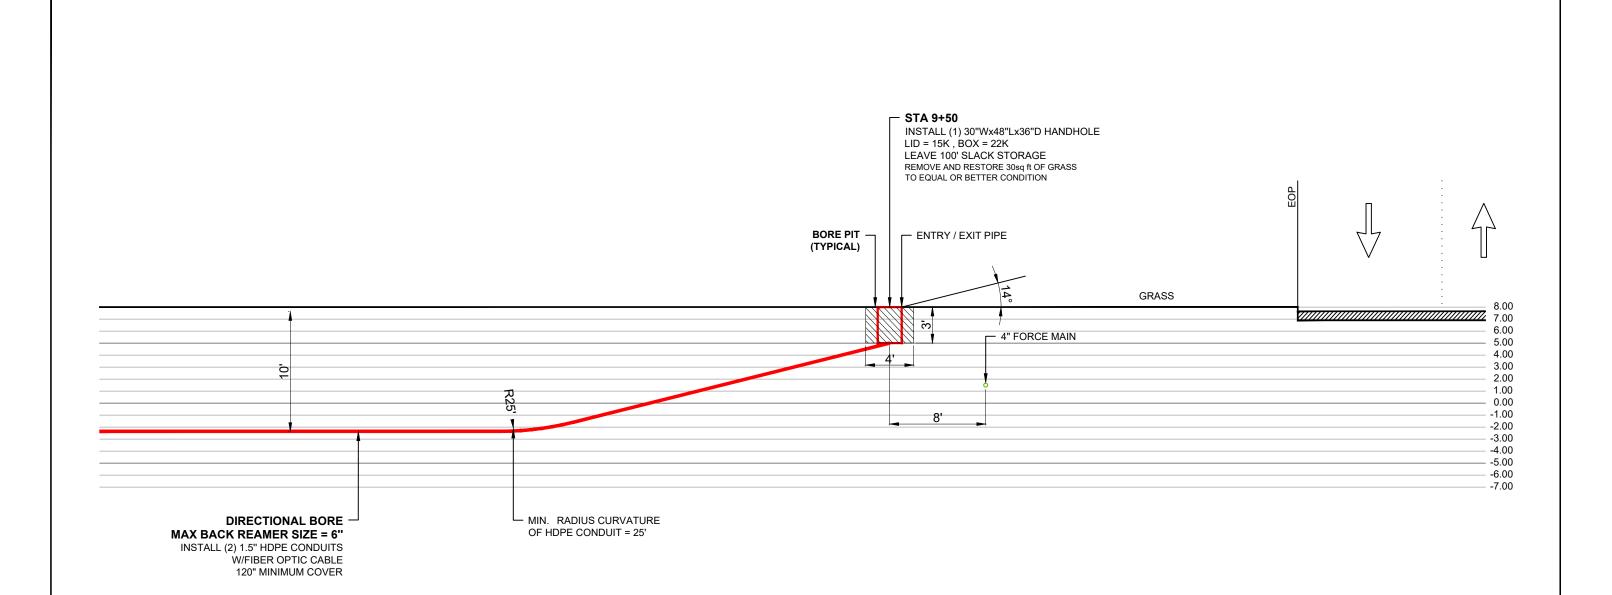

PROFILE - PINES BLVD / HOLLYWOOD BLVD / SR 820 (LOOKING NORTH)


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RECORD ON UTILITY PLANS CONSTRUCTION CONTRACTOR SHALL CALL LOCATES AND SOFT DIG TO DETERMINE UTILITY ELEVATION BEFORE CONSTRUCTION.

ENTRY ANGLE 10-14° **BEND RADIUS, MIN 107FT** MIN DEPTH 3' 3"



3				AS-BUILT
2				REVISION # 1
1	052824	KMV	JL	ORIGINAL
NO.	DATE	ENG DESIGN	DRAFTING	COMMENT

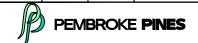


ENGINEERING FIRM: KN

PROJECT NUMBER: KMV-PP-24-001 LOCATION: 19900 PINES BLVD

PEMBROKE PINES, FL 33029 DRAWING NAME: KMV-PP-24-001 - FIRE STATION 79 TO WEST PINES SOCCER FIELD BUILDING 4-4-24.dwg

SHEET: 05B OF 14

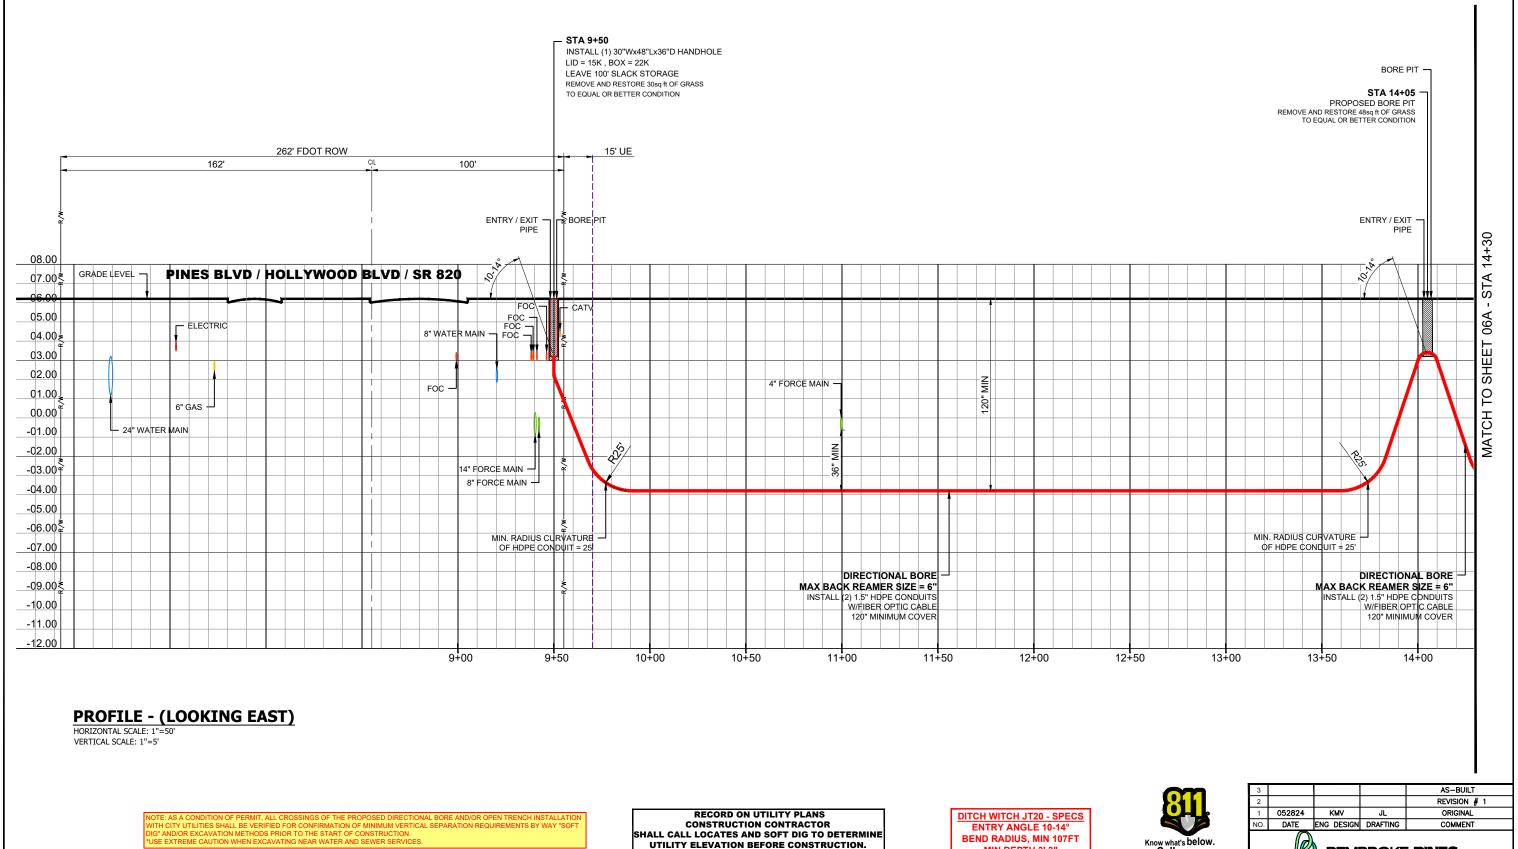

MIN DEPTH 3' 3"







GIULIANO LEON ENGINEERING FIRM: K PROJECT NUMBER: KMV-PP-24-001

LOCATION: 19900 PINES BLVD PEMBROKE PINES EL 33029

DRAWING NAME: KMV-PP-24-001 - FIRE STATION 79 TO WEST PINES SOCCER FIELD BUILDING 4-4-24 dwg

SHEET: 05C OF 14

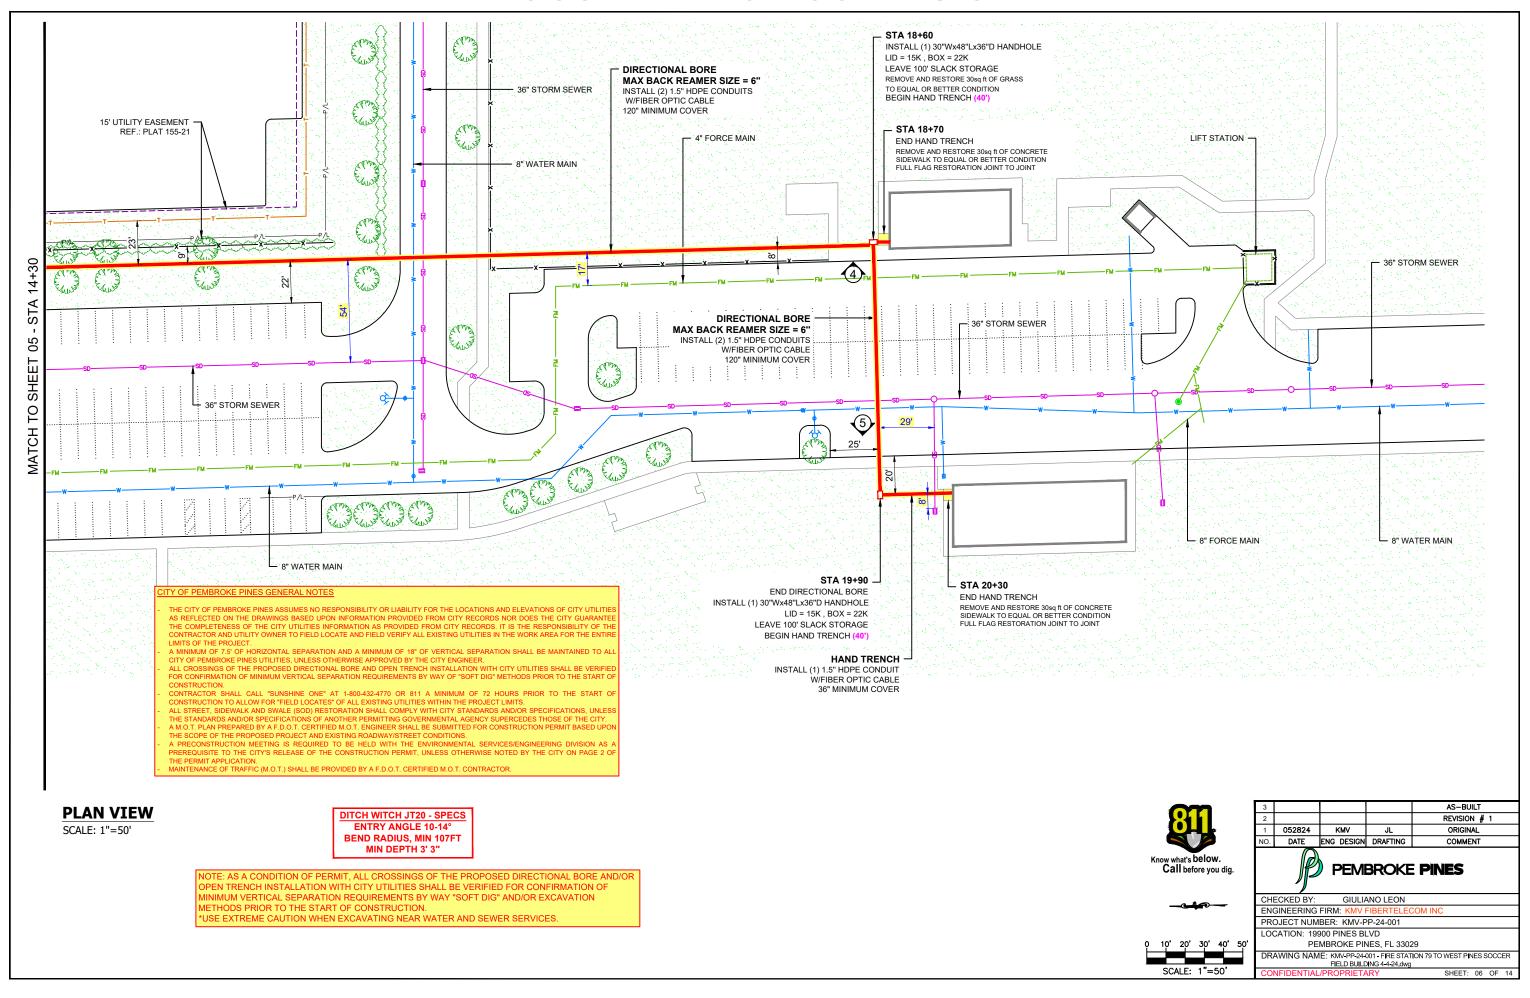

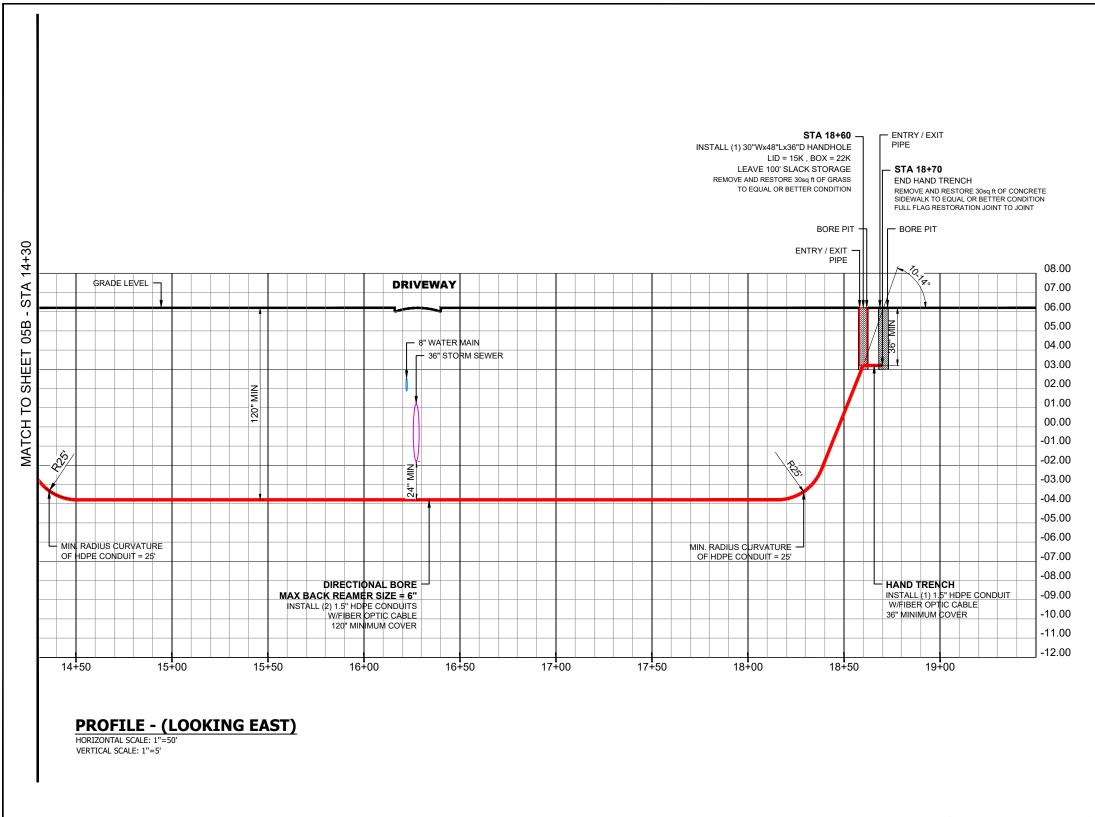


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ENTRY ANGLE 10-14° **BEND RADIUS, MIN 107FT** MIN DEPTH 3' 3"



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NO.	DATE	ENG DESIGN	DRAFTING	COMMENT
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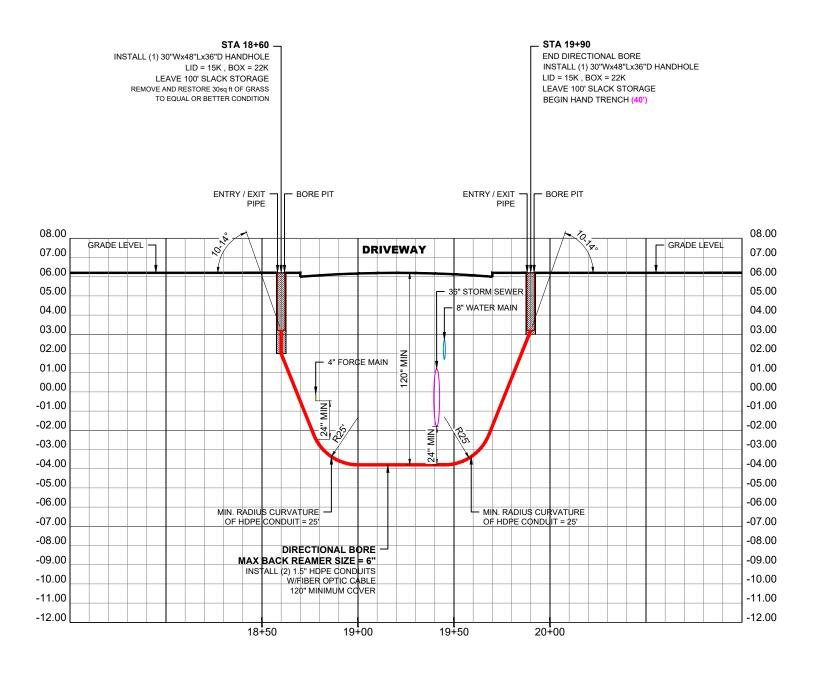
GIULIANO LEON

ENGINEERING FIRM: KI PROJECT NUMBER: KMV-PP-24-001

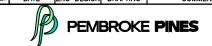LOCATION: 19900 PINES BLVD PEMBROKE PINES, FL 33029

DRAWING NAME: KMV-PP-24-001 - FIRE STATION 79 TO WEST PINES SOCCER FIELD BUILDING 4-4-24.dwg

SHEET: 06A OF 14



PROFILE - (LOOKING SOUTH)


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RECORD ON UTILITY PLANS CONSTRUCTION CONTRACTOR SHALL CALL LOCATES AND SOFT DIG TO DETERMINE UTILITY ELEVATION BEFORE CONSTRUCTION.

ENTRY ANGLE 10-14° **BEND RADIUS, MIN 107FT** MIN DEPTH 3' 3"



3				AS-BUILT			
2				REVISION # 1			
1	052824	KMV	JL	ORIGINAL			
NO.	DATE	ENG DESIGN	DRAFTING	COMMENT			

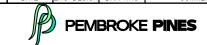


GIULIANO LEON

ENGINEERING FIRM: K PROJECT NUMBER: KMV-PP-24-001

LOCATION: 19900 PINES BLVD PEMBROKE PINES, FL 33029

DRAWING NAME: KMV-PP-24-001 - FIRE STATION 79 TO WEST PINES SOCCER FIELD BUILDING 4-4-24.dwg

SHEET: 06B OF 14

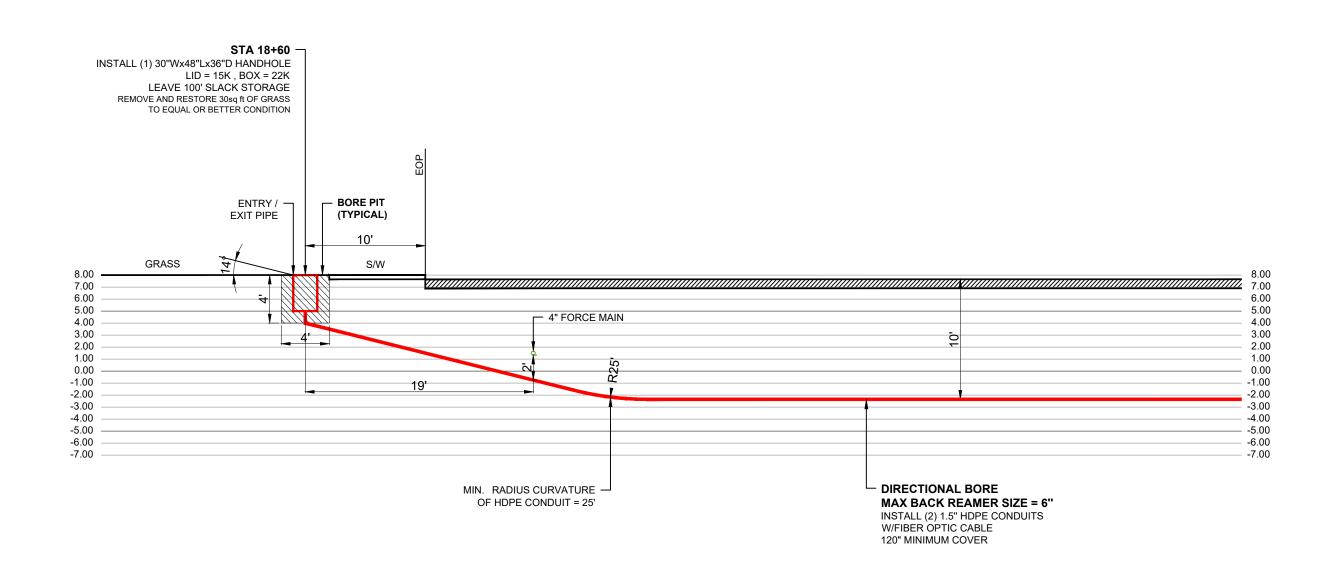

PROFILE - (LOOKING SOUTH)


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RECORD ON UTILITY PLANS CONSTRUCTION CONTRACTOR SHALL CALL LOCATES AND SOFT DIG TO DETERMINE UTILITY ELEVATION BEFORE CONSTRUCTION.

DITCH WITCH JT20 - SPECS ENTRY ANGLE 10-14° BEND RADIUS, MIN 107FT MIN DEPTH 3' 3"



	3				AS-BUILT		
	2				REVISION # 1		
	1	052824	KMV	JL	ORIGINAL		
	NO.	DATE	ENG DESIGN	DRAFTING	COMMENT		
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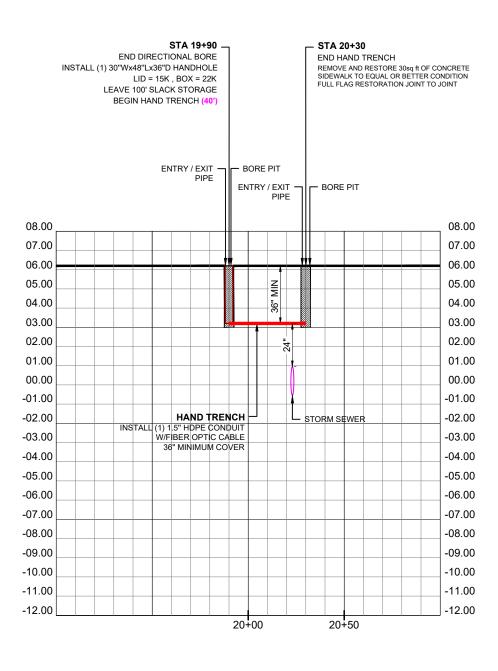


ENGINEERING FIRM: KI PROJECT NUMBER: KMV-PP-24-001

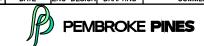LOCATION: 19900 PINES BLVD PEMBROKE PINES, FL 33029

DRAWING NAME: KMV-PP-24-001 - FIRE STATION 79 TO WEST PINES SOCCER FIELD BUILDING 4-4-24.dwg

SHEET: 06C OF 14



PROFILE - (LOOKING EAST)


HORIZONTAL SCALE: 1"=50" VERTICAL SCALE: 1"=5'

RECORD ON UTILITY PLANS CONSTRUCTION CONTRACTOR SHALL CALL LOCATES AND SOFT DIG TO DETERMINE UTILITY ELEVATION BEFORE CONSTRUCTION.

ENTRY ANGLE 10-14° **BEND RADIUS, MIN 107FT** MIN DEPTH 3' 3"



3				AS-BUILT		
2				REVISION # 1		
1	052824	KMV	JL	ORIGINAL		
NO.	DATE	ENG DESIGN	DRAFTING	COMMENT		

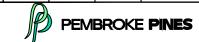


GIULIANO LEON

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SHEET: 06D OF 14



PROFILE - (LOOKING EAST)


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ENTRY ANGLE 10-14° **BEND RADIUS, MIN 107FT** MIN DEPTH 3' 3"

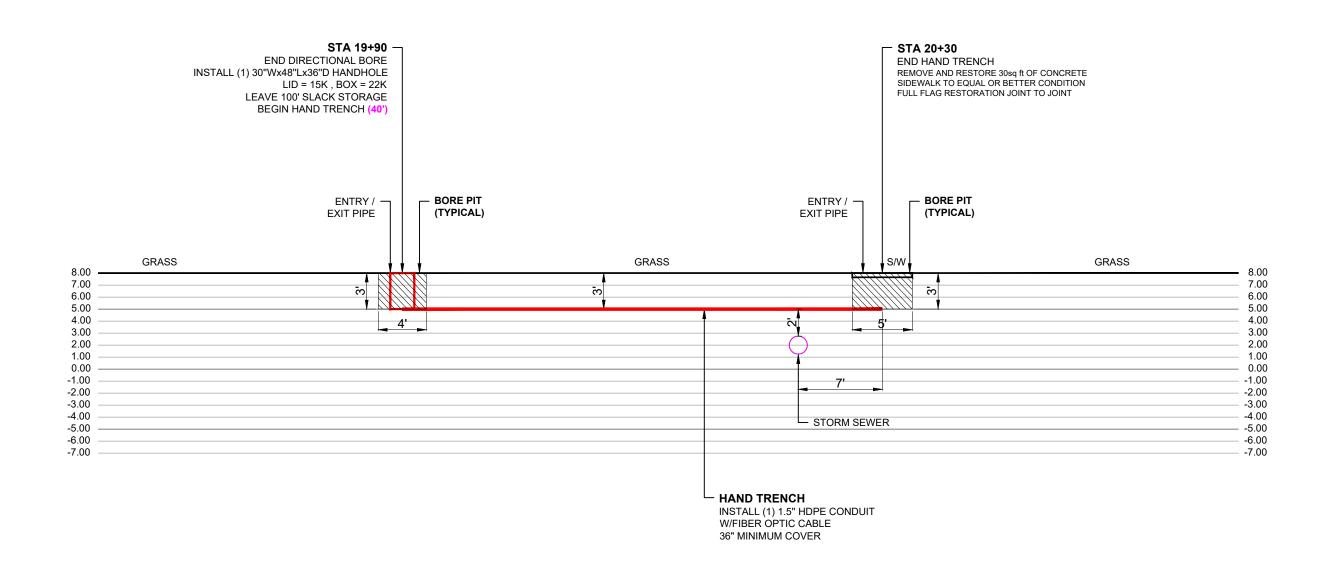

3	3			AS-BUILT
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ENGINEERING FIRM: K

PROJECT NUMBER: KMV-PP-24-001

LOCATION: 19900 PINES BLVD PEMBROKE PINES, FL 33029
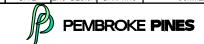
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SHEET: 06E OF 14

PHOTOGRAPHS

STA 0+90

END EXISTING CONDUIT DIG & INTERCEPT EXISTING CONDUIT & INSTALL (1) 30"Wx48"Lx36"D HANDHOLE LID = 15K , BOX = 22K LEAVE 100' SLACK STORAGE REMOVE AND RESTORE 30sq ft OF GRASS TO EQUAL OR BETTER CONDITION BEGIN DIRECTIONAL BORE (1900')



STA 0+90 INSTALL PEMBROKE PINES HANDHOLE

INSTALL (1) 30"Wx48"Lx36"D HANDHOLE LID = 15K , BOX = 22K LEAVE 100' SLACK STORAGE REMOVE AND RESTORE 30sq ft OF GRASS TO EQUAL OR BETTER CONDITION



STA 9+50 INSTALL PEMBROKE PINES HANDHOLE



INSTALL (1) 30"Wx48"Lx36"D HANDHOLE
LID = 15K, BOX = 22K
LEAVE 100' SLACK STORAGE
REMOVE AND RESTORE 30sq ft OF GRASS TO EQUAL OR BETTER CONDITION



STA 18+60 INSTALL PEMPROKE PINES HANDHOLE





STA 19+90 _

END DIRECTIONAL BORE INSTALL (1) 30"Wx48"Lx36"D HANDHOLE LID = 15K , BOX = 22K LEAVE 100' SLACK STORAGE BEGIN HAND TRENCH (40')



STA 20+50 INSTALL PEMBROKE PINES HANDHOLE



3				AS-BUILT			
2				REVISION # 1			
1	052824	KMV	JL	ORIGINAL			
NO.	DATE	ENG DESIGN	DRAFTING	COMMENT			
	PEMBROKE PINES						

PROJECT NUMBER: KMV-PP-24-001


LOCATION: 19900 PINES BLVD PEMBROKE PINES, FL 33029

DRAWING NAME: KMV-PP-24-001 - FIRE STATION 79 TO WEST PINES SOCCEP FIELD BUILDING 4-4-24.dwg

STA 14+05 PROPOSED BORE PIT


STA 14+05 -

PROPOSED BORE PIT REMOVE AND RESTORE 48sq ft OF GRASS TO EQUAL OR BETTER CONDITION

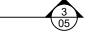

TYPICAL


BORE PIT RESTORATION DETAIL

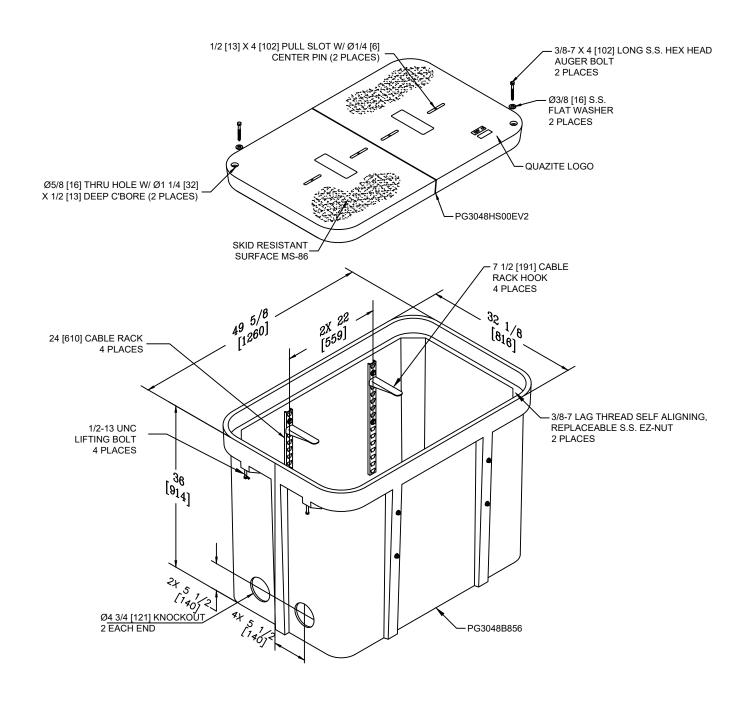

TYPICAL DETAIL - # 2

QUAZITE 30X48X36 ASSEMBLY
W/(4) 24" CABLE RACKS
& (4) 7 1/2" HOOKS
TIER 22 (15K DESIGN LOAD/ 22.5 TEST LOAD)

PG3048Z987EV2

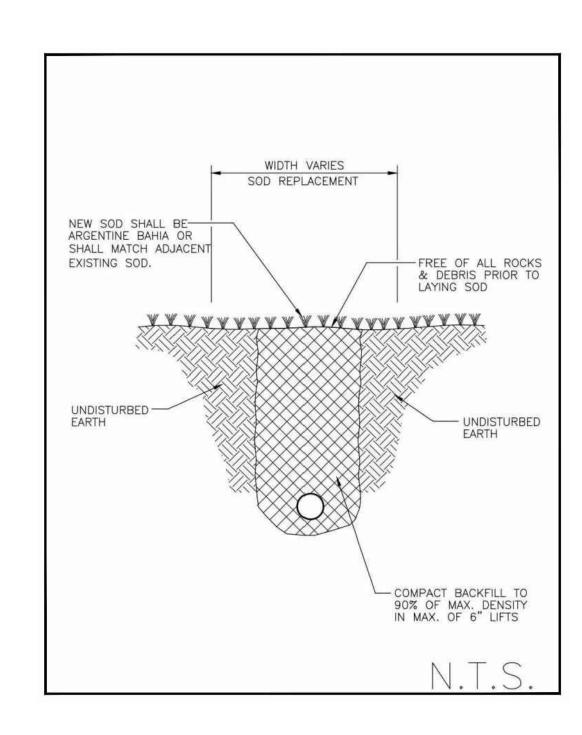

3				AS-BUILT
2				REVISION # 1
1	052824	KMV	JL	ORIGINAL
NO.	DATE	ENG DESIGN	DRAFTING	COMMENT
CHI	ECKED BY:	,	ANO LEON	PINES
		FIRM: KMV F		COM INC
ENG	SINEERING		IBERTELEC	COM INC
ENG	GINEERING DJECT NUM CATION: 199	FIRM: KMV	P-24-001 VD	
PRO	GINEERING DJECT NUM CATION: 199 PE	FIRM: KMV F BER: KMV-P 900 PINES BI MBROKE PIN IE: KMV-PP-24-	P-24-001 LVD NES, FL 3302	

JR20 DIRECTIONAL DRILL SPECIFICATIONS

JT20 DIRECTIONAL

OPERATION	U.S.	METRIC	DIMENSIONS	U.S.	METR
Spindle speed, max	210 rom		Length	207 in	5.26 m
Spindle torque, max	2,200 ft lb	2980 N m	Width	51.5 in	1.31 m
Carriage thrust travel speed	140 fpm	43 m/mm	Height	90 in	2.29 m
Carriage thrust pullback travel speed	140 fpm	43 m/min	Weight w/pipe	11,890 lb	5390 kg
Thrust force	17,000 (b	75.6 kN	Entry angle	10-14°	
Pullbackforco	20,000 tb	89 KN	Angle of approach	189	
Bore diameter	4 in	102 mm	Angle of departure	18*	
Ground travel speed			DRILLING FLUID SYST	EM (ONBO	ARDI
Forwars/reverse	3.2 mph	5.2 km/h	Pressure max	1,000 psi	69 bar
OWER (TIER 4) (HRC)			Flow, max	35 g pm	132.U/min
Engine	Deutz® TD2,9L4		FLUID CAPACITIES		
Fuel	Dieset		Hydraulic reservoir	19 gat	72L
Cooling medium	Liquid		Fueltank	30 gal	114 L
Injection	Direct		Engine oil w/filter	8.5 qt	81
Aspiration	Turbocharges		Engine cooling system	4.6 gal	17 L
Number of cylinders	4		POWER PIPE® HD		
Displacement	12.7 tn ^a	2.9 L	Length of drill pipe_nominal	120 in	3.05 m
Bore	3.62 in	92 mm	Diameter of drill pipe, tool loint end	2.63 m	66.8 mm
Stroke	4.33 in	-110 mm	Diameter of drill pipe	2.06 in	52,3 mm
Manufacturer's gross power rating	74 hp	55 KW	Bend radius, min	107 ft	32 m
Rated speed	2,600 rpm		Weight of drittipipe, lined	67 tb	30,4 kg
Emissions compliance	EPATier4	EU Stage IIIB	POWER PIPE FORGED H	D	
OWER (TIER 41) (LRC)			Length	120 in	3.05 m
Engine	Deutz TO 2 91.4		Diamoter of drill pipe, tool joint end	2.5 in	63.5 mm
Fuel	Diesel		Diameter of drill pipe	2.10 in	53.3 mm
Cooling medium	Liquid		Bend racius, min	10.9 ft	33.2 m
Injection	Direct		POWER PIPE FORGED	HDX	
Aspiration	Turbocharged		Length	120 in	3.05 m
Number of cylinders	4		Diameter of tool joint	2,63 m	66.8 mm
Displacement	17.7 in ^a	29 L	Diameter of drill pipe	2.38 in	60.5 mm
Bore	3,62 іп	92 mm	Bend radius, min	123 ft	37.5 m
Stroke	4,39 in	110 mm	BATTERY		
Manufacturer's gross power rating	74 hp	55 KW	SAE reserve capacity rating	195 min	
Rated speed	2,600 rpm		SAE cold crank rating (a 6°F (-18°C)	950 a mps	
Emissions compliance	EPA Lier 4)	EU Stago III A	Specifications are general and subject to the required, equipment should be weighed and equipment may not necessarily match that s	ange without notice. I measured, Due to se	

IMENSIONS	U.S.	METRIC
Length	207 in	5.28 m
Width	51.5 in	1.31 m
Height	90 in	2.29 m
Weight w/pipe	11,890 lb	5390 kg
Entry angle	10-14°	
Angle of approach	189	
Angle of departure	18*	
RILLING FLUID SYST	EM (ONBO	(RD)
Pressure, max	1,000 pri	69 bar
Flow, max	35 g pm	132 Umis
LUID CAPACITIES		
Hydraulic reservoir	19 gat	72L
Fueltank	30 gal	114 L
Engine oil w/filter	8.5 qt	8 L
Engine cooling system	4.6 gal	12 L
OWER PIPE® HD		
Length of drill pipe, nominal	120 in	3.05 m
Diameter of drill pipe, tool joint end	2.63 m	66.8 mm
Diameter of drill pipe	2.06 in	52,3 mm
Bend radius, min	107 ft	32 m
Weight of dritt pipe, lines	67 tb	30,4 kg
OWER PIPE FORGED H		
Length	120 in	3.05 m
Diameter of drill pipe, tool joint end	2.5 in	63.5 mm
Diameter of drill pipe	2.10 in	53.3 mm
Bend radius, min	109 ft	33.2 m
OWER PIPE FORGED	HDX	
Length	120 in	3.05 m
Diameter of tool joint	2,63 in	66.8 mm
Diameter of drill pipe	2.38 in	60.5 mm
Bend radius, min	128 ft.	37.5 m
ATTERY		
ATTERY SAE reserve capacity rating	195 min	

JT20 Operator's Manual Prepare - 69 Plan Bore Path

Bend Radius

JT20 Power Pipe® HD drill pipes have a tested minimum bend radius of 107' (32.6 m). This means that a 90-degree bend in the bore path:

- has a radius (A) of 107' (32.6 m)
- requires approximately 168' (51.2 m) of drill pipe (B).

JT20 Ditch Witch® Forged HD drill pipes have a tested minimum bend radius of 109' (33.2 m). This means that a 90-degree bend in the bore path:

- has a radius (A) of 109' (33.2 m)
- requires approximately 171' (52.1 m) of drill pipe (B).

JT20 Forged drill pipes have a tested minimum bend radius of 108' (32.9 m). This means that a 90-degree

- has a radius (A) of 108' (32.9 m)
- requires approximately 170' (51.8 m) of drill pipe (B).

NOTICE: Bending drill pipe more sharply than recommended will damage the pipe and cause failure

- · If bend radius is reduced, drill pipe life is reduced.
- · If bend radius is increased, drill pipe life is increased.

IMPORTANT: Use the charts on the next page to keep bends within safe limits.

JT20 Operator's Manual Plan Bore Path

Minimum Depth

Because you must bend pipe gradually, entry pitch and bend limits determine how deep the pipe will be when it becomes horizontal. This is called the minimum depth.




Prepare - 73

- To reduce minimum depth (D1), reduce entry pitch. This also decreases setback.
- · To increase minimum depth (D2), increase entry pitch. This also increases setback.

Bore Path Calculator

Entry pitch, setback, and minimum depth work together with bend limits to determine the bore path. To find the setback (B) and entry pitch (A) that will take you to the desired minimum depth (D), use the chart below.

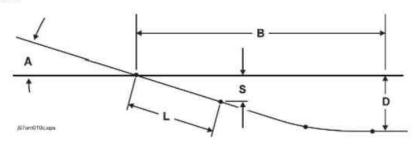

IMPORTANT: Numbers in table based on drill pipe minimum bend radius, beacon housing, EZ-Connect, connector, transition sub, and 1/3 of first drill pipe (L, totaling 8' 8" [2.6 m]) in the ground before

Power Pipe® HD

Minimum depth (D)	Entry pitch (A)	Setback (B)	Depth to begin steering (S)
3 ft 3 in (1 m)	-18%	27 ft 6 in (8.4 m)	1 ft 7 in (0.48 m)
3 ft 10 in (1.2 m)	-20%	29 ft 6 in (9 m)	1 ft 9 in (0.53 m)
4 ft 5 in (1.3 m)	-22%	31 ft 6 in (9.6 m)	1 ft 11 in (0.58 m)
5 ft 0 in (1.5 m)	-24%	33 ft 5 in (10.2 m)	2 ft 1 in (0.64 m)
5 ft 8 in (1.7 m)	-26%	35 ft 4 in (10.8 m)	2 ft 3 in (0.69 m)


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2			REVISION # 1
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NO. DA			PINES

GIULIANO LEON ENGINEERING FIRM: | PROJECT NUMBER: KMV-PP-24-001


LOCATION: 19900 PINES BLVD PEMBROKE PINES EL 33029

DRAWING NAME: KMV-PP-24-001 - FIRE STATION 79 TO WEST PINES SOCCER FIELD BUILDING 4-4-24.dwg

SHEET: 09 OF 14

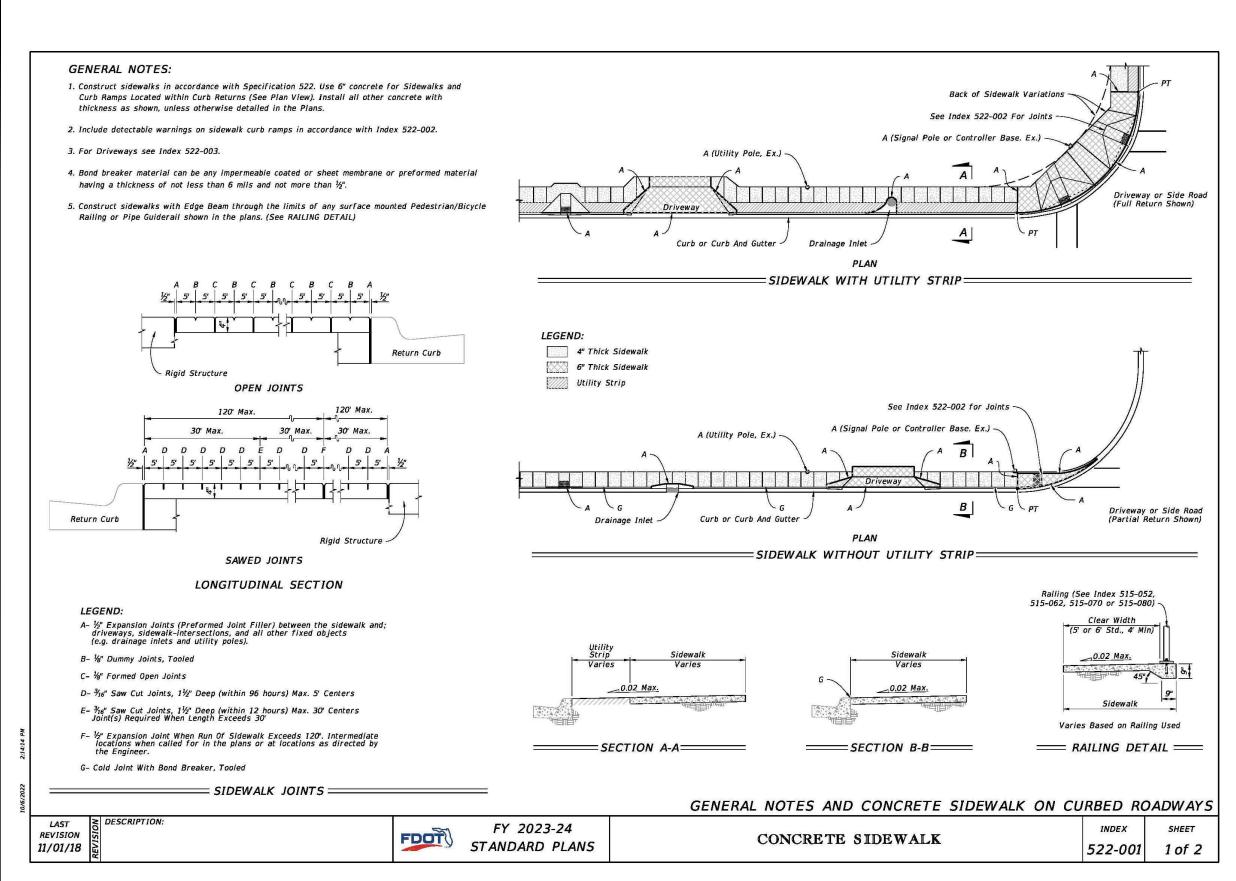

3				AS-BUILT	
2				REVISION # 1	
1	052824	KMV	JL	ORIGINAL	
NO.	DATE	ENG DESIGN	DRAFTING	COMMENT	
PEMBROKE PINES					
CHECKED BY: GIULIANO LEON					
ENGINEERING FIRM: KMV FIBERTELECOM INC					
PROJECT NUMBER: KMV-PP-24-001					
LOCATION: 19900 PINES BLVD PEMBROKE PINES, FL 33029					
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3				AS-BUILT	
2				REVISION # 1	
1	052824	KMV	JL	ORIGINAL	
NO.	DATE	ENG DESIGN	DRAFTING	COMMENT	
PEMBROKE PINES					
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	ECKED BY:		ANO LEON		
_		GIULIA FIRM: KMV I			
ENG	GINEERING		FIBERTELEC		
ENG	GINEERING DJECT NUM	FIRM: KMV	FIBERTELEC PP-24-001		
ENG	GINEERING DJECT NUM CATION: 199	FIRM: KMV F BER: KMV-P	PP-24-001 LVD	COM INC	

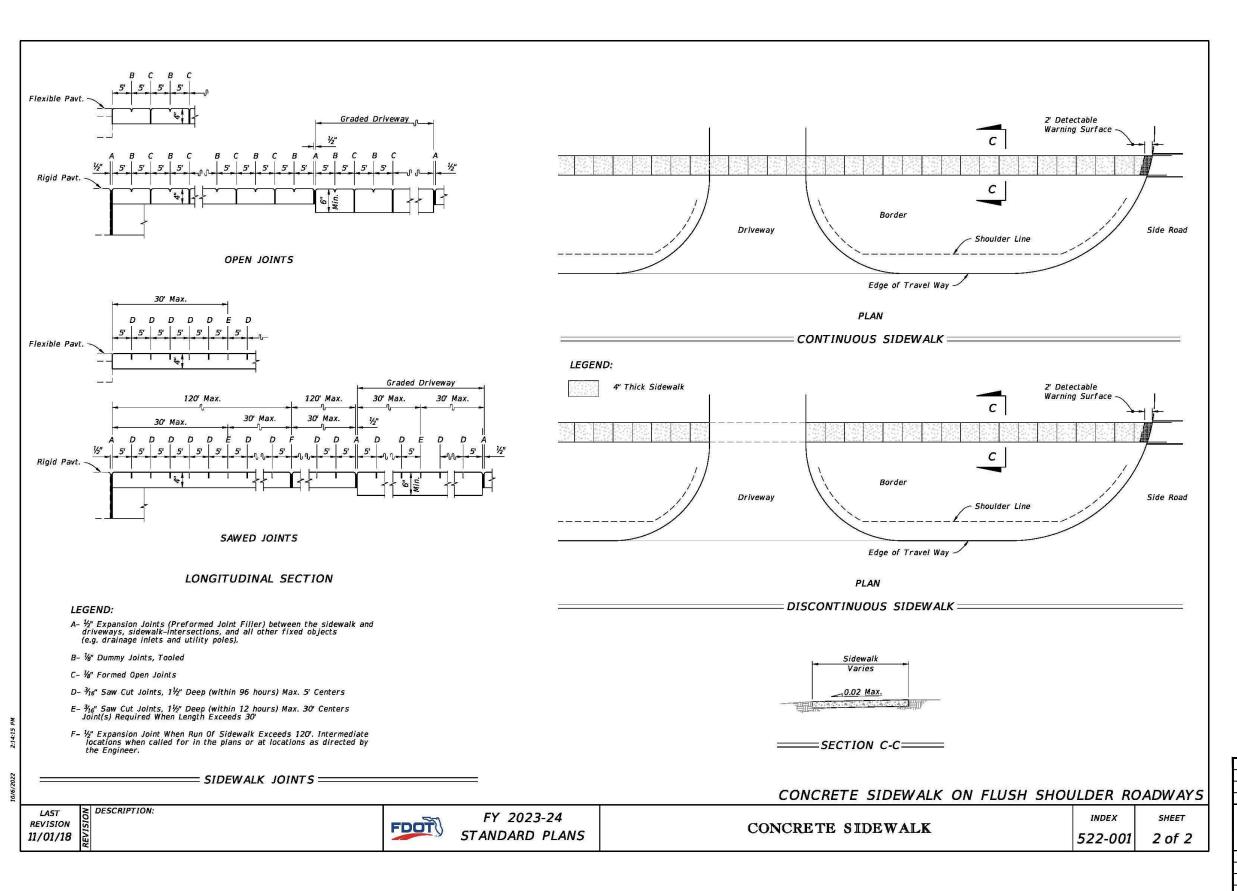FIELD BUILDING 4-4-24 dwg

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1	General Notes, TTC Tables				
	Definitions				
	Temporary Traffic Control Devices				
2	Overhead Work				
2	Railroads				
	Sight Distance				
	Above Ground Hazard				
	Clear Zone Widths For Work Zones				
	Superelevation				
	Length Of Lane Closures				
3	Overweight/Oversize Vehicles				
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₩	Temporary Asphalt Separator				
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GENERAL NOTES:

- 1. This Index contains information specific to the Federal and State guidelines and standards for the preparation of traffic control plans and for the execution of traffic control in work zones, for construction and maintenance operations and utility work on highways, roads and streets on the State Highway System. Certain requirements in this Index are based on the high volume nature of State Highways. For highways, roads and streets off the State Highway System, the local agency (City/County) having jurisdiction may adopt requirements based on the minimum requirements provided in the MUTCD.
- 2. Use this Index in accordance with the Plans and Indexes 102-601 through 102-680. Indexes 102-601 through 102-680 are Department-specific typical applications of commonly encountered situations. Adjust device location or number thereof as recommended by the Worksite Traffic Supervisor and approved by the Engineer. Devices include, but are not limited to, flaggers, portable temporary signals, signs, pavement markings, and channelizing devices. Comply with MUTCD or applicable Department criteria for any changes and document the reason for the change.
- 3. Except for emergencies, any road closure on State Highway System must comply with Section 335.15, F.S.

		TABLE	<i>1</i>			
CHA	NNELIZ	ING DE	VICE SP.	ACING		
1470000		Max. Spacing (feet)				
Work Zone Speed (mph)		es or orary Markers	Type I I Type II Vertical Pan	Barricades, Barricades, els, or Drums		
1	Taper	Tangent	Taper	Tangent		
≤ 45	25	50	25	50		
≥ 50	25	50	50	100		

TAB	LE 2
TAPER LE	NGTH "L"
Work Zone Speed (mph)	Min. Length (feet)
≤ 40	$L = \frac{WS^2}{60}$
≥ 4 5	L = W5
	idth of offset n feet need in mph

TABL	E 3	
WORK ZONE SIG	N SPACING "X"	
Road Type	Min. Spacing (feet)	
Arterials and Collectors with Work Zone Speed ≤ 40 mph	200	
Arterials and Collectors with Work Zone Speed ≥ 45 mph	500	
Limited Access Roadways *	1,500	
* For Limited access roadways mph, the minimum spacing ma with the MUTCD and as appro	y be reduced in accordance	

BUFFER LENGTH "B"				
Work Zone Speed (mph)	Min. Length (feet)			
25	155			
30	200			
35	250			
40	305			
45	360			
50	425			
55	495			
60	570			
65	645			
70	730			

cannot be attained due to geometric constraints, use the greatest length possible, but not less than 155 feet.

≥ DESCRIPTION: REVISION 11/01/20

FDOT

FY 2023-24 STANDARD PLANS

GENERAL INFORMATION FOR TRAFFIC CONTROL THROUGH WORK ZONES

102-600

SHEET 1 of 11

- 1	3				AS-BUILT	
	2				REVISION # 1	
-	1	052824	KMV	JL	ORIGINAL	
	NO.	DATE	ENG DESIGN	DRAFTING	COMMENT	
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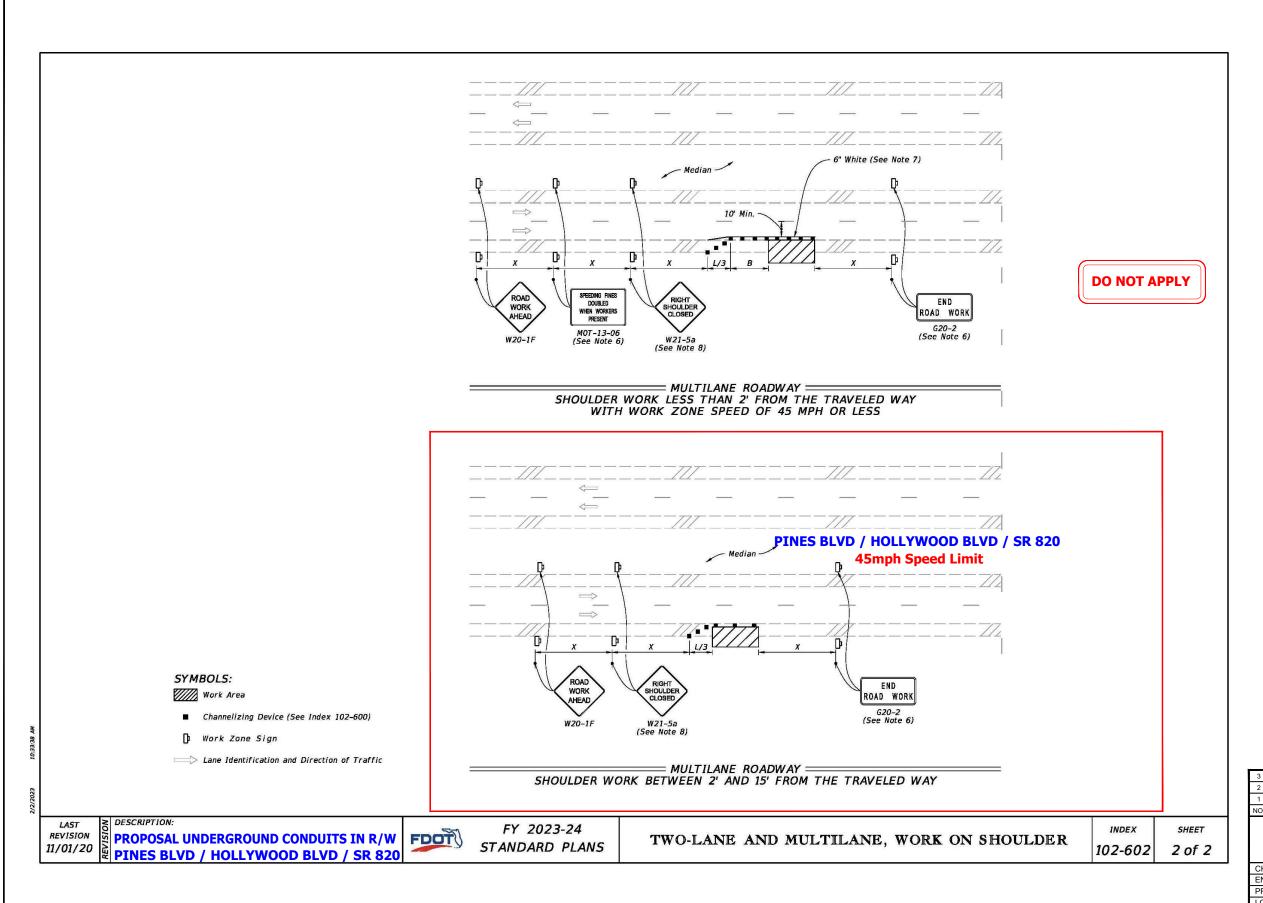
GIULIANO LEON ENGINEERING FIRM: K


PROJECT NUMBER: KMV-PP-24-001

LOCATION: 19900 PINES BLVD PEMBROKE PINES, FL 33029 DRAWING NAME: KMV-PP-24-001 - FIRE STATION 79 TO WEST PINES SOCCER

FIELD BUILDING 4-4-24.dwg

SHEET: 12 OF 14



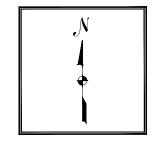

3 AS-BUILT
2 REVISION # 1
1 052824 KMV JL ORIGINAL
NO. DATE ENG DESIGN DRAFTING COMMENT





PEMBROKE **PINES**


CHECKED BY: GIULIANO LEON
ENGINEERING FIRM: KMV FIBERTELECOM IN
PROJECT NUMBER: KMV-PP-24-001

LOCATION: 19900 PINES BLVD PEMBROKE PINES, FL 33029

FIELD BUILDING 44-24.dwg

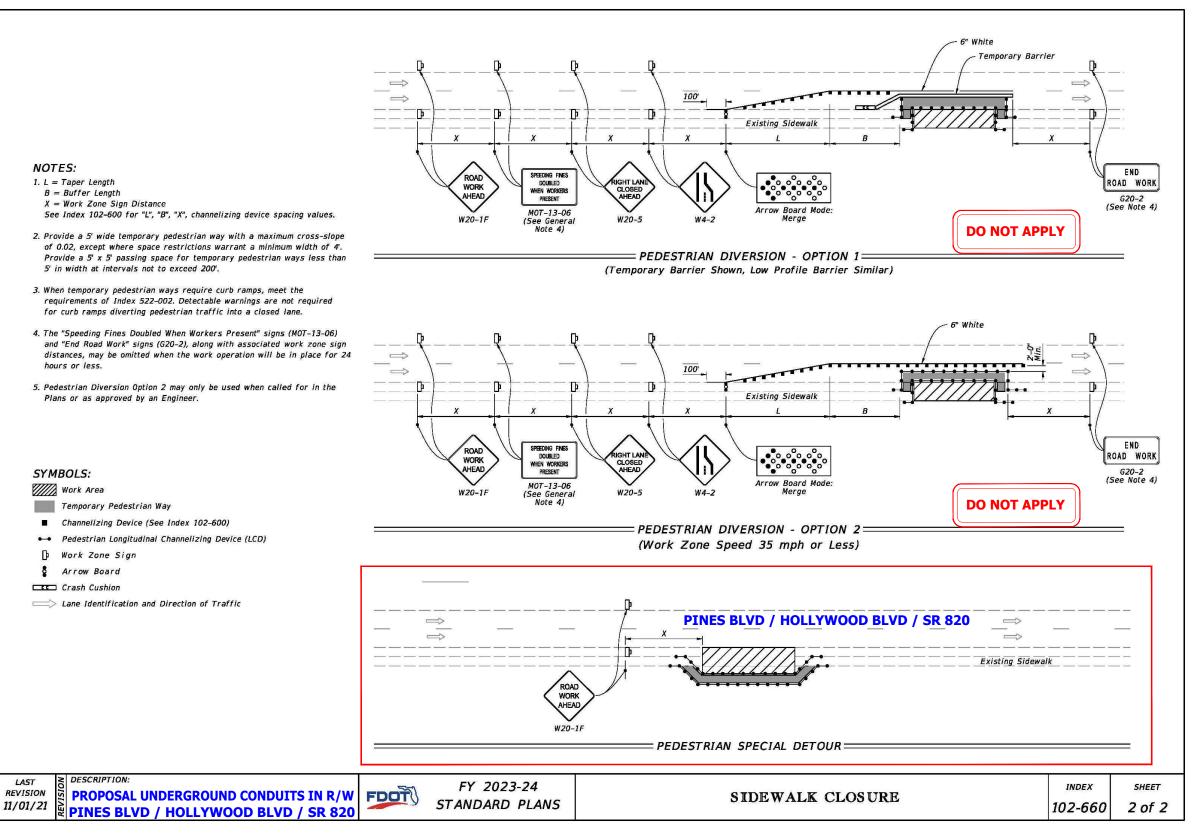

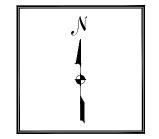

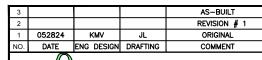



CHECKED BY: GIULIANO LEON
ENGINEERING FIRM: KMV FIBERTELECOM INC
PROJECT NUMBER: KMV-PP-24-001
LOCATION: 19900 PINES BLVD
PEMBROKE PINES, FL 33029


DRAWING NAME: KMV-PP-24-001-FIRE STATION 79 TO WEST PINES SOCCER
FIELD BUILDING 44-24,dwg

SHEET: 14 OF 14

PROJECT: KMV-PP-24-002 - FIRE STATION 89 TO WALTER YOUNG MIDDLE SCHOOL 4-2-24 ADDRESS: 901 NW 129TH AVE, PEMBROKE PINES, FL 33028 - ENGINEERING



LINETYPES

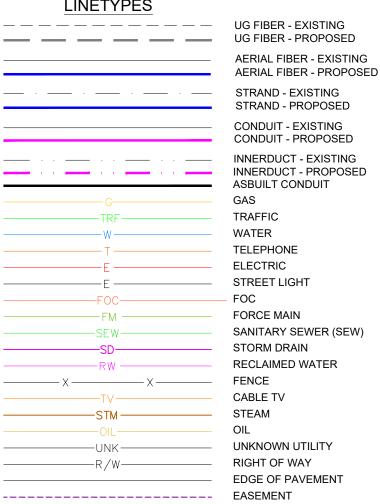



SITE LOCATION



PAGE: -

JOB DESCRIPTION	FTG
DIRECTIONAL BORE	2150'
HANDHOLE	5

SUMMARY DATA

PERMITTING JURISDICTION: * CITY OF PEMBROKE PINES

DATE SUBMITTED 05/28/24

TWP: 51S RNG: 40E SEC:14

PLAT BOOK: -

CONTACTS

PEMBROKE PINES

JOHN L.ENGLAND **DESIGN ENGINEER**

PHONE: (954) 518-8905 JENGLAND@PPINES.COM

KMV FIBERTELECOM INC

SANDRA KARINA VARGAS 10604 NW 48TH ST

CORAL SPRINGS FL 33076

PHONE: 954-937-5239

KARINAV@KMVFIBERTELECOM.COM

SITE INDEX


01 OF 15 - COVER SHEET/SITE LOCATION 02 OF 15 - OVERALL MAP 03 OF 15 TO 04 OF 15 - CONSTRUCTION NOTES 05 OF 15 TO 07C OF 15 - PLAN VIEWS & PROFILES 08 OF 15 - PHOTOGRAPHS 09 OF 15 TO 10A OF 15 - TYPICAL 11 OF 15 TO 15 OF 15 - MOTS

3				AS-BUILT
2				REVISION # 1
1	052824	KMV	AA	ORIGINAL
NO.	DATE	ENG DESIGN	DRAFTING	COMMENT



PEMBROKE **PINES**

PROJECT NUMBER: KMV-PP-24-002 LOCATION: 901 NW 129TH AVE PEMBROKE PINES EL 33028 DRAWING NAME: KMV-PP-24-002 - FIRE STATION 89 TO WAI TER YOUNG MIDDLE SCHOOL 4-2-24.dwg

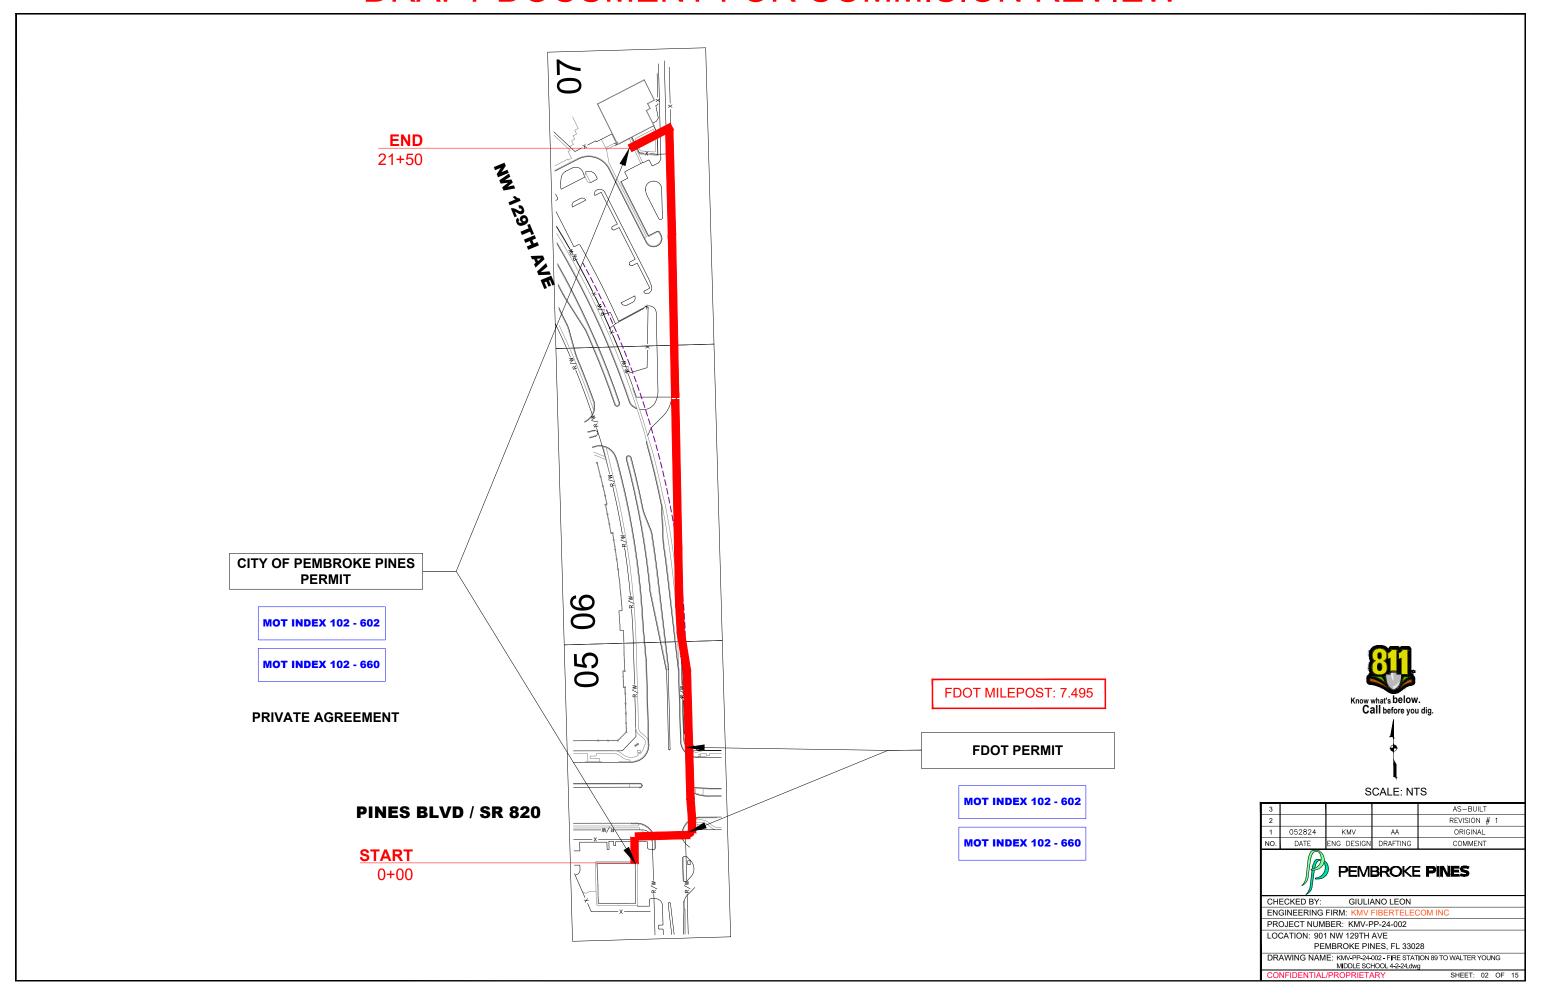

CONSTRUCTION NOTES

TYPICAL UNDERGROUND CONSTRUCTION:

- RESTORE ALL SURFACES TO EQUAL OR BETTER CONDITION.
- CONTRACTOR TO VERIFY ALL MEASUREMENTS AND DISTANCES PRIOR TO CONSTRUCTION
- CONTRACTOR TO VERIFY LOCATION AND CONDITION OF EXISTING CONDUIT PRIOR TO CONSTRUCTION.
- CONTRACTOR SHALL VERIFY ALL PLANS, EXISTING DIMENSIONS AND CONDITIONS ON THE JOB SITE AND IMMEDIATELY NOTIFY THE ENGINEER IN WRITING OF ANY DISCREPANCIES BEFORE PROCEEDING WITH THE WORK
- MAINTAIN MINIMUM 24" VERTICAL AND HORIZONTAL SEPARATION BETWEEN PROPOSED BY PEMBROKE PINES DUCTS & EXISTING UTILITIES.
- MAINTAIN A MIN BENDING RADIUS OF 5' ON ALL DUCT CONFIGURATION.
- ANY CHANGES ON PROPOSED RUNNING LINE HAVE TO GET APPROVAL FROM PEMBROKE PINES CONSTRUCTION MANAGER.

FOR CONSTRUCTION:

- EXTREME CAUTION TO BE TAKEN TO CONTAIN SLURRY AROUND WORK AREAS NEAR WETLANDS TO AVOID ANY WATER QUALITY ISSUES!
- LOCATIONS, ELEVATIONS LOCATIONS ELEVATIONS AND DIMENSIONS OF EXISTING UTILITIES, STRUCTURES AND OTHER SITE FEATURES SHOWN ON THE DRAWINGS ARE BASED ON LIMITED INVESTIGATION TECHNIQUES AND SHOULD BE CONSIDERED APPROXIMATE ONLY. PLEASE CONTACT SUNSHINE STATE ONE-CALL AT 1-800-432-4770
- CAUTION: EXISTING UNDERGROUND UTILITIES IN AREA. NO ELEVATION RECORDS FOR EXISTING UTILITIES AVAILABLE. CONTRACTOR SHOULD CONTACT SUNSHINE 811, LOCATE ALL UTILITIES AND VERIFY ALL DEPTHS PRIOR TO CONSTRUCTION

#121405467

CITY OF PEMBROKE PINES GENERAL NOTES

- THE CITY OF PEMBROKE PINES ASSUMES NO RESPONSIBILITY OR LIABILITY FOR THE LOCATIONS AND ELEVATIONS OF CITY UTILITIES AS REFLECTED ON THE DRAWINGS BASED UPON INFORMATION PROVIDED FROM CITY RECORDS NOR DOES THE CITY GUARANTEE THE COMPLETENESS OF THE CITY UTILITIES INFORMATION AS PROVIDED FROM CITY RECORDS. IT IS THE RESPONSIBILITY OF THE CONTRACTOR AND UTILITY OWNER TO FIELD LOCATE AND FIELD VERIFY ALL EXISTING UTILITIES IN THE WORK AREA FOR THE ENTIRE LIMITS OF THE PROJECT.
- A MINIMUM OF 7.5' OF HORIZONTAL SEPARATION AND A MINIMUM OF 18" OF VERTICAL SEPARATION SHALL BE MAINTAINED TO ALL CITY OF PEMBROKE PINES UTILITIES, UNLESS OTHERWISE APPROVED BY THE CITY ENGINEER.
- ALL CROSSINGS OF THE PROPOSED DIRECTIONAL BORE AND OPEN TRENCH INSTALLATION WITH CITY UTILITIES SHALL BE VERIFIED FOR CONFIRMATION OF MINIMUM VERTICAL SEPARATION REQUIREMENTS BY WAY OF "SOFT DIG" METHODS PRIOR TO THE START OF CONSTRUCTION.
- CONTRACTOR SHALL CALL "SUNSHINE ONE" AT 1-800-432-4770 OR 811 A MINIMUM OF 72 HOURS PRIOR TO THE START OF CONSTRUCTION TO ALLOW FOR "FIELD LOCATES" OF ALL EXISTING UTILITIES WITHIN THE PROJECT LIMITS.
- ALL STREET, SIDEWALK AND SWALE (SOD) RESTORATION SHALL COMPLY WITH CITY STANDARDS AND/OR SPECIFICATIONS, UNLESS THE STANDARDS AND/OR SPECIFICATIONS OF ANOTHER PERMITTING GOVERNMENTAL AGENCY SUPERCEDES THOSE OF THE CITY.
- A M.O.T. PLAN PREPARED BY A F.D.O.T. CERTIFIED M.O.T. ENGINEER SHALL BE SUBMITTED FOR CONSTRUCTION PERMIT BASED UPON THE SCOPE OF THE PROPOSED PROJECT AND EXISTING ROADWAY/STREET CONDITIONS.
- A PRECONSTRUCTION MEETING IS REQUIRED TO BE HELD WITH THE ENVIRONMENTAL SERVICES/ENGINEERING DIVISION AS A PREREQUISITE TO THE CITY'S RELEASE OF THE CONSTRUCTION PERMIT.
- MAINTENANCE OF TRAFFIC (M.O.T.) SHALL BE PROVIDED BY A F.D.O.T. CERTIFIED M.O.T. CONTRACTOR.

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NO.	DATE	ENG DESIGN	DRAFTING	COMMENT



GIULIANO LEON

ENGINEERING FIRM: K PROJECT NUMBER: KMV-PP-24-002

LOCATION: 901 NW 129TH AVE PEMBROKE PINES EL 33028

DRAWING NAME: KMV-PP-24-002 - FIRE STATION 89 TO WALTER YOUNG MIDDLE SCHOOL 4-2-24 dwg

SHEET: 03 OF 15

CONSTRUCTION NOTES - FDOT

- EXISTING F.D.O.T. DRAINAGE SYSTEM SHALL BE PROTECTED AT ALL TIMES BY THE PERMITTEE. ANY DAMAGE TO THE F.D.O.T. DRAINAGE SYSTEM (STRUCTURES OR PIPES) SHALL BE REPAIRED/REPLACED BY THE PERMITTEE AT NO COST TO THE DEPARTMENT.
- EXISTING GAS MAIN SHALL BE PROTECTED AT ALL TIMES DURING EXCAVATION, DRILLING AND CONDUIT INSTALLATION ACTIVITIES. UTILITY GAS COMPANY SHALL BE PRESENT AT THE PRE-CONSTRUCTION MEETING AND GIVE WRITTEN CLEARANCE PRIOR TO COMMENCEMENT OF ANY PERMIT OPERATIONS.
- ANY DAMAGE TO CONCRETE SIDEWALK, CURB AND GUTTER, PEDESTRIAN CURB RAMPS, AND TRAFFIC SEPARATORS SHOULD BE RESTORED PER FDOT STANDARDS PLANS INDEX NO. 522-002, AND 520-002, ADA STANDARDS, AND FDOT STANDARD SPECIFICATION 522.


 DAMAGED SIDEWALK, CURB AND GUTTER, AND TRAFFIC SEPARATORS SHALL BE RESTORED WITH FULL FLAGS/JOINT TO JOINT AT THE PERMITTEES EXPENSE; PATCHING IS NOT PERMITTED. IMPACTED PEDESTRIAN RAMPS SHALL BE REPLACED COMPLETELY; HANDHOLES MUST NOT BE LOCATED WITHIN PEDESTRIAN RAMPS. MAKE SURE TO FURNISH APPROPRIATE EXPANSION JOINTS PER FDOT STANDARDS PLANS INDEX 350-001. IMPACTED DETECTABLE WARNING SURFACES NEED TO BE RESTORED IN ACCORDANCE WITH FDOT STANDARD PLANS INDEX NO. 522-002 AND SPECIFICATION 527
- HANDHOLES AND PULL BOXES SHALL NOT BE INSTALLED WITHIN THE FOOTPRINT OF EXISTING PEDESTRIAN ADA CURB RAMP NEITHER DRIVEWAY ENTRY AREA. REFER TO PPM, VOL. 2, CH. 8, SECTION 8.3.2 REGARDING NONSLIP TOP SURFACE IF THE HAND HOLE IS PROPOSED WITHIN PEDESTRIAN CURB RAMP, DO NOT INSTALL NEW HH AT LEAST 10' FROM ADA CURB RAMPS, FIRE HYDRANTS, BUS BOOTH-BENCHES
- WHERE PEDESTRIAN FACILITIES ARE DETOURED, BLOCKED, OR CLOSED DURING THE WORK, PLEASE ENSURE TO PROVIDE SAFE ALTERNATE ACCESSIBLE ROUTES THROUGH OR AROUND THE WORK ZONE THAT MEETS THE REQUIREMENTS OF THE ADA STANDARDS AND FDOT STANDARD PLAN INDEX 102-660
- RESTORATION OF SODDING AND TURF SHOULD BE DONE ACCORDING TO FDOT 2023-2024 STANDARD INDEX No 570-001.
- PROVIDE PROTECTION TO THE EXISTING TREES AND AVOID ANY IMPACT TO THE ROOTS. WHEN CONSTRUCTION AFFECTS TREE ROOTS OR CANOPY, PROVIDE TRIMMING PER FDOT STANDARD PLANS INDEX 110-100.
- PROVIDE APPROPRIATE EROSION CONTROL DEVICES DURING CONSTRUCTION.
- LANDSCAPING, TREES, SOD SHALL BE REPLACED AT THE COST OF THE PERMITTEE
- THE CONTRACTOR SHALL COORDINATE WITH BROWARD COUNTY DEPARTMENT OF TRANSPORTATION AND PUBLIC WORKS (DTPW), TRAFFIC SIGNALS & SIGNS DIVISION AT LEAST 5 WORKING DAYS PRIOR TO ANY WORK DONE AT SIGNALIZED INTERSECTIONS, WHICH EITHER CLOSE ANY LANES, NEED CHANGES IN THE SIGNAL OPERATION OF TIMING, DAMAGE OR HINDER ANY SIGNAL SENSOR, OR DAMAGE ANY CABLE OR SIGNAL EQUIPMENT.
- PERMITTEE IS RESPONSIBLE FOR LOCATING ALL UNDERGROUND FACILITIES PRIOR TO DIRECTIONAL DRILLING/TRENCH WORK AND ASSUMES ALL RESPONSIBILITY FOR ANY DAMAGE DONE TO UNDERGROUND FACILITIES AND ABOVE GROUND FACILITIES. DIRECTIONAL BORING SHALL BE CONDUCTED ACCORDING TO LATEST SECTION 555 OF FDOT'S STANDARD SPECIFICATIONS AND 3.16.9.1 OF THE 2017 U.A.M. OPEN TRENCH SHALL BE CARRIED OUT PER 3.16.4. OF 2017 U.A.M
- CONDUIT INSTALLATION SHALL ADHERE TO THE LATEST FDOT STANDARD PLANS INDEX NO. 630-001
- ACCORDING TO SECTION 3.10 OF 2017 U.A.M, WHEN UNDERGROUND AND AERIAL UTILITIES OCCUPY THE SAME ROADSIDE, UNDERGROUND UTILITIES SHALL NOT BE PLACED WITHIN THREE (3) FEET OF THE R/W LINE.
- DAMAGED SIDEWALK, CURB AND GUTTER, AND TRAFFIC SEPARATORS SHALL BE RESTORED WITH FULL FLAGS/JOINT TO JOINT AT THE PERMITTEES EXPENSE; PATCHING IS NOT PERMITTED. RESTORATION SHALL MATCH EXISTING CONCRETE PATTERN, PAVERS, AND COLOR. IMPACTED PEDESTRIAN RAMPS AND DRIVEWAYS SHALL BE REPLACED COMPLETELY. INCLUDE 1 FOOT OF LEVEL EMBANKMENT FOR EROSION AND ENSURE TO NOT CREATE ANY DROP OFF HAZARDS AS SHOWN ON FDM FIGURE 222.4.1. IMPACTED DETECTABLE WARNING SURFACES NEED TO BE RESTORED IN ACCORDANCE WITH FDOT STANDARD PLANS INDEX NO. 522-002 AND SPECIFICATION 527
- PROPOSED HANDHOLES MUST ADHERE TO LATEST FDOT STANDARD PLANS INDEX NO. 635-001". ENSURE ALL HANDHOLE LIDS ON SIDEWALK ARE FLUSH AND ADA COMPLIANT. MAINTAIN THE TEMPORARY PATCHES AROUND THE HANDHOLE BOX EDGES AND/OR ANYWHERE ELSE WHERE SIDEWALK HAS BEEN IMPACTED/DAMAGED BY THE DB WORK OR UTILITY INSTALLATION, SO IT PROVIDES A SMOOTH -ALL WEATHER SURFACES ALWAYS. ONCE THE HANDHOLE IS INSTALLED THE LID MUST BE KEPT IN PLACE, BOLTED, AND SECURED.
- TEMPORARY BARRIERS FOR PEDESTRIAN DETOURS MUST COMPLY WITH THE LATEST FDOT STANDARD PLANS INDEX NO. 102-100.
- RESTORATION OF SODDING AND TURF SHOULD BE DONE ACCORDING TO FDOT 2023-24 DESIGN STANDARDS INDEX 570-010.
- PERMITTEE MUST TAKE PICTURES OF THE EXISTING STREET LIGHTNING SYSTEM WORKING-DURING NIGHT-TIME-WITHIN THE LIMITS OF THIS PROPOSED JOB PRIOR TO BEGIN SAID WORK. TO AVOID FUTURE DISPUTE ABOUT UNFORESEEN DAMAGES TO THE LIGHTNING SYSTEM


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- CONTAMINATED SITES LOCATED WITHIN A 500-FOOT RADIUS OF THE PROJECT AREA THAT COULD IMPACT THE FDOT ROW HAVE BEEN IDENTIFIED. THE PERMITTEE SHALL ASSURE THAT ANY ACTIONS CARRIED OUT ARE IN ACCORDANCE WITH ALL ENVIRONMENTAL REGULATORY REQUIREMENTS.
- ANY ABOVEGROUND FEATURES THAT MAY BE IMPACTED BY PROPOSED WORK MUST BE IDENTIFIED TO BE ADJUSTED/RELOCATED/REPLACED. IF SIGNS ADD ARE DAMAGED, THESE MUST BE REPLACED ACCORDING THE LATEST FDOT STANDARD PLANS INDEX NO. 700-101. ENSURE LATERAL OFFSET AND CLEAR ZONE STANDARDS ARE BEING ADHERED TO.

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NO.	DATE	ENG DESIGN	DRAFTING	COMMENT	
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PROFILE - (LOOKING WEST)

HORIZONTAL SCALE: 1"=50 VERTICAL SCALE: 1"=5'

DITCH WITCH JT20 - SPECS BEND RADIUS, MIN 107FT MIN DEPTH 3' 3"

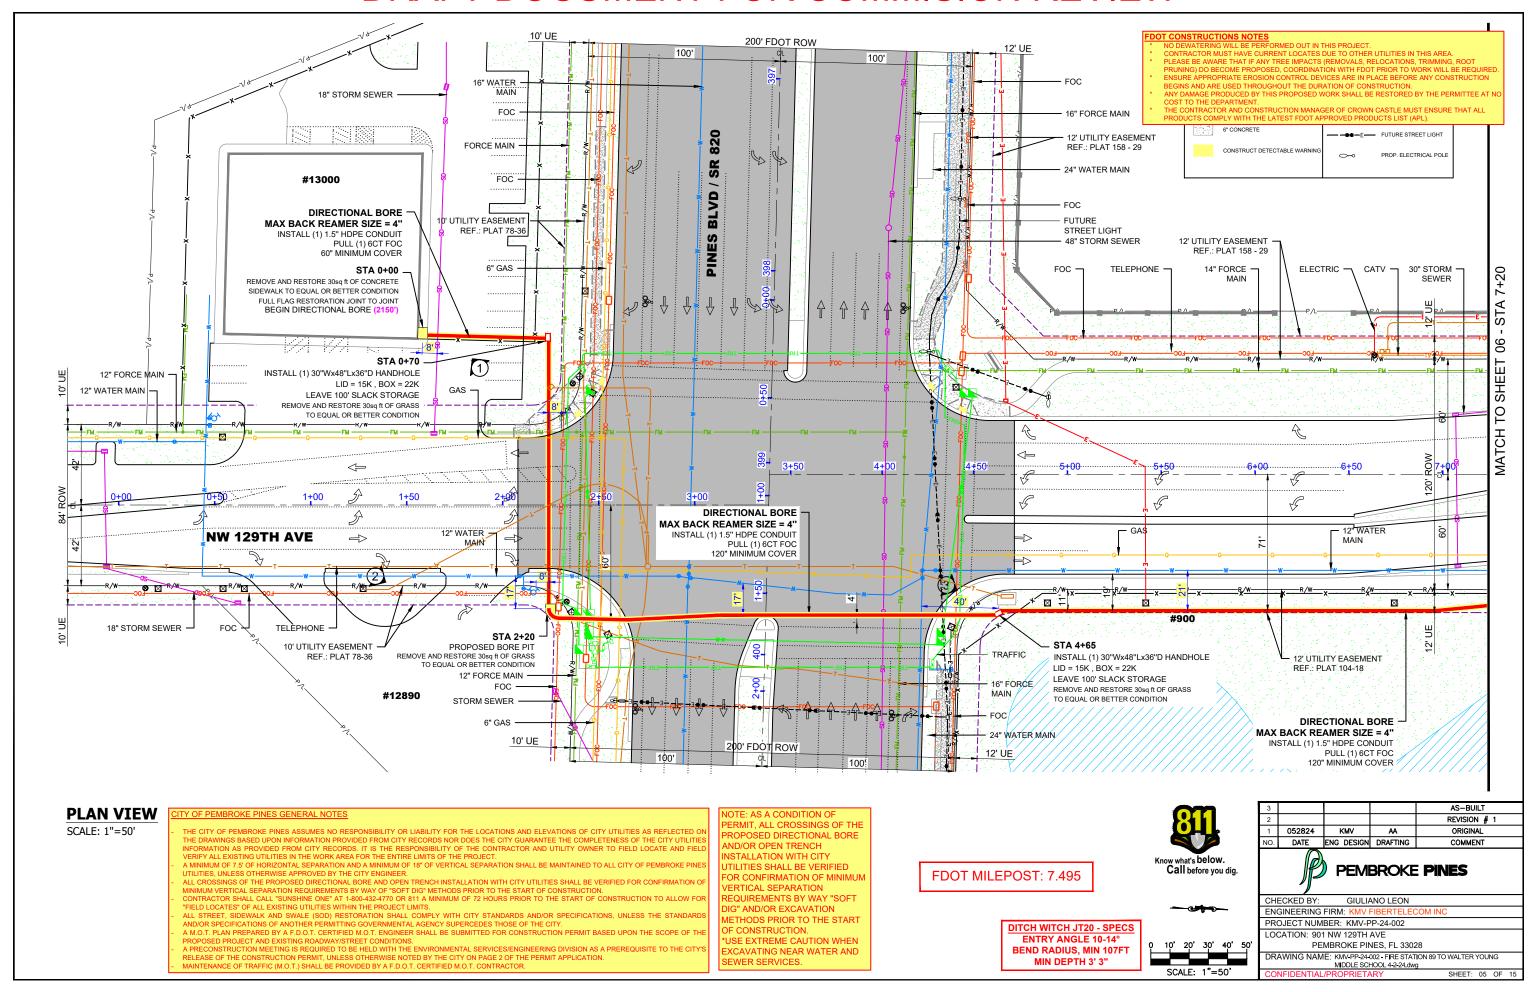RECORD ON UTILITY PLANS CONSTRUCTION CONTRACTOR SHALL CALL LOCATES AND SOFT DIG TO DETERMINE UTILITY ELEVATION BEFORE CONSTRUCTION.

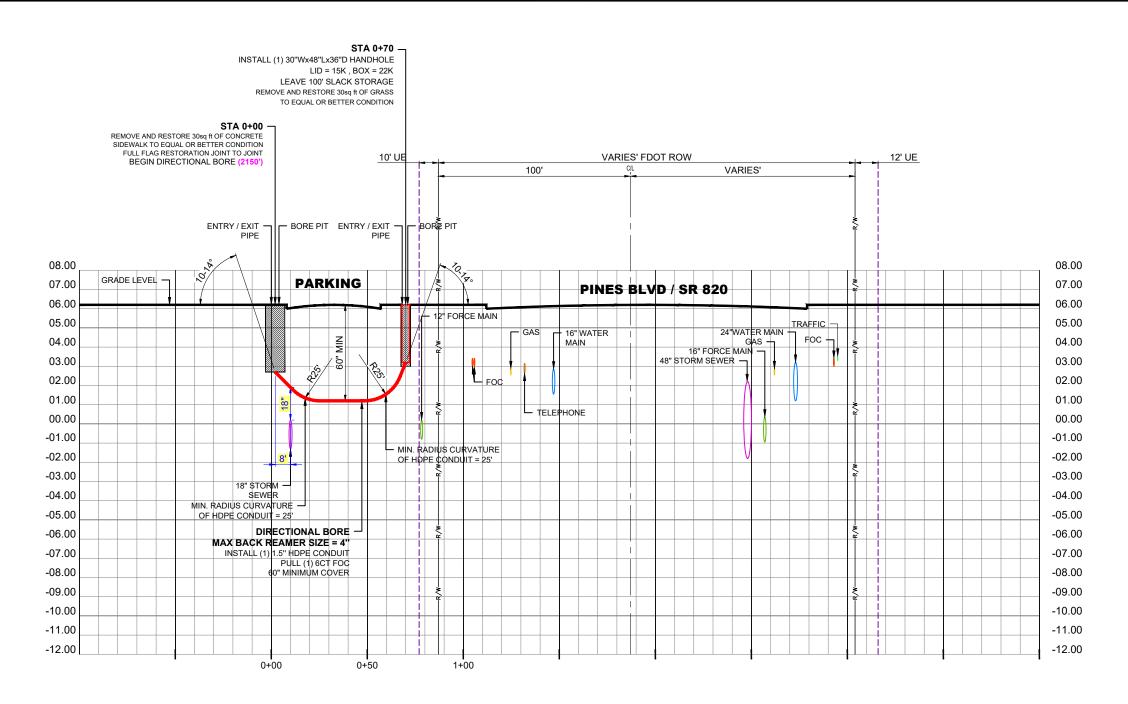

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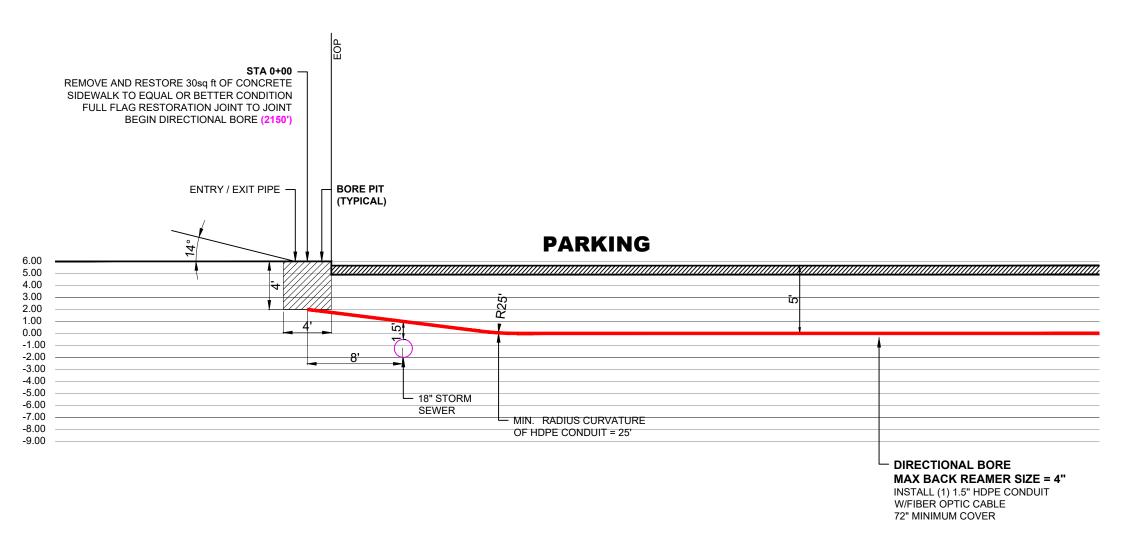
CHECKED BY: GIULIANO LEON

ENGINEERING FIRM: K PROJECT NUMBER: KMV-PP-24-002

LOCATION: 901 NW 129TH AVE PEMBROKE PINES, FL 33028

DRAWING NAME: KMV-PP-24-002 - FIRE STATION 89 TO WALTER YOUNG MIDDLE SCHOOL 4-2-24.dwg

SHEET: 05A OF 15



PROFILE - NW 129TH AVE (LOOKING WEST)

HORIZONTAL SCALE: 1"=8' VERTICAL SCALE: 1"=1'

NOTE: AS A CONDITION OF PERMIT, ALL CROSSINGS OF THE PROPOSED DIRECTIONAL BORE AND/OR OPEN TRENCH INSTALLATION WITH CITY UTILITIES SHALL BE VERIFIED FOR CONFIRMATION OF MINIMUM VERTICAL SEPARATION REQUIREMENTS BY WAY "SOFT DIG" AND/OR EXCAVATION METHODS PRIOR TO THE START OF CONSTRUCTION. "USE EXTREME CAUTION WHEN EXCAVATING NEAR WATER AND SEWER SERVICES.

DITCH WITCH JT20 - SPECS ENTRY ANGLE 10-14° BEND RADIUS, MIN 107FT MIN DEPTH 3' 3" RECORD ON UTILITY PLANS CONSTRUCTION CONTRACTOR SHALL CALL LOCATES AND SOFT DIG TO DETERMINE UTILITY ELEVATION BEFORE CONSTRUCTION.



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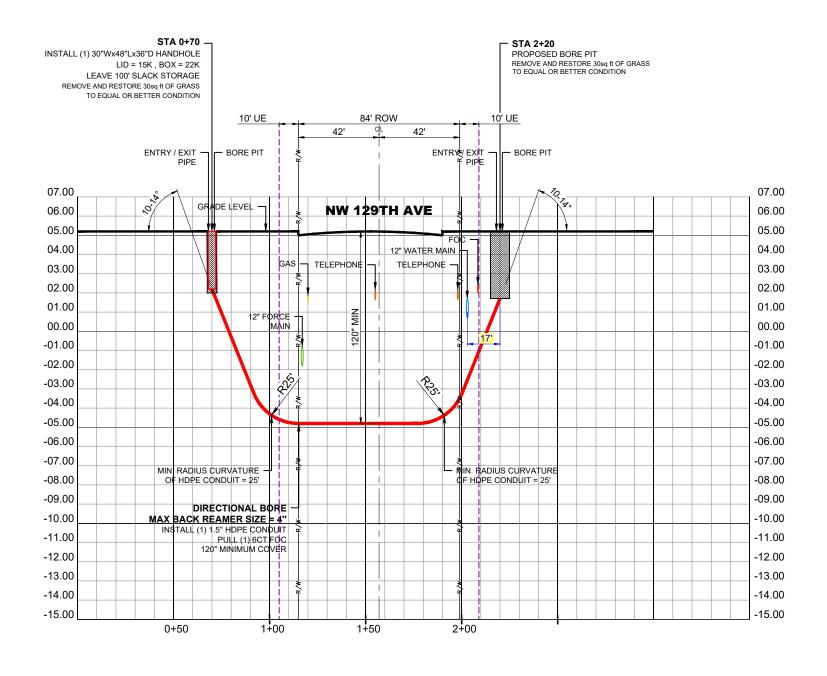
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ENGINEERING FIRM: KMV FIBERTELECOI

PROJECT NUMBER: KMV-PP-24-002

LOCATION: 901 NW 129TH AVE

PEMBROKE PINES, FL 33028
DRAWING NAME: KMV-PP-24-002-FIRE STATION 89 TO WALTER YOUNG MIDDLE SCHOOL 4-2-24.dwg

NFIDENTIAL/PROPRIETARY SHEET: 05B OF 15



PROFILE - NW 129TH AVE (LOOKING NORTH)

HORIZONTAL SCALE: 1"=50' VERTICAL SCALE: 1"=5'

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RECORD ON UTILITY PLANS CONSTRUCTION CONTRACTOR SHALL CALL LOCATES AND SOFT DIG TO DETERMINE UTILITY ELEVATION BEFORE CONSTRUCTION.



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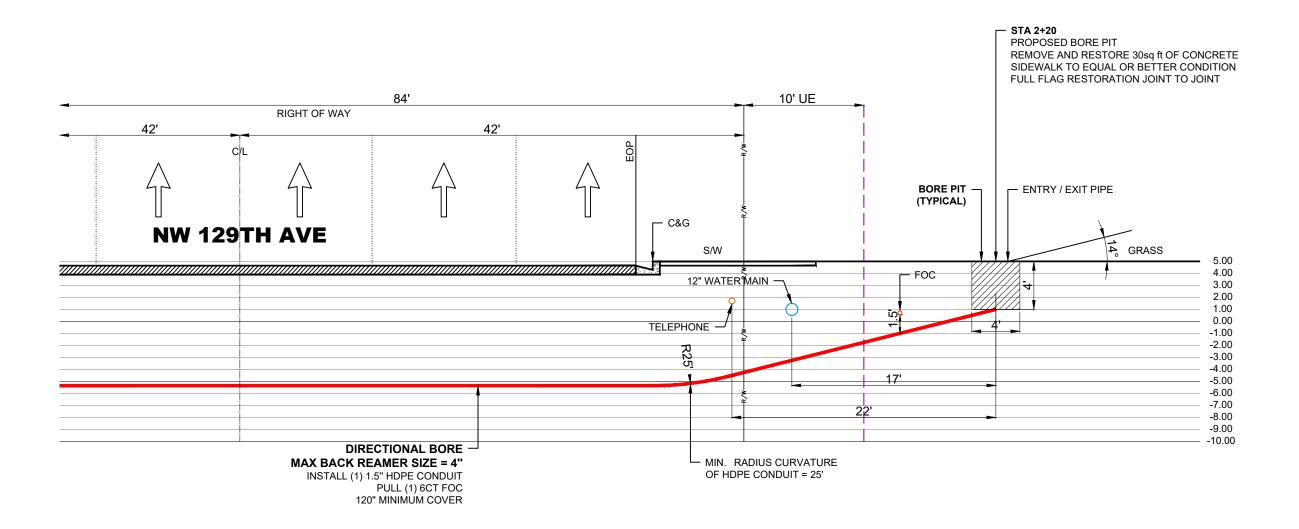
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PROJECT NUMBER: KMV-PP-24-002

LOCATION: 901 NW 129TH AVE PEMBROKE PINES, FL 33028

DRAWING NAME: KMV-PP-24-002 - FIRE STATION 89 TO WALTER YOUNG MIDDLE SCHOOL 4-2-24.dwg

SHEET: 05C OF 15



PROFILE - NW 129TH AVE (LOOKING NORTH)

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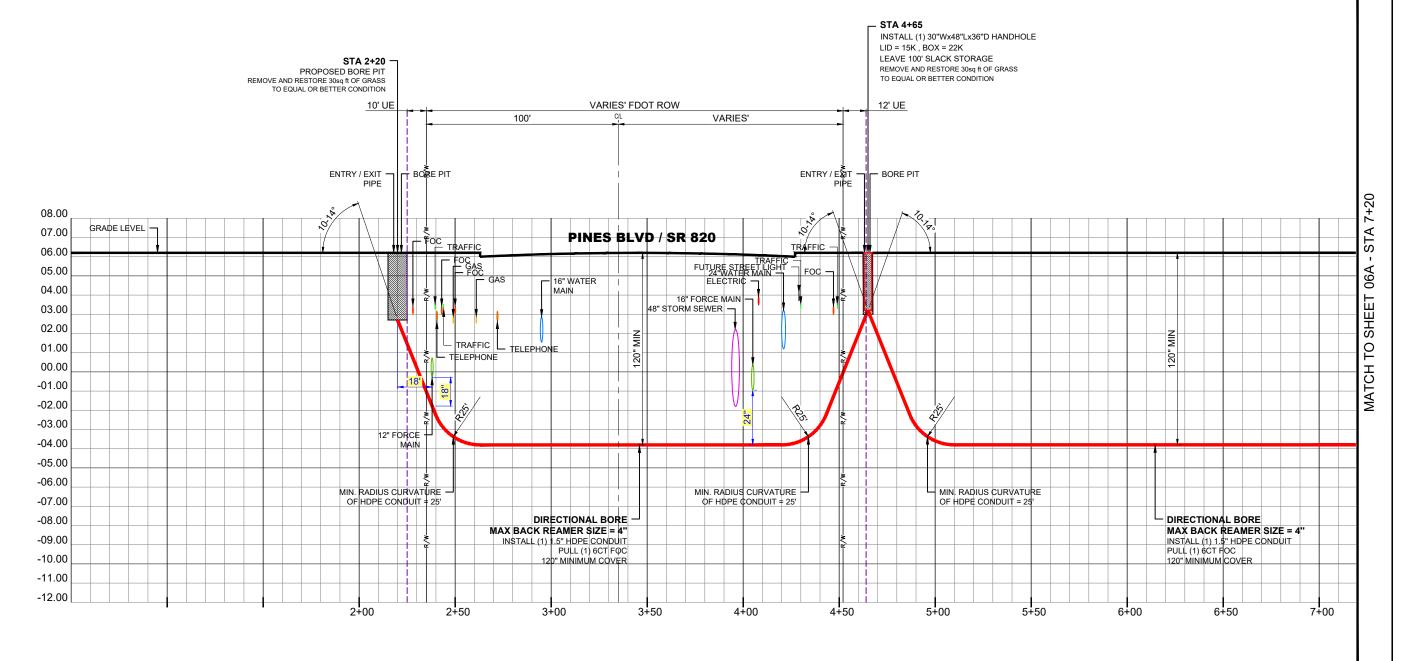
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SHEET: 05D OF 15



PROFILE - NW 129TH AVE (LOOKING WEST)


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RECORD ON UTILITY PLANS CONSTRUCTION CONTRACTOR SHALL CALL LOCATES AND SOFT DIG TO DETERMINE UTILITY ELEVATION BEFORE CONSTRUCTION.



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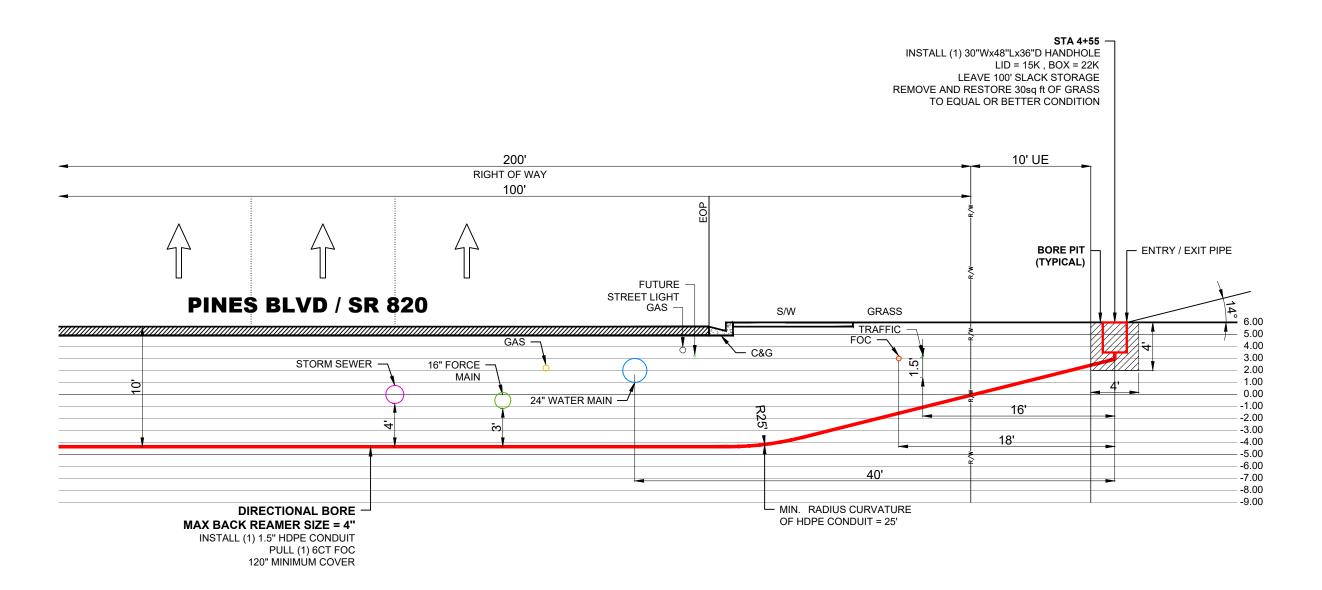


GIULIANO LEON

ENGINEERING FIRM: K PROJECT NUMBER: KMV-PP-24-002

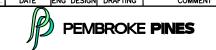LOCATION: 901 NW 129TH AVE PEMBROKE PINES, FL 33028

DRAWING NAME: KMV-PP-24-002 - FIRE STATION 89 TO WALTER YOUNG MIDDLE SCHOOL 4-2-24.dwg SHEET: 05E OF 15



PROFILE - NW 129TH AVE (LOOKING WEST)

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VERTICAL SCALE: 1"=1'


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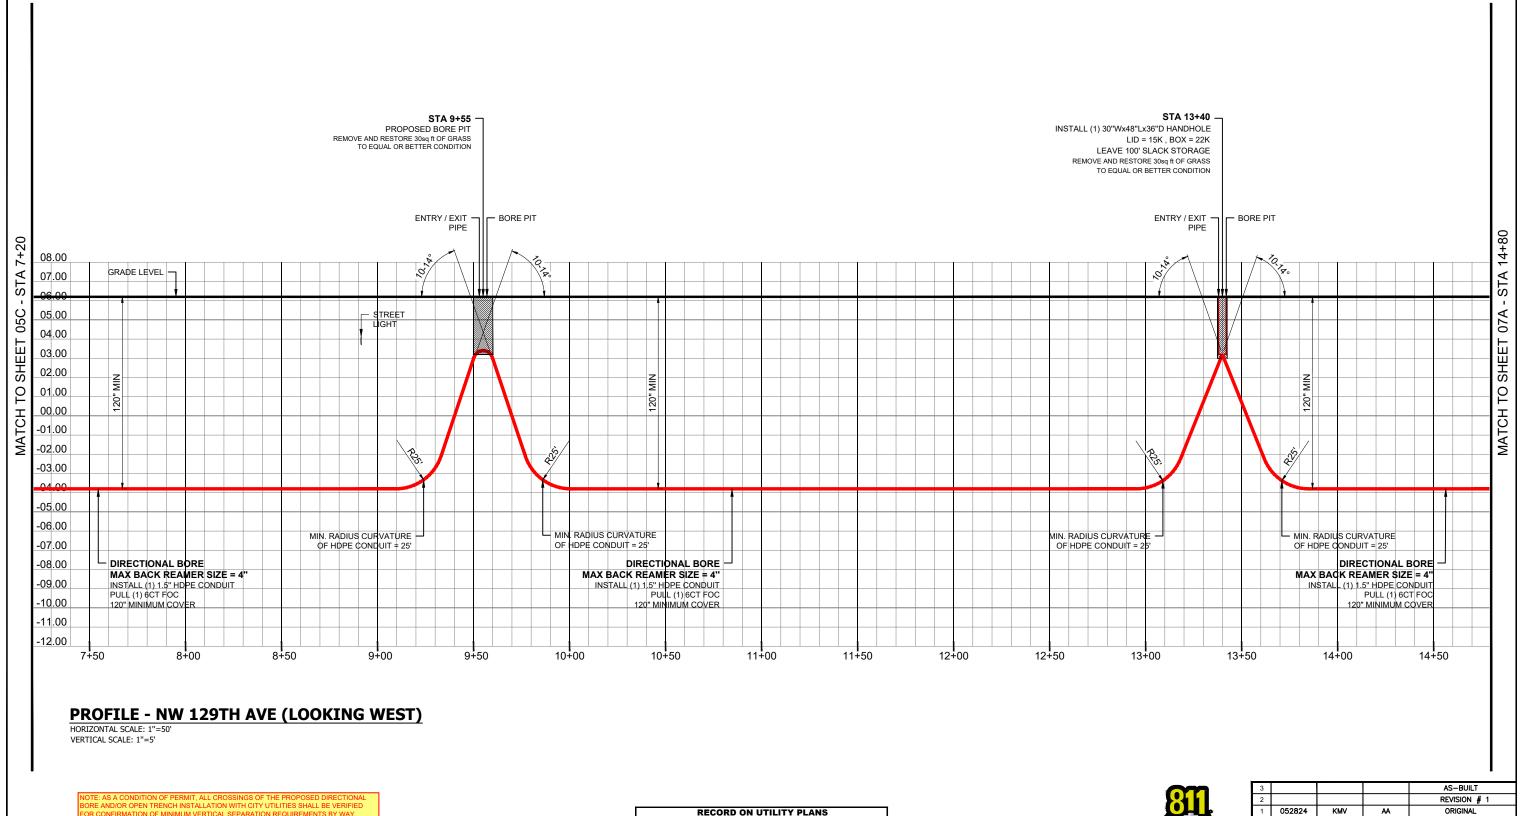
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	PR	DJECT NUM	BER: KMV-F	P-24-002	
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SHEET: 05F OF 15





DITCH WITCH JT20 - SPECS BEND RADIUS, MIN 107FT MIN DEPTH 3' 3"

CONSTRUCTION CONTRACTOR SHALL CALL LOCATES AND SOFT DIG TO DETERMINE UTILITY ELEVATION BEFORE CONSTRUCTION.

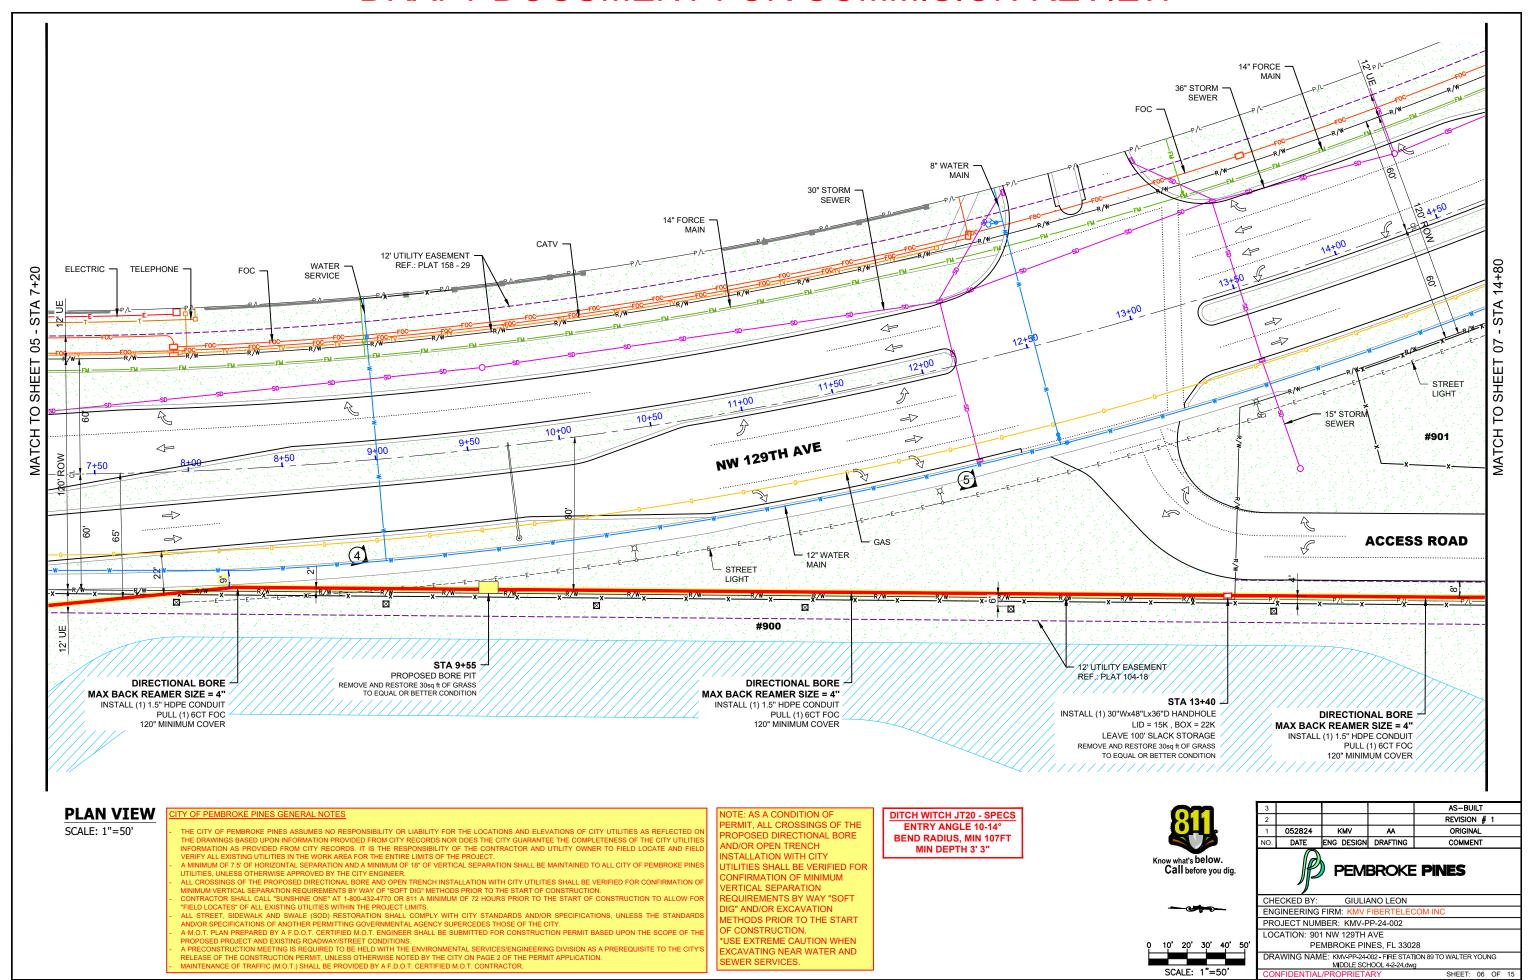



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_			ANO LEON	

PEMBROKE PINES EL 33028 DRAWING NAME: KMV-PP-24-002 - FIRE STATION 89 TO WALTER YOUNG MIDDLE SCHOOL 4-2-24.dwg

LOCATION: 901 NW 129TH AVE

SHEET: 06A OF 15

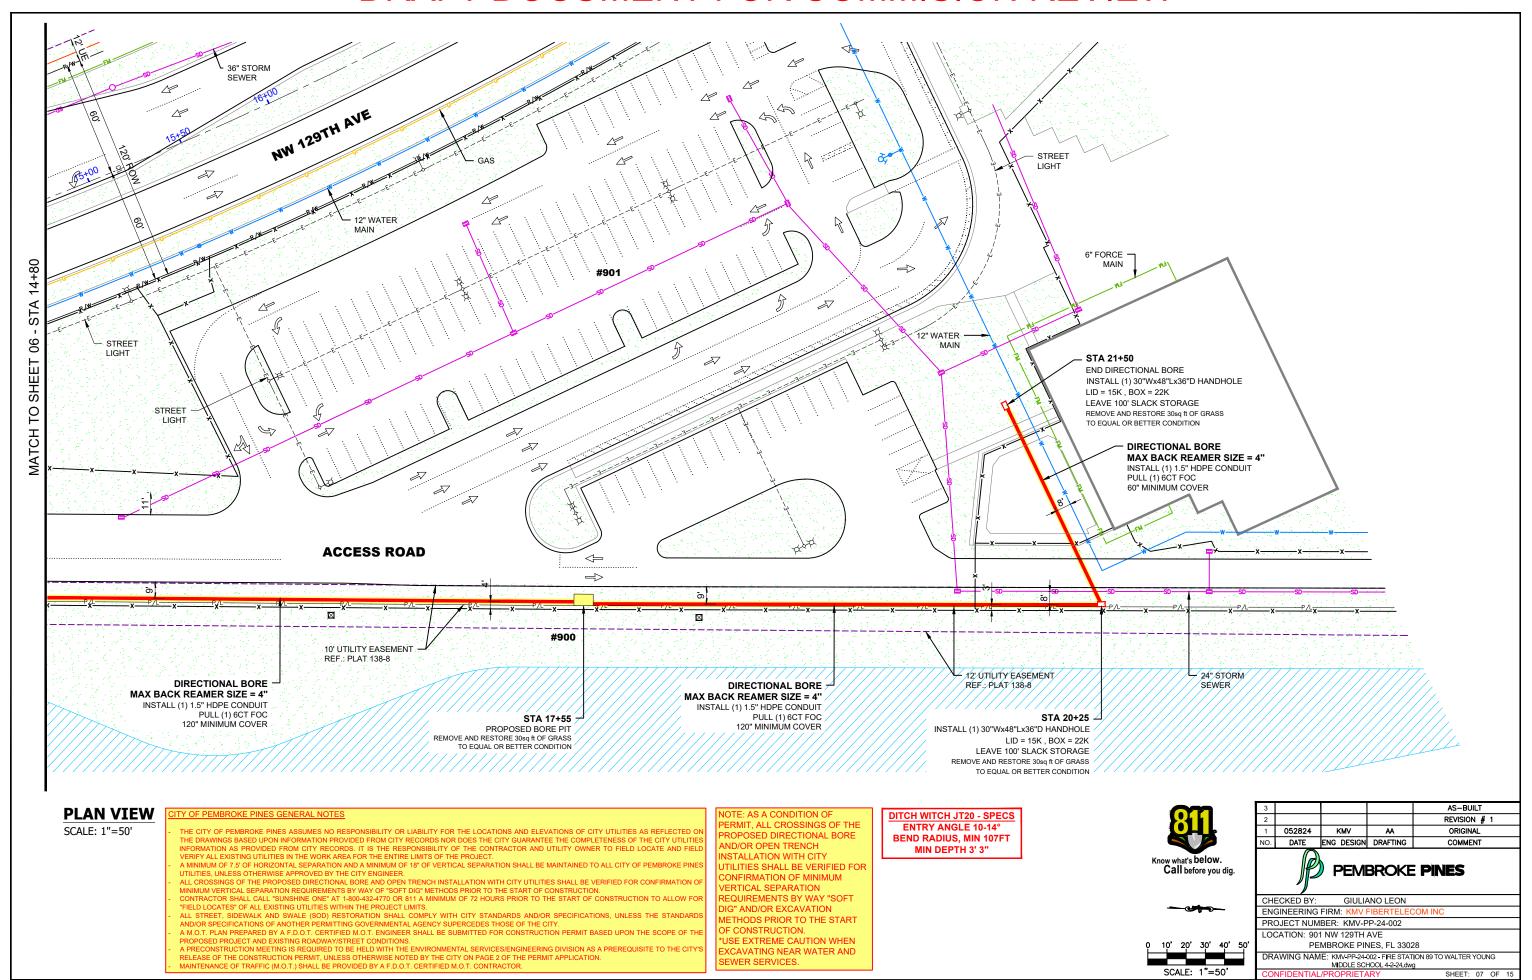

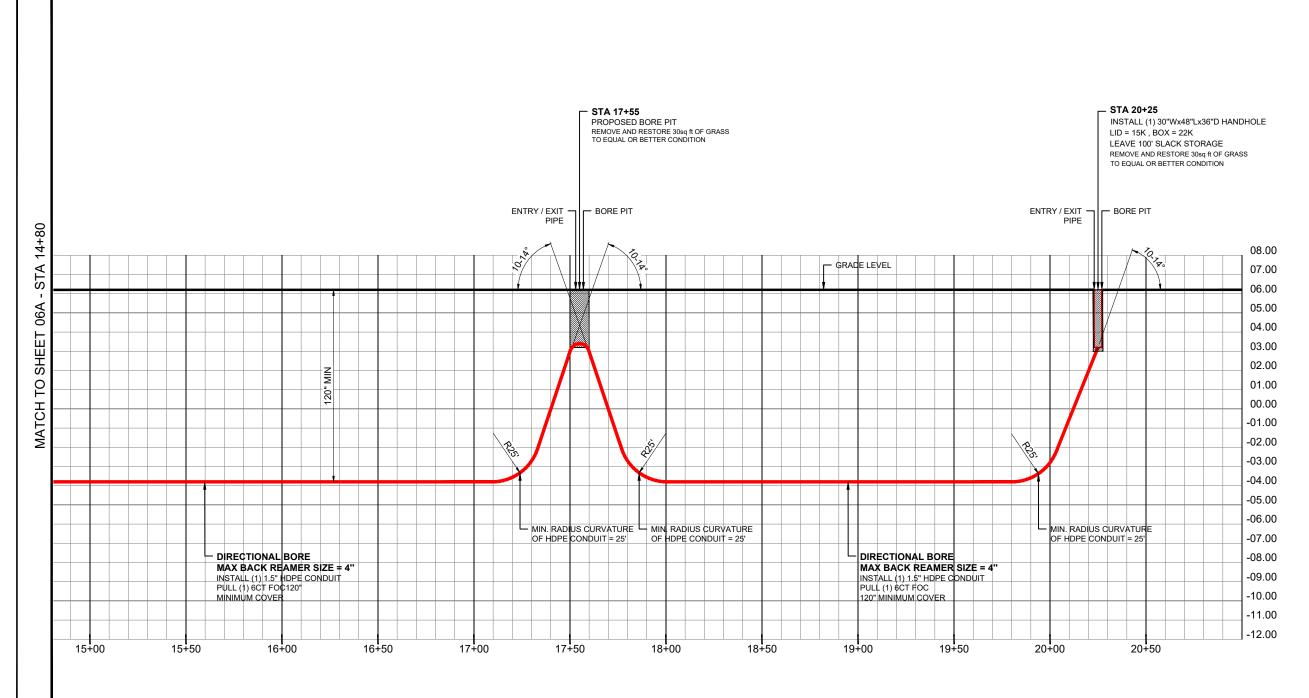

PROFILE - NW 129TH AVE (LOOKING WEST)

HORIZONTAL SCALE: 1"=50' VERTICAL SCALE: 1"=5'

DITCH WITCH JT20 - SPECS BEND RADIUS, MIN 107FT MIN DEPTH 3' 3"

RECORD ON UTILITY PLANS CONSTRUCTION CONTRACTOR SHALL CALL LOCATES AND SOFT DIG TO DETERMINE UTILITY ELEVATION BEFORE CONSTRUCTION.




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2				REVISION # 1		
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NO.	DATE	ENG DESIGN	DRAFTING	COMMENT		
PEMBROKE PINES						
	P			PINES		
СН	P ECKED BY:		BROKE	PINES		

PROJECT NUMBER: KMV-PP-24-002

LOCATION: 901 NW 129TH AVE

PEMBROKE PINES, FL 33028 DRAWING NAME: KMV-PP-24-002 - FIRE STATION 89 TO WALTER YOUNG MIDDLE SCHOOL 4-2-24.dwg

SHEET: 07A OF 15

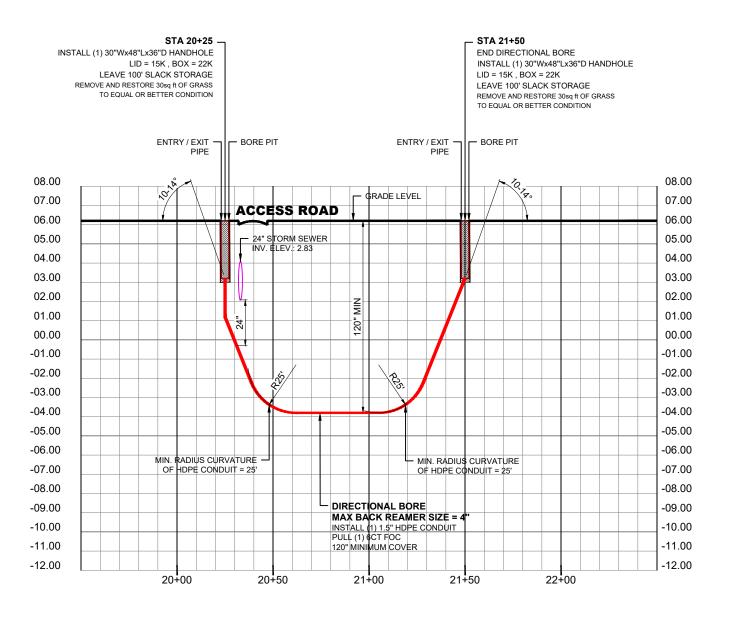

CROSS SECTION - ACCESS ROAD (LOOKING SOUTH)

HORIZONTAL SCALE: 1"=50' VERTICAL SCALE: 1"=5'

NOTE: AS A CONDITION OF PERMIT, ALL CROSSINGS OF THE PROPOSED DIRECTIONAL BORE AND/OR OPEN TRENCH INSTALLATION WITH CITY UTILITIES SHALL BE VERIFIED FOR CONFIRMATION OF MINIMUM VERTICAL SEPARATION REQUIREMENTS BY WAY "SOFT DIG" AND/OR EXCAVATION METHODS PRIOR TO THE START OF CONSTRUCTION. "USE EXTREME CAUTION WHEN EXCAVATING NEAR WATER AND SEWER SERVICES.


DITCH WITCH JT20 - SPECS ENTRY ANGLE 10-14° BEND RADIUS, MIN 107FT MIN DEPTH 3' 3" RECORD ON UTILITY PLANS CONSTRUCTION CONTRACTOR SHALL CALL LOCATES AND SOFT DIG TO DETERMINE UTILITY ELEVATION BEFORE CONSTRUCTION.



3				AS-BUILT			
2				REVISION # 1			
1	052824	KMV	AA	ORIGINAL			
NO	DATE	ENG DESIGN	DRAFTING	COMMENT			
	PEMBROKE PINES						
	JP.	PEMI	BROKE	PINES			
	HECKED BY:	,	ANO LEON	PINES			
C	HECKED BY:	GIULIA	ANO LEON				
C		GIULIA FIRM: KMV I	ANO LEON				
C E P	NGINEERING	GIULIA FIRM: KMV I BER: KMV-P	ANO LEON FIBERTELEO PP-24-002				

DRAWING NAME: KMV-PP-24-002 - FIRE STATION 89 TO WALTER YOUNG MIDDLE SCHOOL 4-2-24,dwg

SHEET: 07B OF 15

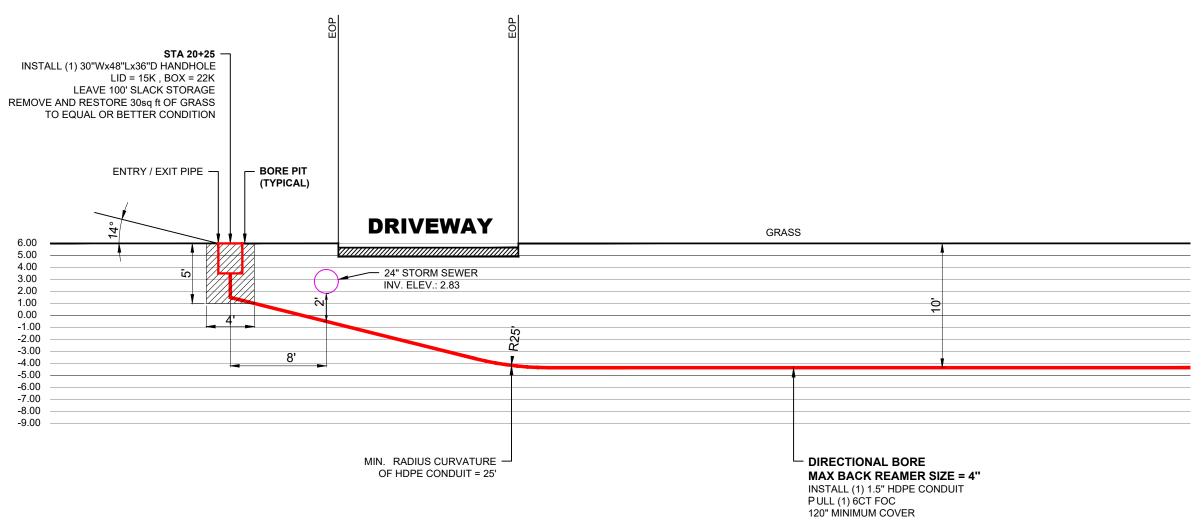

CROSS SECTION - ACCESS ROAD(LOOKING SOUTH)

HORIZONTAL SCALE: 1"=8'
VERTICAL SCALE: 1"=1'

NOTE: AS A CONDITION OF PERMIT, ALL CROSSINGS OF THE PROPOSED DIRECTIONAL BORE AND/OR OPEN TRENCH INSTALLATION WITH CITY UTILITIES SHALL BE VERIFIED FOR CONFIRMATION OF MINIMUM VERTICAL SEPARATION REQUIREMENTS BY WAY "SOFT DIG" AND/OR EXCAVATION METHODS PRIOR TO THE START OF CONSTRUCTION. "USE EXTREME CAUTION WHEN EXCAVATING NEAR WATER AND SEWER SERVICES.

DITCH WITCH JT20 - SPECS ENTRY ANGLE 10-14° BEND RADIUS, MIN 107FT MIN DEPTH 3' 3" RECORD ON UTILITY PLANS CONSTRUCTION CONTRACTOR SHALL CALL LOCATES AND SOFT DIG TO DETERMINE UTILITY ELEVATION BEFORE CONSTRUCTION.



J.		P	PEME	BROKE	PINES
	NO.	DATE	ENG DESIGN	DRAFTING	COMMENT
	1	052824	KMV	AA	ORIGINAL
	2				REVISION # 1
	3				AS-BUILT

CHECKED BY: GIULIANO LEON ENGINEERING FIRM: KMV FIBERTELEC

PROJECT NUMBER: KMV-PP-24-002 LOCATION: 901 NW 129TH AVE

PEMBROKE PINES, FL 33028
DRAWING NAME: KMV-PP-24-002 - FIRE STATION 89 TO WALTER YOUNG
MIDDLE SCHOOL 4-2-24,dwg

AL/PROPRIETARY SHEET: 07C OF 15

PHOTOGRAPHS

STA 0+00 -

REMOVE AND RESTORE 30sq ft OF CONCRETE SIDEWALK TO EQUAL OR BETTER CONDITION FULL FLAG RESTORATION JOINT TO JOINT BEGIN DIRECTIONAL BORE (2150')

STA 00+00 BEGIN DIRECTIONAL BORE



DIRECTIONAL BORE —
MAX BACK REAMER SIZE = 4"
INSTALL (1) 1.5" HDPE CONDUIT
PULL (1) 6CT FOC
120" MINIMUM COVER

STA 2+20 PROPOSED BORE PIT
REMOVE AND RESTORE 30sq ft OF GRASS
TO EQUAL OR BETTER CONDITION



STA 2+20 PROPOSED BORE PIT



INSTALL (1) 24"WX36"LX30"D HANDHOLE

LID = 15K , BOX = 22K

LEAVE 100' SLACK STORAGE

REMOVE AND RESTORE 30sq ft OF GRASS TO EQUAL OR BETTER CONDITION

STA 4+65 INSTALL PEMBROKE PINES HANDHOLE

DIRECTIONAL BORE
MAX BACK REAMER SIZE = 4"

INSTALL (1) 1.5" HDPE CONDUIT

W/FIBER OPTIC CABLE 120" MINIMUM COVER



STA 9+55 PROPOSED BORE TO GRASS
TO EQUAL OR BETTER CONDITION



STA 9+55 PROPOSED BORE PIT

STA 13+40 –
INSTALL (1) 30"Wx48"Lx36"D HANDHOLE
LID = 15K, BOX = 22K
LEAVE 100" SLACK STORAGE
REMOVE AND RESTORE 30sq ft OF GRASS
TO EQUAL OR BETTER CONDITION



STA 13+40 INSTALL PEMBROKE PINES HANDHOLE



ı	3				AS-BUILT
	2				REVISION # 1
	1	052824	KMV	AA	ORIGINAL
	NO.	DATE	ENG DESIGN	DRAFTING	COMMENT
		P	PEMI	3ROKE	PINES

CHECKED BY: GIULIANO LEON
ENGINEERING FIRM: KMV FIBERTELEC
PROJECT NUMBER: KMV-PP-24-002


LOCATION: 901 NW 129TH AVE
PEMBROKE PINES, FL 33028

DRAWING NAME: KMV-PP-24-002 - FIRE STATION 89 TO WALTER YOUNG MIDDLE SCHOOL 4-2-24.dwg

CONFIDENTIAL/PROPRIETARY SHEET: 08 0F 15


TYPICAL

BORE PIT RESTORATION DETAIL

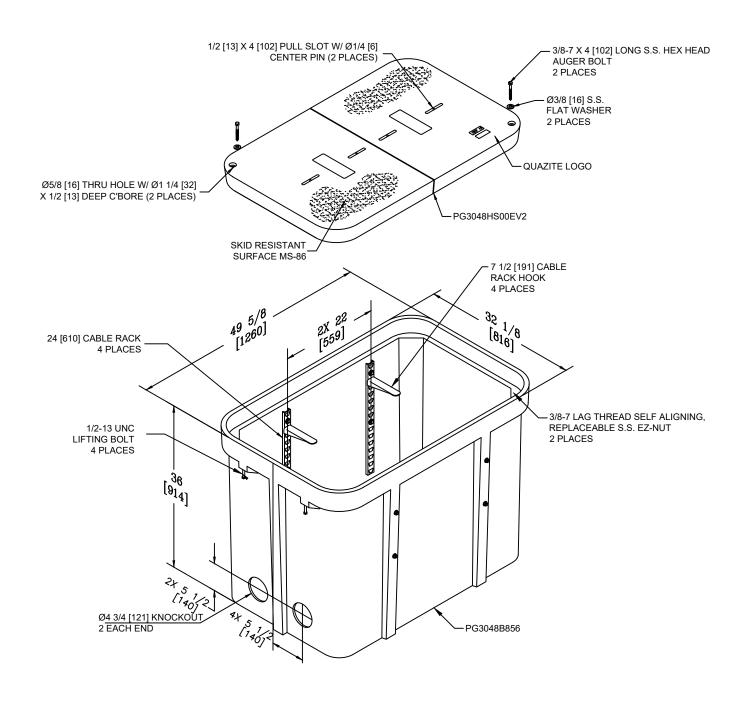

TYPICAL DETAIL - # 2

QUAZITE 30X48X36 ASSEMBLY
W/(4) 24" CABLE RACKS
& (4) 7 1/2" HOOKS
TIER 22 (15K DESIGN LOAD/ 22.5 TEST LOAD)
PG3048Z987EV2

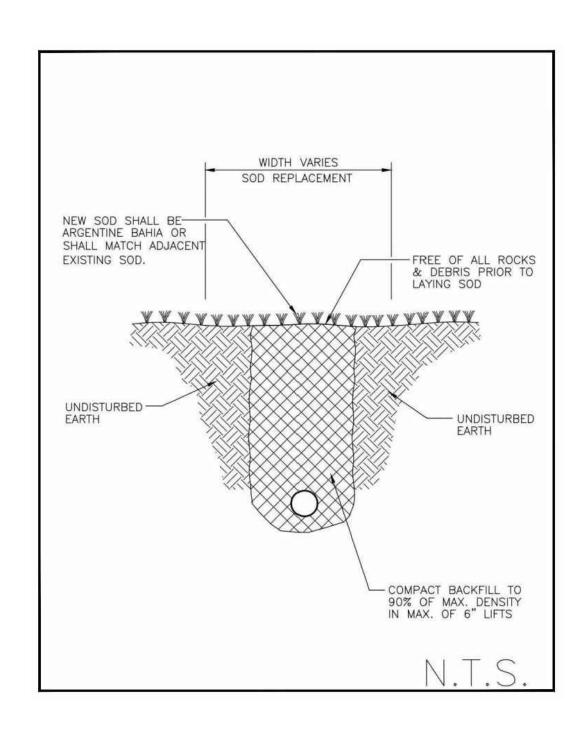

3				AS-BUILT
2				REVISION # 1
1	052824	KMV	AA	ORIGINAL
NO.	DATE	ENG DESIGN	DRAFTING	COMMENT
	كالأ			PINES
CHI	CKED BY:	GIULIA	NO LEON	
	ECKED BY:	GIULIA FIRM: KMV I	ANO LEON	COM INC
ENG	SINEERING		IBERTELEC	COM INC
ENG	GINEERING DJECT NUM CATION: 90	FIRM: KMV	P-24-002 AVE	
PRO	GINEERING DJECT NUM CATION: 90° PE	FIRM: KMV F BER: KMV-P 1 NW 129TH A MBROKE PIN IE: KMV-PP-244	P-24-002 AVE NES, FL 3302	28 ION 89 TO WALTER YOUNG

JR20 DIRECTIONAL DRILL SPECIFICATIONS

JT20 DIRECTIONAL DRILL

PERATION	U.S.	METRIC
Spindle speed, max	210 rpm	
Spindle torque, max	2,200 ft lb	2980 N m
Carriage thrust travel speed	140 fpm	43 m/min
Carriage thrust pullback travel speed	140 fpm	43 m/min
Thrust force	17,000 (6	75.6 kN
Pullbackforce	20,000 tb	89 KN
Bore diameter	4 in	102 mm
Ground travel speed		
Forwars/reverse	3.2 mph	5.2 km/h
OWER (TIER 4) (HRC)		
Engine	Deutz® TD2,9L4	
Fuel	Dieset	
Gooling medium	Liquid	
Injection	Direct	
Aspiration	Turbocharged	
Number of cylinders	4	
Displacement	12.7 in ^a	2.9 L
Bore	3.62 in	92 mm
Stroke	4.33 in	110 mm
Manufacturer's gross power rating	74 hp	55 KW
Rated speed	2,680 rpm	
Emissions compliance	EPATier4	EU Stage IIIB
OWER (TIER 41) (LRC)		
Engine	Deutz TD2 9L4	
Fuel	Diesel	
Ocolling medium	Liquid	
Injection	Direct	
Aspiration	Turbocharged	
Number of cylinders	4	
Displacement	17.7 in ^a	2.9 ℃
Bore	3.62 in	92 mm
Stroke	4,39 in	110 mm
Manufacturer's gross power rating	74 hp	55 kW
Rated speed	2,600 rpm	
Emissions compliance	EPA Fior 41	EU Stage III A

MENSIONS	U.S.	METRIC
Length	207 in	5.28 m
Width	51.5 in	1.31 m
Height	90 in	2.29 m
Weight w/pipe	11,890 lb	5390 kg
Entry angle	10-14°	
Angle of approach	189	
Angle of departure	18*	
RILLING FLUID SYST	EM (ONBO	ARD)
Pressure max	1,000 psi	69 bar
Flow, max	35 g pm	132 U/min
UID CAPACITIES		
Hydrautic reservoir	19 631	72L
Fueltank	30 gal	114 L
Engine oil w/filter	8.5 qt	8L
Engine cooling system	4.6 gal	17 L
OWER PIPE® HD		
Length of drill pipe, nominal	120 in	3.05 m
Diameter of drill pipe, tool joint end	2.63 m	66.8 mm
Diameter of drill pipe	2.06 in	52.3 mm
Bend radius, min	107 ft	32 m
Weight of dritt pipe, lines	67 tb	30,4 kg
WER PIPE FORGED HI	0	
Length	120 in	3.05 m
Diameter of drill pipe, tool joint end	2.5 in	63.5 mm
Diameter of drill pipe	2.10 in	53.3 mm
Bend radius, min	109 ft	33.2 m
OWER PIPE FORGED	HDX	
Length	120 in	3,05 m
Diameter of tool joint	2,63 in	66.8 mm
Diameter of drill pipe	2.38 in	60.5 mm
Bend radius, min	123 ft	37.5 m
ATTERY		
SAE reserve capacity rating	195 min	
SAE cold crank rating (8.0°F (-18°C)	950 a mps	

JT20 Operator's Manual Plan Bore Path

Bend Radius

JT20 Power Pipe® HD drill pipes have a tested minimum bend radius of 107' (32.6 m). This means that a 90-degree bend in the bore path:

- has a radius (A) of 107' (32.6 m)
- requires approximately 168' (51.2 m) of drill pipe (B).

JT20 Ditch Witch[®] Forged HD drill pipes have a tested minimum bend radius of 109' (33.2 m). This means that a 90-degree bend in the bore path:

- has a radius (A) of 109' (33.2 m)
- requires approximately 171' (52.1 m) of drill pipe (B).

JT20 Forged drill pipes have a tested minimum bend radius of 108' (32.9 m). This means that a 90-degree bend in the bore path:

- has a radius (A) of 108' (32.9 m)
- requires approximately 170' (51.8 m) of drill pipe (B).

NOTICE: Bending drill pipe more sharply than recommended will damage the pipe and cause failure over time.

- · If bend radius is reduced, drill pipe life is reduced.
- If bend radius is increased, drill pipe life is increased.

IMPORTANT: Use the charts on the next page to keep bends within safe limits.

JT20 Operator's Manual Plan Bore Path

Minimum Depth

Prepare - 69

Because you must bend pipe gradually, entry pitch and bend limits determine how deep the pipe will be when it becomes horizontal. This is called the **minimum depth**.




Prepare - 73

- To reduce minimum depth (D1), reduce entry pitch. This also decreases setback.
- To increase minimum depth (D2), increase entry pitch. This also increases setback.

Bore Path Calculator

Entry pitch, setback, and minimum depth work together with bend limits to determine the bore path. To find the setback (B) and entry pitch (A) that will take you to the desired minimum depth (D), use the chart below.

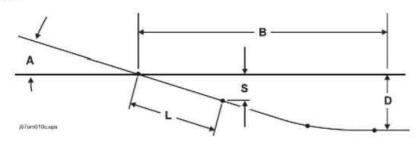


IMPORTANT: Numbers in table based on **drill pipe minimum bend radius**, beacon housing, EZ-Connect, connector, transition sub, and 1/3 of first drill pipe (L, totaling 8' 8" [2.6 m]) in the ground before

Power Pipe® HD

Minimum depth (D)	Entry pitch (A)	Setback (B)	Depth to begin steering (S)
3 ft 3 in (1 m)	-18%	27 ft 6 in (8.4 m)	1 ft 7 in (0.48 m)
3 ft 10 in (1.2 m)	-20%	29 ft 6 in (9 m)	1 ft 9 in (0.53 m)
4 ft 5 in (1.3 m)	-22%	31 ft 6 in (9.6 m)	1 ft 11 in (0.58 m)
5 ft 0 in (1.5 m)	-24%	33 ft 5 in (10.2 m)	2 ft 1 in (0.64 m)
5 ft 8 in (1,7 m)	-26%	35 ft 4 in (10.8 m)	2 ft 3 in (0.69 m)

3				AS-BUILT
2				REVISION # 1
1	052824	KMV	AA	ORIGINAL
NO.	DATE	ENG DESIGN	DRAFTING	COMMENT

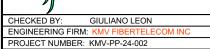



LOCATION: 901 NW 129TH AVE PEMBROKE PINES, FL 33028

DRAWING NAME: KMV-PP-24-002 - FIRE STATION 89 TO WALTER YOUNG MIDDLE SCHOOL 4-2-24.dwg

CONFIDENTIAL/PROPRIETARY SHEET: 10 OF 15

PEMBROKE PINES

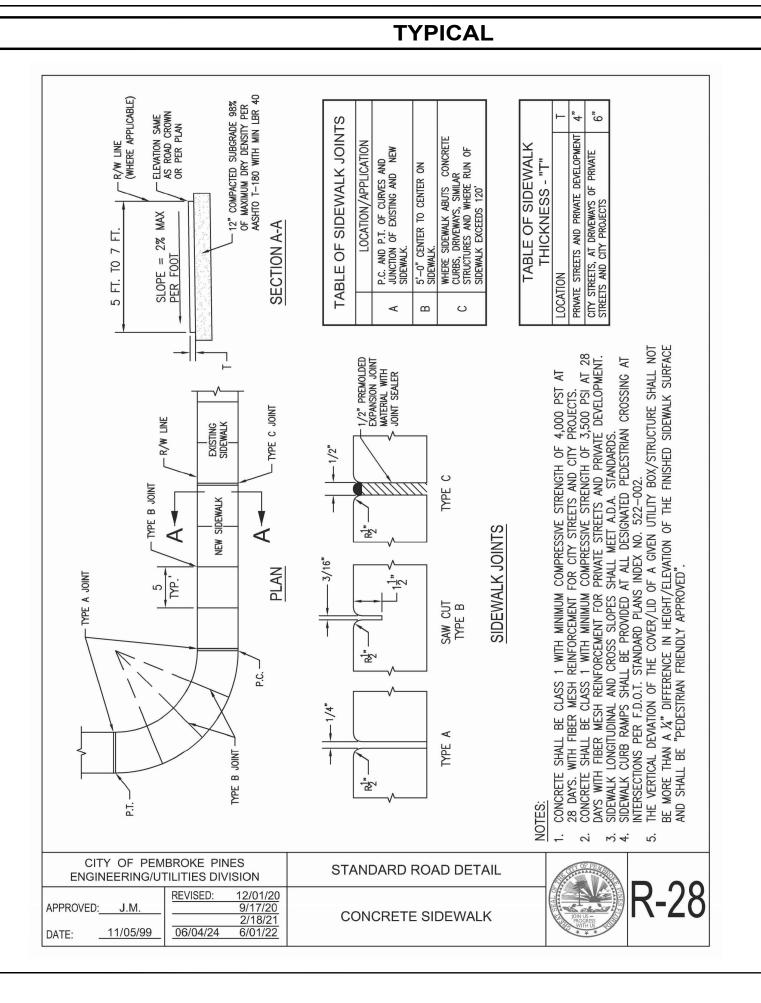

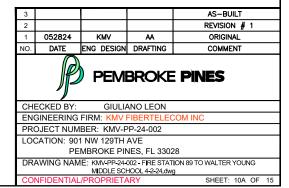

SHEET	TABLE OF CONTENTS			
1	General Notes, TTC Tables			
	Definitions			
	Temporary Traffic Control Devices			
	Overhead Work			
2	Railroads			
	Sight Distance			
	Above Ground Hazard			
	Clear Zone Widths For Work Zones			
	Superelevation			
	Length Of Lane Closures			
3	Overweight/Oversize Vehicles			
	Lane Widths			
	High-Visibility Safety Apparel			
	Speed Reduction Signing			
	Flagger Control			
4	Survey Work Zones			
	Signs			
5	Work Zone Sign Supports			
6	Commonly Used Warning and Regulatory Signs In Work Zones			
	Manholes/Crosswalks/Joints			
	Truck Mounted Attenuators			
7	Signals			
	Channelizing Devices			
	Channelizing Devices Consistency			
	Advanced Warning Arrow Boards			
8	Drop-Offs In Work Zones			
9	Business Entrance			
	Temporary Asphalt Separator			
10	Channelizing Devices Notes			
10	Temporary Barrier Notes			
11	Pavement Markings			

GENERAL NOTES:

- 1. This Index contains information specific to the Federal and State guidelines and standards for the preparation of traffic control plans and for the execution of traffic control in work zones, for construction and maintenance operations and utility work on highways, roads and streets on the State Highway System. Certain requirements in this Index are based on the high volume nature of State Highways. For highways, roads and streets off the State Highway System, the local agency (City/County) having jurisdiction may adopt requirements based on the minimum requirements provided in the MUTCD.
- 2. Use this Index in accordance with the Plans and Indexes 102-601 through 102-680. Indexes 102-601 through 102-680 are Department-specific typical applications of commonly encountered situations. Adjust device location or number thereof as recommended by the Worksite Traffic Supervisor and approved by the Engineer. Devices include, but are not limited to, flaggers, portable temporary signals, signs, pavement markings, and channelizing devices. Comply with MUTCD or applicable Department criteria for any changes and document the reason for the change.
- 3. Except for emergencies, any road closure on State Highway System must comply with Section 335.15, F.S.

		TABLE	= 1	
CHA	NNELIZ	ING DE	VICE SP	ACING
147 DEGUE		Max.	Spacing (fee	t)
Work Zone Speed (mph)		es or oorary Markers	Type I I Type II Vertical Par	Barricades, Barricades, Jels, or Drums
,	Taper	Tangent	Taper	Tangent
≤ 45	25	50	25	50
≥ 50	25	50	50	100

TAB	LE 2
TAPER LE	NGTH "L"
Work Zone Speed (mph)	Min. Length (feet)
≤ 40	$L = \frac{WS^2}{60}$
≥ 45	L = W5
is	idth of offset n feet need in mph

TABL	E 3
WORK ZONE SIG	N SPACING "X"
Road Type	Min. Spacing (feet)
Arterials and Collectors with Work Zone Speed ≤ 40 mph	200
Arterials and Collectors with Work Zone Speed ≥ 45 mph	500
Limited Access Roadways *	1,500
* For Limited access roadways mph, the minimum spacing ma with the MUTCD and as appr	y be reduced in accordance

BUFFER L	ENGTH "B"
Work Zone Speed (mph)	Min. Length (feet)
25	155
30	200
35	250
40	305
45	360
50	425
55	495
60	570
65	645
70	730

cannot be attained due to geometric constraints, use the greatest length possible, but not less than 155 feet.

REVISION 11/01/20

≥ DESCRIPTION:

FDOT

FY 2023-24 STANDARD PLANS

GENERAL INFORMATION FOR TRAFFIC CONTROL THROUGH WORK ZONES

INDEX 102-600

SHEET 1 of 11


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2				REVISION # 1
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NO.	DATE	ENG DESIGN	DRAFTING	COMMENT




GIULIANO LEON ENGINEERING FIRM: K

PROJECT NUMBER: KMV-PP-24-002 LOCATION: 901 NW 129TH AVE

PEMBROKE PINES, FL 33028 DRAWING NAME: KMV-PP-24-002 - FIRE STATION 89 TO WALTER YOUNG MIDDLE SCHOOL 4-2-24.dwg

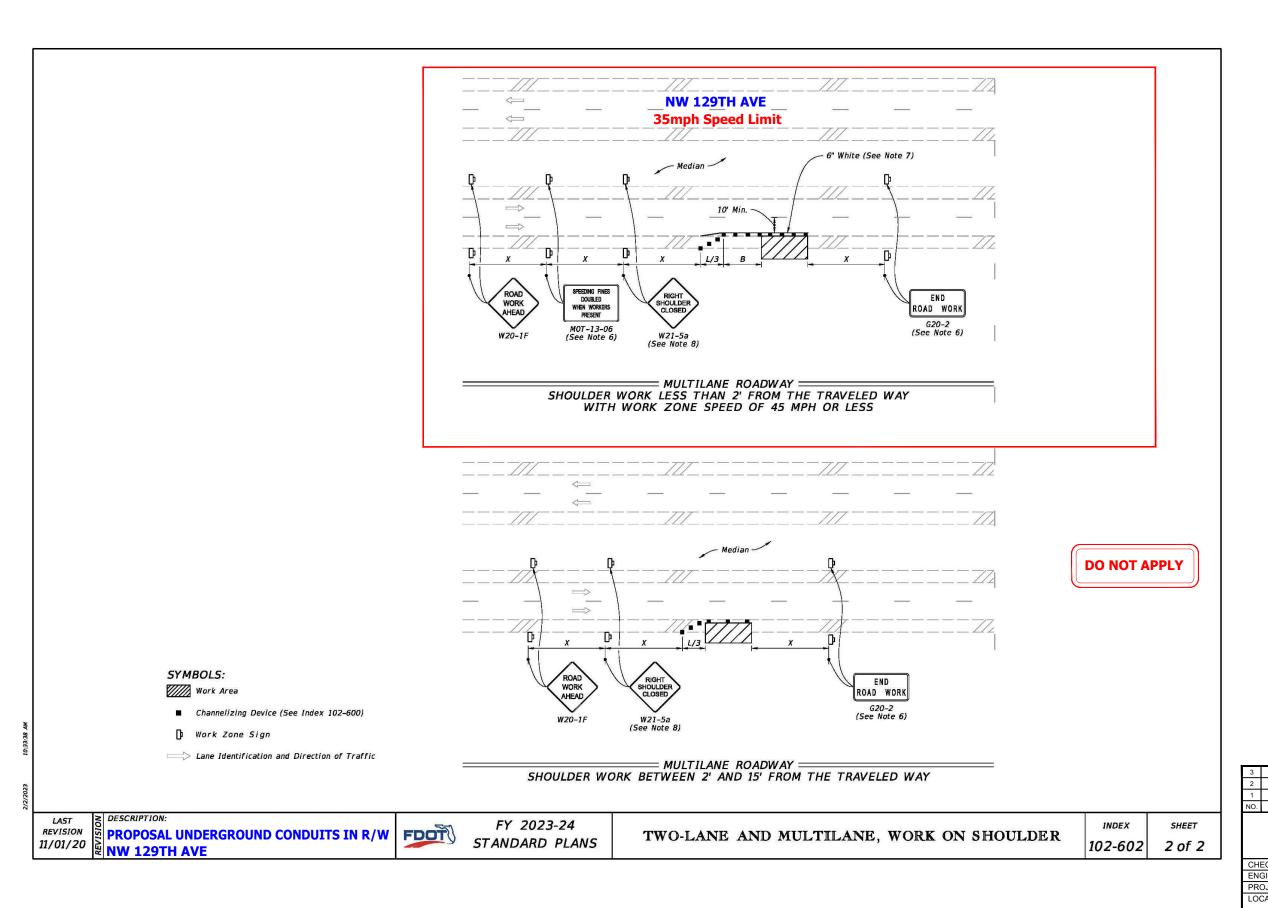

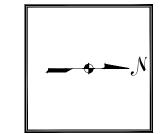


KMV ENG DESIGN	AA DRAFTING	REVISION # 1 ORIGINAL COMMENT	_
KMV	AA		_
		REVISION # 1	
		AS-BUILT	
			AS-BUILT




PEMBROKE **PINES**

ENGINEERING FIRM: 1 PROJECT NUMBER: KMV-PP-24-002 LOCATION: 901 NW 129TH AVE PEMBROKE PINES, FL 33028

DRAWING NAME: KMV-PP-24-002 - FIRE STATION 89 TO WALTER YOUNG MIDDLE SCHOOL 4-2-24.dwg

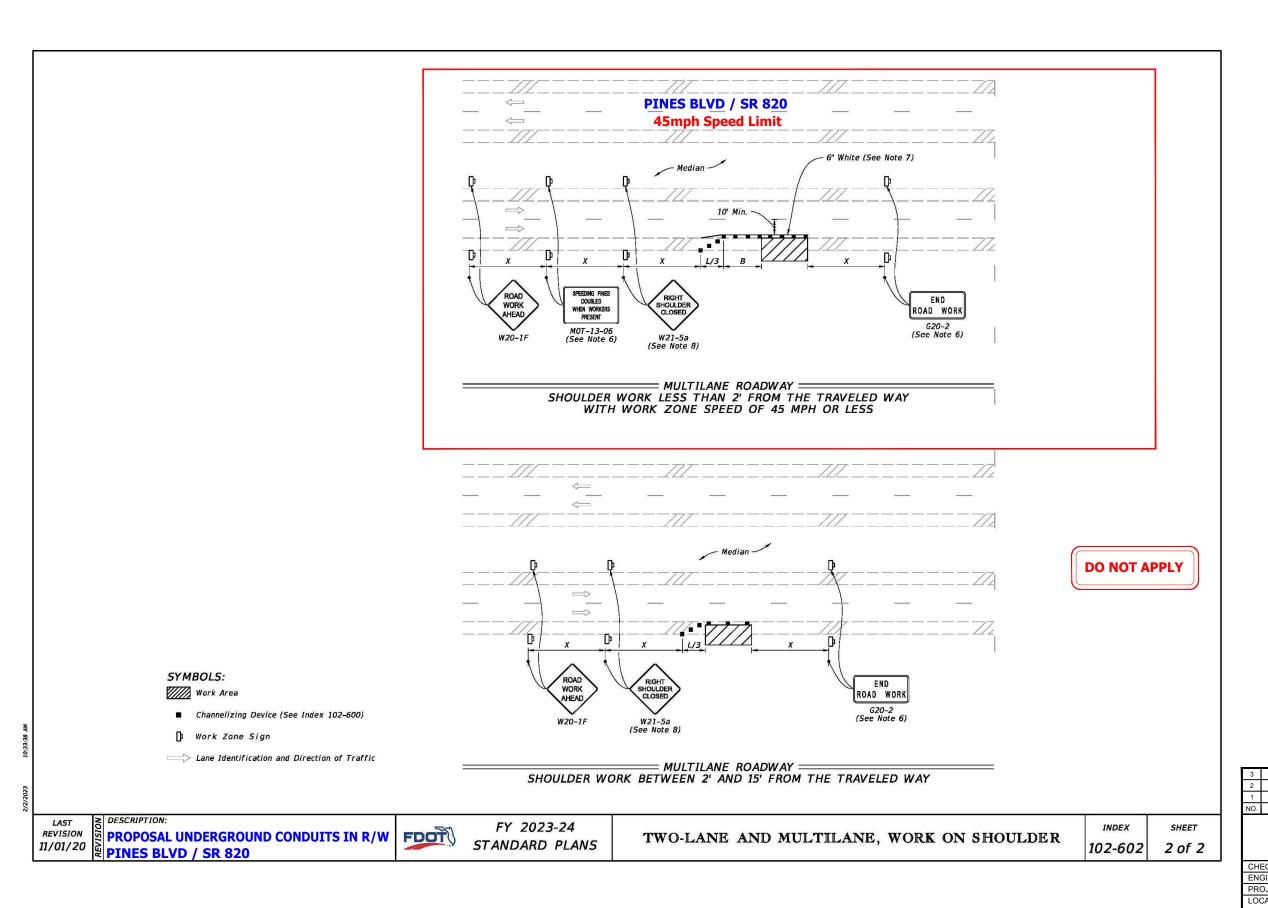

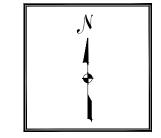

NO.	DATE	ENG DESIGN	DRAFTING	COMMENT
1	052824	KMV	AA	ORIGINAL
2				REVISION # 1
З				AS-BUILT





PEMBROKE **PINES**


CHECKED BY: GIULIANO LEON
ENGINEERING FIRM: KMV FIBERTELECOM INC
PROJECT NUMBER: KMV-PP-24-002
LOCATION: 901 NW 129TH AVE
PEMBROKE PINES, FL 33028

DRAWING NAME: KMV-PP-24-002 - FRE STATION 89 TO WALTER YOUNG
MIDDLE SCHOOL 4-2-24.dwg

SHEET: 13 OF 15

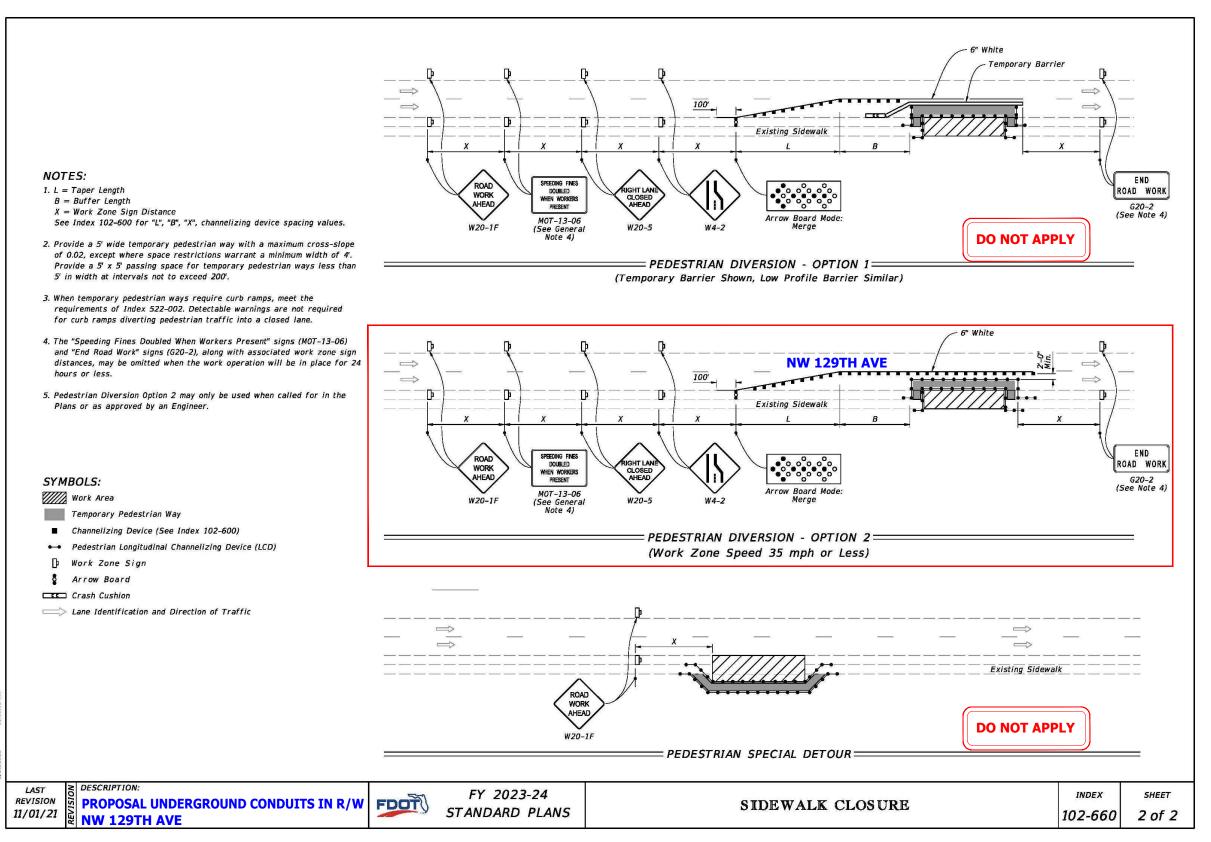

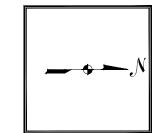

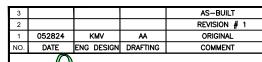




CHECKED BY: GIULIANO LEON
ENGINEERING FIRM: KMV FIBERTELECOM IN
PROJECT NUMBER: KMV-PP-24-002

LOCATION: 901 NW 129TH AVE PEMBROKE PINES, FL 33028

DRAWING NAME: KMV-PP-24-002 - FIRE STATION 89 TO WALTER YOUNG MIDDLE SCHOOL 4-2-24.dwg

CONFIDENTIAL/PROPRIETARY SHEET: 14 OF 15

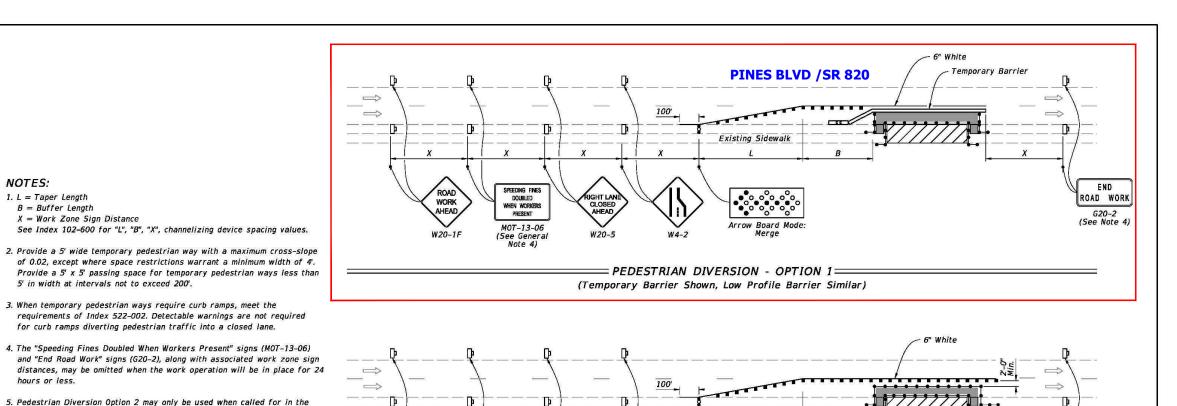

SYMBOLS:

NOTES: 1. L = Taper Length

B = Buffer Length

X = Work Zone Sign Distance

5' in width at intervals not to exceed 200'.

Work Area

Temporary Pedestrian Way

Plans or as approved by an Engineer.

■ Channelizing Device (See Index 102-600)


•• Pedestrian Longitudinal Channelizing Device (LCD)

Work Zone Sign


Arrow Board

Crash Cushion

Lane Identification and Direction of Traffic

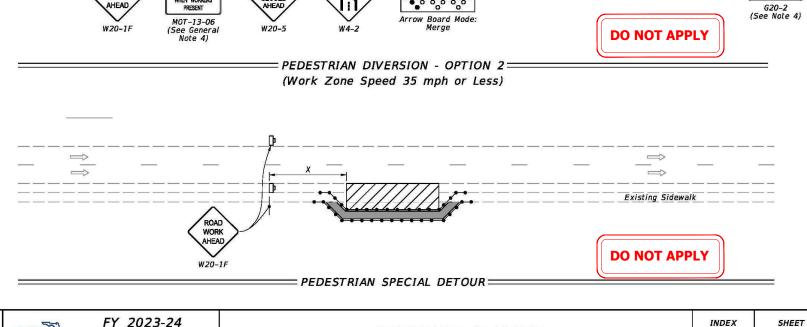



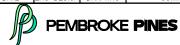

ENGINEERING FIRM: 1 PROJECT NUMBER: KMV-PP-24-002 LOCATION: 901 NW 129TH AVE PEMBROKE PINES EL 33028

DRAWING NAME: KMV-PP-24-002 - FIRE STATION 89 TO WALTER YOUNG MIDDLE SCHOOL 4-2-24 dwg

SHEET: 15 OF 15

PROPOSAL UNDERGROUND CONDUITS IN R/W FDOT PINES BLVD /SR 820

FY 2023-24 STANDARD PLANS

SPEEDING FINES DOUBLED WHEN WORKERS PRESENT

SIDEWALK CLOSURE

102-660

2 of 2


ROAD WORK

LAST REVISION 11/01/21

PROJECT: KMV-PP-24-002 - FIRE STATION 89 TO WALTER YOUNG MIDDLE SCHOOL 4-2-24 ADDRESS: 901 NW 129TH AVE, PEMBROKE PINES, FL 33028 - FDOT PERMIT




LINETYPES

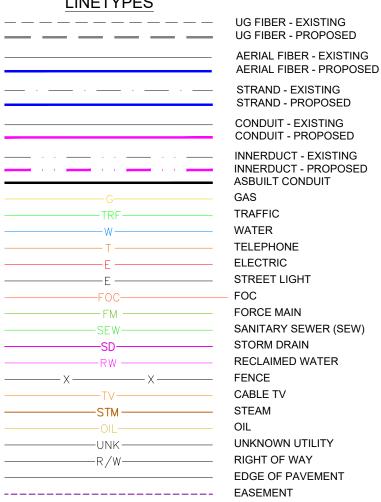



SITE LOCATION

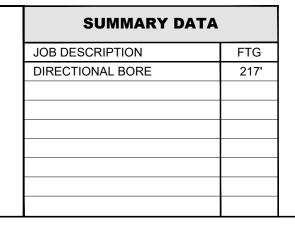

PERMITTING JURISDICTION: * FDOT

TWP: 51S **DATE SUBMITTED** 05/28/24

RNG: 40E SEC:14

Know what's below.

PLAT BOOK: -PAGE: -

CONTACTS

PEMBROKE PINES

JOHN L.ENGLAND **DESIGN ENGINEER**

PHONE: (954) 518-8905 JENGLAND@PPINES.COM

KMV FIBERTELECOM INC

SANDRA KARINA VARGAS 10604 NW 48TH ST

CORAL SPRINGS FL 33076

PHONE: 954-937-5239 KARINAV@KMVFIBERTELECOM.COM

SITE INDEX


01 OF 06 - COVER SHEET/SITE LOCATION 02 OF 06 - OVERALL MAP 03 OF 06 TO 04 OF 06 - CONSTRUCTION NOTES 05 OF 06 TO 05A OF 06 - PLAN VIEWS & PROFILES 06 OF 06 - PHOTOGRAPHS

3				AS-BUILT		
2	071524	KMV	RC	REVISION # 1		
1	052824	KMV	AA	ORIGINAL		
NO.	DATE	ENG DESIGN	DRAFTING	COMMENT		



PEMBROKE **PINES**

PROJECT NUMBER: KMV-PP-24-002 LOCATION: 901 NW 129TH AVE PEMBROKE PINES EL 33028 DRAWING NAME: KMV-PP-24-002 - FIRE STATION 89 TO WALTER YOUNG MIDDLE SCHOOL 4-2-24.dwg

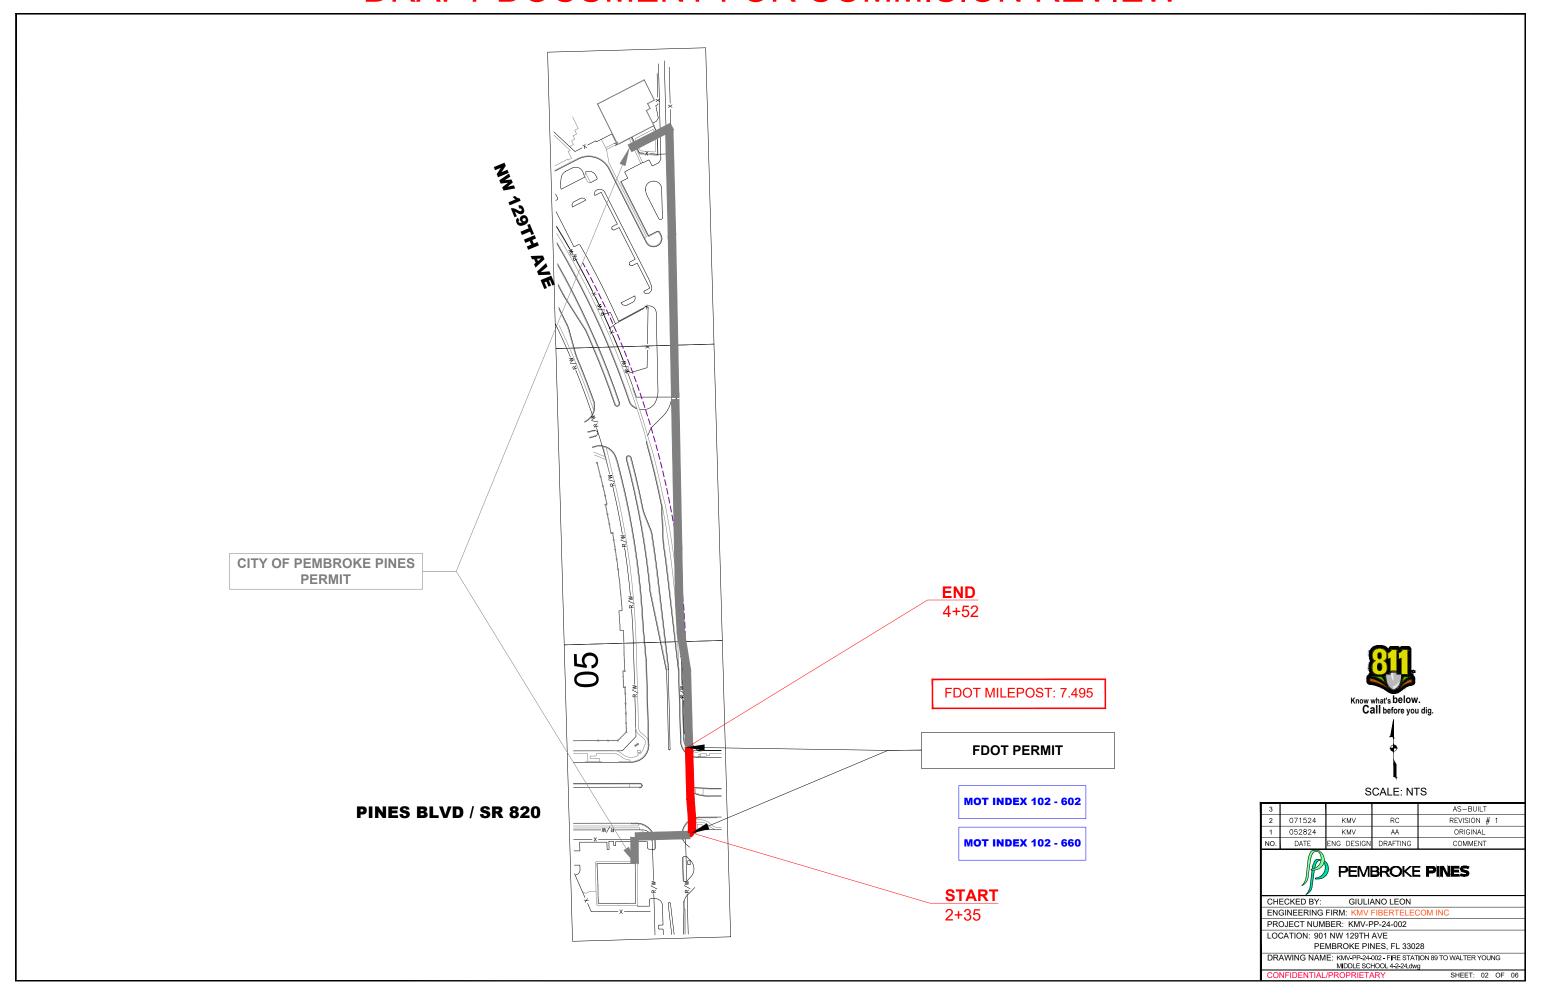

CONSTRUCTION NOTES

TYPICAL UNDERGROUND CONSTRUCTION:

- RESTORE ALL SURFACES TO EQUAL OR BETTER CONDITION.
- CONTRACTOR TO VERIFY LOCATION AND CONDITION OF EXISTING CONDUIT PRIOR TO CONSTRUCTION.
- CONTRACTOR SHALL VERIFY ALL PLANS, EXISTING DIMENSIONS AND CONDITIONS ON THE JOB SITE AND IMMEDIATELY NOTIFY THE ENGINEER IN WRITING OF ANY DISCREPANCIES BEFORE PROCEEDING WITH THE WORK.
- MAINTAIN MINIMUM 24" VERTICAL AND HORIZONTAL SEPARATION BETWEEN PROPOSED BY PEMBROKE PINES DUCTS & EXISTING UTILITIES.
- MAINTAIN A MIN BENDING RADIUS OF 5' ON ALL DUCT CONFIGURATION.
- ANY CHANGES ON PROPOSED RUNNING LINE HAVE TO GET APPROVAL FROM PEMBROKE PINES CONSTRUCTION MANAGER.

FOR CONSTRUCTION:

- EXTREME CAUTION TO BE TAKEN TO CONTAIN SLURRY AROUND WORK AREAS NEAR WETLANDS TO AVOID ANY WATER QUALITY ISSUES!
- LOCATIONS, ELEVATIONS LOCATIONS, ELEVATIONS AND DIMENSIONS OF EXISTING UTILITIES, STRUCTURES AND OTHER SITE FEATURES SHOWN ON THE DRAWINGS ARE BASED ON LIMITED INVESTIGATION TECHNIQUES AND SHOULD BE CONSIDERED APPROXIMATE ONLY. PLEASE CONTACT SUNSHINE STATE ONE-CALL AT 1-800-432-4770
- CAUTION: EXISTING UNDERGROUND UTILITIES IN AREA. NO ELEVATION RECORDS FOR EXISTING UTILITIES AVAILABLE. CONTRACTOR SHOULD CONTACT SUNSHINE 811, LOCATE ALL UTILITIES AND VERIFY ALL DEPTHS PRIOR TO CONSTRUCTION

#121405467

3				AS-BUILT
2	071524	KMV	RC	REVISION # 1
1	052824	KMV	AA	ORIGINAL
NO.	DATE	ENG DESIGN	DRAFTING	COMMENT



GIULIANO LEON

ENGINEERING FIRM: KN PROJECT NUMBER: KMV-PP-24-002

LOCATION: 901 NW 129TH AVE PEMBROKE PINES, FL 33028

DRAWING NAME: KMV-PP-24-002 - FIRE STATION 89 TO WALTER YOUNG MIDDLE SCHOOL 4-2-24,dwg

SHEET: 03 OF 06

CONSTRUCTION NOTES - FDOT


- EXISTING F.D.O.T. DRAINAGE SYSTEM SHALL BE PROTECTED AT ALL TIMES BY THE PERMITTEE. ANY DAMAGE TO THE F.D.O.T. DRAINAGE SYSTEM (STRUCTURES OR PIPES) SHALL BE REPAIRED/REPLACED BY THE PERMITTEE AT NO COST TO THE DEPARTMENT.
- EXISTING GAS MAIN SHALL BE PROTECTED AT ALL TIMES DURING EXCAVATION, DRILLING AND CONDUIT INSTALLATION ACTIVITIES. UTILITY GAS COMPANY SHALL BE PRESENT AT THE PRE-CONSTRUCTION MEETING AND GIVE WRITTEN CLEARANCE PRIOR TO COMMENCEMENT OF ANY PERMIT OPERATIONS.
- ANY DAMAGE TO CONCRETE SIDEWALK, CURB AND GUTTER, PEDESTRIAN CURB RAMPS, AND TRAFFIC SEPARATORS SHOULD BE RESTORED PER FDOT STANDARDS PLANS INDEX NO. 522-002, AND 520-002, ADA STANDARDS, AND FDOT STANDARD SPECIFICATION 522.


 DAMAGED SIDEWALK, CURB AND GUTTER, AND TRAFFIC SEPARATORS SHALL BE RESTORED WITH FULL FLAGS/JOINT TO JOINT AT THE PERMITTEES EXPENSE; PATCHING IS NOT PERMITTED. IMPACTED PEDESTRIAN RAMPS SHALL BE REPLACED COMPLETELY; HANDHOLES MUST NOT BE LOCATED WITHIN PEDESTRIAN RAMPS. MAKE SURE TO FURNISH APPROPRIATE EXPANSION JOINTS PER FDOT STANDARDS PLANS INDEX 350-001. IMPACTED DETECTABLE WARNING SURFACES NEED TO BE RESTORED IN ACCORDANCE WITH FDOT STANDARD PLANS INDEX NO. 522-002 AND SPECIFICATION 527
- HANDHOLES AND PULL BOXES SHALL NOT BE INSTALLED WITHIN THE FOOTPRINT OF EXISTING PEDESTRIAN ADA CURB RAMP NEITHER DRIVEWAY ENTRY AREA. REFER TO PPM, VOL. 2, CH. 8, SECTION 8.3.2 REGARDING NONSLIP TOP SURFACE IF THE HAND HOLE IS PROPOSED WITHIN PEDESTRIAN CURB RAMP, DO NOT INSTALL NEW HH AT LEAST 10' FROM ADA CURB RAMPS, FIRE HYDRANTS, BUS BOOTH-BENCHES
- WHERE PEDESTRIAN FACILITIES ARE DETOURED, BLOCKED, OR CLOSED DURING THE WORK, PLEASE ENSURE TO PROVIDE SAFE ALTERNATE ACCESSIBLE ROUTES THROUGH OR AROUND THE WORK ZONE THAT MEETS THE REQUIREMENTS OF THE ADA STANDARDS AND FDOT STANDARD PLAN INDEX 102-660
- RESTORATION OF SODDING AND TURF SHOULD BE DONE ACCORDING TO FDOT 2023-2024 STANDARD INDEX No 570-001.
- PROVIDE PROTECTION TO THE EXISTING TREES AND AVOID ANY IMPACT TO THE ROOTS. WHEN CONSTRUCTION AFFECTS TREE ROOTS OR CANOPY, PROVIDE TRIMMING PER FDOT STANDARD PLANS INDEX 110-100.
- PROVIDE APPROPRIATE EROSION CONTROL DEVICES DURING CONSTRUCTION.
- LANDSCAPING, TREES, SOD SHALL BE REPLACED AT THE COST OF THE PERMITTEE
- THE CONTRACTOR SHALL COORDINATE WITH BROWARD COUNTY DEPARTMENT OF TRANSPORTATION AND PUBLIC WORKS (DTPW), TRAFFIC SIGNALS & SIGNS DIVISION AT LEAST 5 WORKING DAYS PRIOR TO ANY WORK DONE AT SIGNALIZED INTERSECTIONS, WHICH EITHER CLOSE ANY LANES. NEED CHANGES IN THE SIGNAL OPERATION OF TIMING, DAMAGE OR HINDER ANY SIGNAL SENSOR, OR DAMAGE ANY CABLE OR SIGNAL EQUIPMENT.
- PERMITTEE IS RESPONSIBLE FOR LOCATING ALL UNDERGROUND FACILITIES PRIOR TO DIRECTIONAL DRILLING/TRENCH WORK AND ASSUMES ALL RESPONSIBILITY FOR ANY DAMAGE DONE TO UNDERGROUND FACILITIES AND ABOVE GROUND FACILITIES. DIRECTIONAL BORING SHALL BE CONDUCTED ACCORDING TO LATEST SECTION 555 OF FDOT'S STANDARD SPECIFICATIONS AND 3.16.9.1 OF THE 2017 U.A.M. OPEN TRENCH SHALL BE CARRIED OUT PER 3.16.4. OF 2017 U.A.M
- CONDUIT INSTALLATION SHALL ADHERE TO THE LATEST FDOT STANDARD PLANS INDEX NO. 630-001
- ACCORDING TO SECTION 3.10 OF 2017 U.A.M, WHEN UNDERGROUND AND AERIAL UTILITIES OCCUPY THE SAME ROADSIDE, UNDERGROUND UTILITIES SHALL NOT BE PLACED WITHIN THREE (3) FEET OF THE R/W LINE.
- DAMAGED SIDEWALK, CURB AND GUTTER, AND TRAFFIC SEPARATORS SHALL BE RESTORED WITH FULL FLAGS/JOINT TO JOINT AT THE PERMITTEES EXPENSE; PATCHING IS NOT PERMITTED. RESTORATION SHALL MATCH EXISTING CONCRETE PATTERN, PAVERS, AND COLOR. IMPACTED PEDESTRIAN RAMPS AND DRIVEWAYS SHALL BE REPLACED COMPLETELY. INCLUDE 1 FOOT OF LEVEL EMBANKMENT FOR EROSION AND ENSURE TO NOT CREATE ANY DROP OFF HAZARDS AS SHOWN ON FDM FIGURE 222.4.1. IMPACTED DETECTABLE WARNING SURFACES NEED TO BE RESTORED IN ACCORDANCE WITH FDOT STANDARD PLANS INDEX NO. 522-002 AND SPECIFICATION 527
- PROPOSED HANDHOLES MUST ADHERE TO LATEST FDOT STANDARD PLANS INDEX NO. 635-001". ENSURE ALL HANDHOLE LIDS ON SIDEWALK ARE FLUSH AND ADA COMPLIANT. MAINTAIN THE TEMPORARY PATCHES AROUND THE HANDHOLE BOX EDGES AND/OR ANYWHERE ELSE WHERE SIDEWALK HAS BEEN IMPACTED/DAMAGED BY THE DB WORK OR UTILITY INSTALLATION, SO IT PROVIDES A SMOOTH -ALL WEATHER SURFACES ALWAYS. ONCE THE HANDHOLE IS INSTALLED THE LID MUST BE KEPT IN PLACE, BOLTED, AND SECURED.
- TEMPORARY BARRIERS FOR PEDESTRIAN DETOURS MUST COMPLY WITH THE LATEST FDOT STANDARD PLANS INDEX NO. 102-100.
- RESTORATION OF SODDING AND TURF SHOULD BE DONE ACCORDING TO FDOT 2023-24 DESIGN STANDARDS INDEX 570-010.
- PERMITTEE MUST TAKE PICTURES OF THE EXISTING STREET LIGHTNING SYSTEM WORKING-DURING NIGHT-TIME-WITHIN THE LIMITS OF THIS PROPOSED JOB PRIOR TO BEGIN SAID WORK. TO AVOID FUTURE DISPUTE ABOUT UNFORESEEN DAMAGES TO THE LIGHTNING SYSTEM

 SYSTEM

 ON THE PROPOSED SYSTEM SYSTE
- CONTAMINATED SITES LOCATED WITHIN A 500-FOOT RADIUS OF THE PROJECT AREA THAT COULD IMPACT THE FDOT ROW HAVE BEEN IDENTIFIED. THE PERMITTEE SHALL ASSURE THAT ANY ACTIONS CARRIED OUT ARE IN ACCORDANCE WITH ALL ENVIRONMENTAL REGULATORY REQUIREMENTS.
- ANY ABOVEGROUND FEATURES THAT MAY BE IMPACTED BY PROPOSED WORK MUST BE IDENTIFIED TO BE ADJUSTED/RELOCATED/REPLACED. IF SIGNS ADD ARE DAMAGED, THESE MUST BE REPLACED ACCORDING THE LATEST FDOT STANDARD PLANS INDEX NO. 700-101. ENSURE LATERAL OFFSET AND CLEAR ZONE STANDARDS ARE BEING ADHERED TO.

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2	071524	KMV	RC	REVISION # 1				
1	052824	KMV	A	ORIGINAL				
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PEMBROKE PINES								
CHI	ECKED BY:	GIULIA	ANO LEON					
ENG	SINEERING	FIRM: KMV I	FIBERTELEC	COM INC				
PROJECT NUMBER: KMV-PP-24-002								
LOCATION: 901 NW 129TH AVE PEMBROKE PINES, FL 33028								
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PROFILE - NW 129TH AVE (LOOKING WEST)

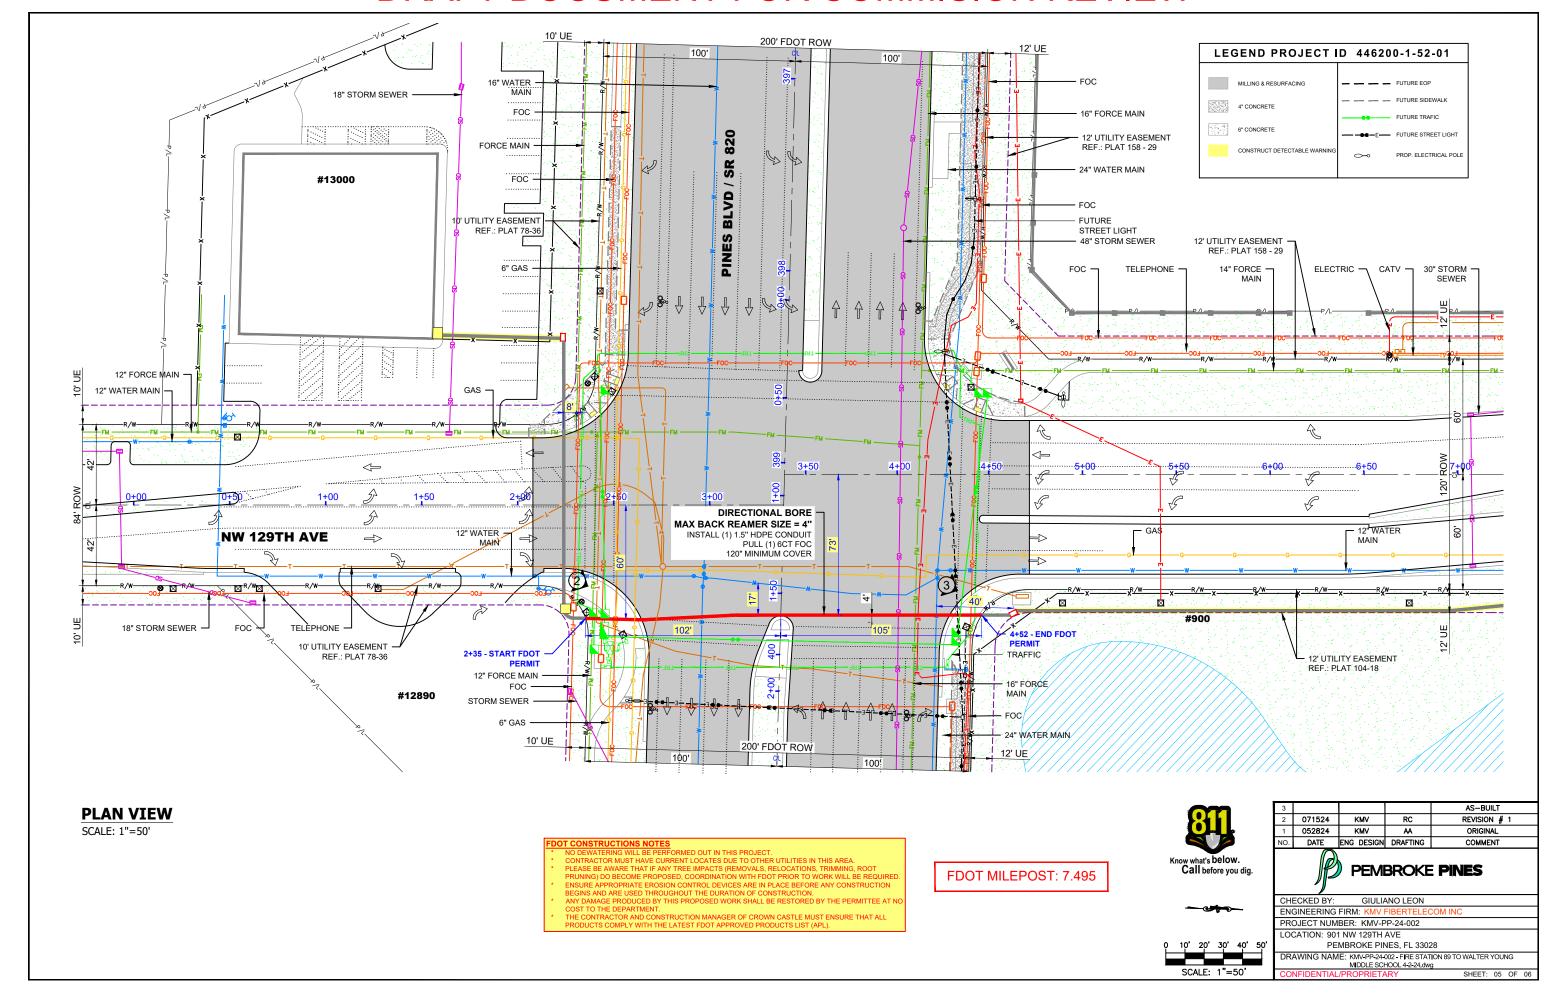HORIZONTAL SCALE: 1"=50' VERTICAL SCALE: 1"=5'
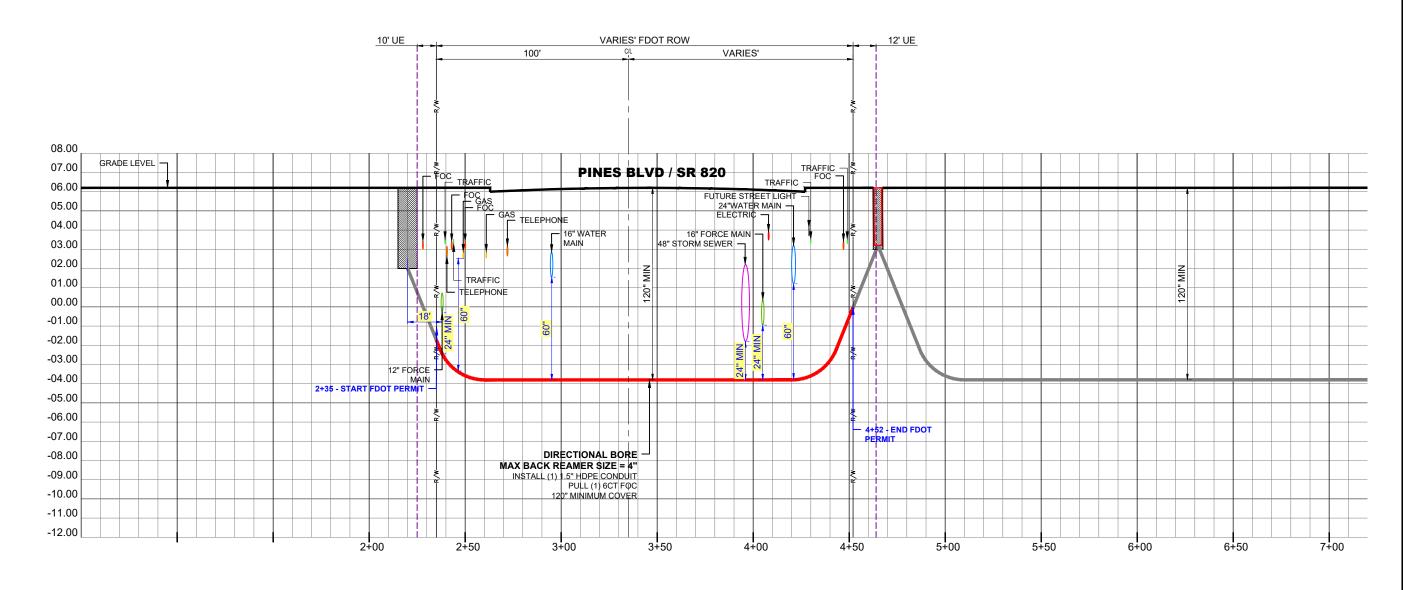
> RECORD ON UTILITY PLANS CONSTRUCTION CONTRACTOR SHALL CALL LOCATES AND SOFT DIG TO DETERMINE UTILITY ELEVATION BEFORE CONSTRUCTION.



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	# 1	REVISION #	RC	KMV	071524	2
		ORIGINAL	AA	KMV	052824	1
NO. DATE ENG DESIGN DRAFTING COMMEN	Т	COMMENT	DRAFTING	ENG DESIGN	DATE	NO.

PEMBROKE PINES

ENGINEERING FIRM: KMV FIBERTELECOM INC
PROJECT NUMBER: KMV-PP-24-002

PROJECT NUMBER: KMV-PP-24-002

LOCATION: 901 NW 129TH AVE

PEMBROKE PINES, FL 33028

DRAWING NAME: KMY-PP-24-002 - FIRE STATION 89 TO WALTER YOUNG
MIDDLE SCHOOL 4-2-24.dwg

CONFIDENTIAL/PROPRIETARY SHEET: 05A OF 06

PHOTOGRAPHS

DIRECTIONAL BORE

MAX BACK REAMER SIZE = 4"

INSTALL (1) 1.5" HDPE CONDUIT
PULL (1) 6CT FOC
120" MINIMUM COVER



STA 2+35 DIRECTIONAL BORE

ON PINES BLVD / SR 820 STA 2+35 **LOOKING NORTH** (SEE PAGE 05 OF 06)

DIRECTIONAL BORE — MAX BACK REAMER SIZE = 4" INSTALL (1) 1.5" HDPE CONDUIT PULL (1) 6CT FOC 120" MINIMUM COVER



STA 4+52 DIRECTIONAL BORE



ON PINES BLVD / SR 820 STA 4+52 **LOOKING NORTH** (SEE PAGE 05 OF 06)

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Ш	2	071524	KMV	RC	REVISION # 1		
Ш	1	052824	KMV	AA	ORIGINAL		
Ш	NO.	DATE	ENG DESIGN	DRAFTING	COMMENT		
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ENGINEERING FIRM: K

PROJECT NUMBER: KMV-PP-24-002

LOCATION: 901 NW 129TH AVE PEMBROKE PINES, FL 33028

DRAWING NAME: kmv-PP-24-002 - Fire Station 89 TO WALTER YOUNG MIDDLE SCHOOL 4-2-24.dwg SHEET: 06 OF 06