

PEMBROKE PINES S.O.C. NEW EXIT DRIVE/WALL



13900 PINES BLVD. PEMBROKE PINES, FL

City of Pembroke Pines Received

MAY 27 2025

SP2024-0009

Planning & Economic Development

SCOPE OF WORK:

INSTALL NEW EXIT ONLY DRIVE, AUTOMATIC SLIDING GATE, DECORATIVE CONCRETE WALL AND LANDSCAPING AT SOUTH END OF PROPERTY.

SUB-CONSULTANT STAMP







1151 SE Cary Parkway, Suite 200 Cary, North Carolina 27518 P 919.851.8481 F 919.851.9703 www.engineereddesigns.com

REVISIONS / AUTHORIZATIONS

NO.	REVISIONS / ALTHORIZATIONS	DATE	EY.
0	ISSUED FOR CONSTRUCTION	11/28/73	
1	PERMIT COMMENTS	2/27/24	
2	CITY COMMENTS (NEW SHEET)	7/22/24	
3	NEW SHEET	10/24/24	
4	NEW SHEET	11/21/24	

N100

6000 COVER SHEET SURVEY

SPECIFICATIONS

CIVIL C100 (3) C101 SECTIONS/DETAILS C102

EROSION CONTROL DETAILS SEWER LATERAL PLAN AND DETAILS. EC200

LANDSCAPING

1100 1200 2 L300 PARTIAL LANDSCAPE PLAN SPECIFICATIONS, DETAILS PARTIAL TREE DISPOSITION PLAN ARCHITECTURAL

A100 PARTIAL SITE PLAN A102 DRIVEWAY PLAN, NOTES WALL ELEVATIONS A103

A104 TYPICAL WALL SECTION FIRE ACCESS PLANS

FA100 FIRE ACCESS SITE PLAN FA200 FIRE ACCESS/DETAILS

ELECTRICAL

E01 PARTIAL SITE PLAN PARTIAL SITE PLAN, PHOTOMETRIC E02

GATE MOTOR

LIGHT DETAILS

PROPRIETARY AT&T INFORMATION



AT&T CORPORATE REAL ESTATE PEMBROKE PINES SOC

13900 PINES BLVD.


PEMBROKE PINES

E9604

COVER SHEET

NEW EXIT DRIVE/WALL TO S.W. 5th STREET

SCALE: AS NOTED E9604G00000 G000

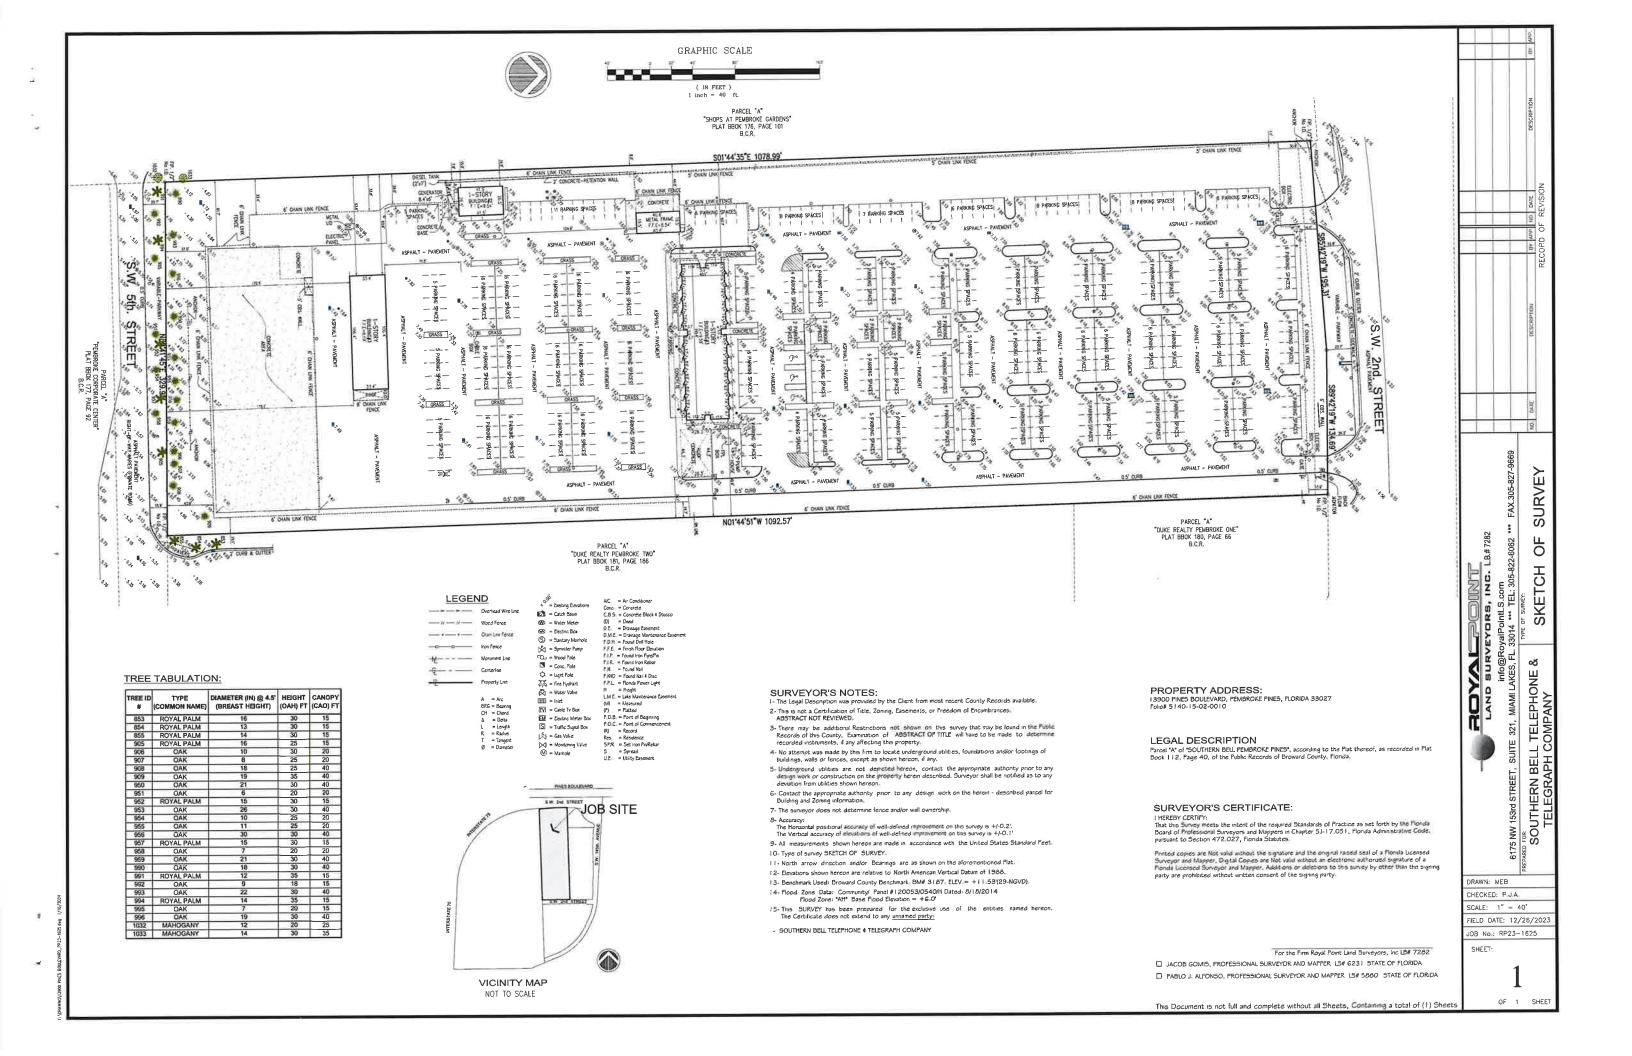



PEMBROKE PINES S.O.C. NEW EXIT DRIVE/WALL



13900 PINES BLVD. PEMBROKE PINES, FL SUB-CONSULTANT STAMP

EVELYN

+ROUX

arrelinii@@@is
Theodory Roux All,
Rebert Jehn Ervinn

Job No. 2379

QUATO TRAT IIIONDO-RIIO

ProCon Engineering, Inc.
MEP Engineering Consultants

7240 S.W. SDTE TERRALDE MAMIN, FLERMA 33155 FFICE:(308) 282-7630 FAX:(305) 268-7798 S-MAIL: processes processes ballsouth.net CA #8374 ProCon #: 25-07

C ENGINEERED

1151 SE Cary Parkway, Suite 200 Cary, North Carolina 27518 P 919.851.8481 F 919.851.9703 www.engineereddesigns.com

REVISIONS / AUTHORIZATIONS

100,	REVIEWS / AUTHORIZATIONS	DATE	B1
0	ISSUED FOR CONSTRUCTION	11/38/20	ĺ
1	PERMIT COMMENTS	2/27/24	Ī
2	CITY COMMENTS (NEW SHEET)	7/23/34	ij.
3	NEW SHEET	10/24/24	
4	NEW SHEET	11/22/34	
5	DRC COMMENTS ON PERMIT SET	5/2/25	

SCOPE OF WORK:

INSTALL NEW EXIT ONLY DRIVE, AUTOMATIC SLIDING GATE, DECORATIVE CONCRETE WALL AND LANDSCAPING AT SOUTH END OF PROPERTY.

DRAWING LI

G000 COVER SHEET

CIV

C100 PARTIAL SITE PLAN
C101 SECTIONS/DETAILS
C102 DETAILS

C103 EROSION CONTROL DETAILS
EC200 SEWER LATERAL PLAN AND DETAILS.

FIRE ACCESS PLANS

FA100 FIRE ACCESS SITE PLAN FA200 FIRE ACCESS/DETAILS PROPRIETARY AT&T INFORMATION
NOT FOR GENERAL USE OR DISCLOSURE OUTSIDE OF AT&T
THES REFORMATION MAY ONLY BE USED BY AUTHORIZED
PERSONNEL OF THE LOCAL CONFERMENT ASSINCT IN CONNECTION
WITH APPLICATION FOR PERMITS AND AUTHORIZATIONS FOR
BUILDINS, CONSTRUCTION, AND/ OR ZONNING CHANGES.



CORPORATE

PEMBROKE PINES SOC

13900 PINES BLVD. PEMBROKE PINES


E96


COVER SHEET


PROGRET TECCH


NEW EXIT DRIVE/WALL


TO S.W. 5th STREET

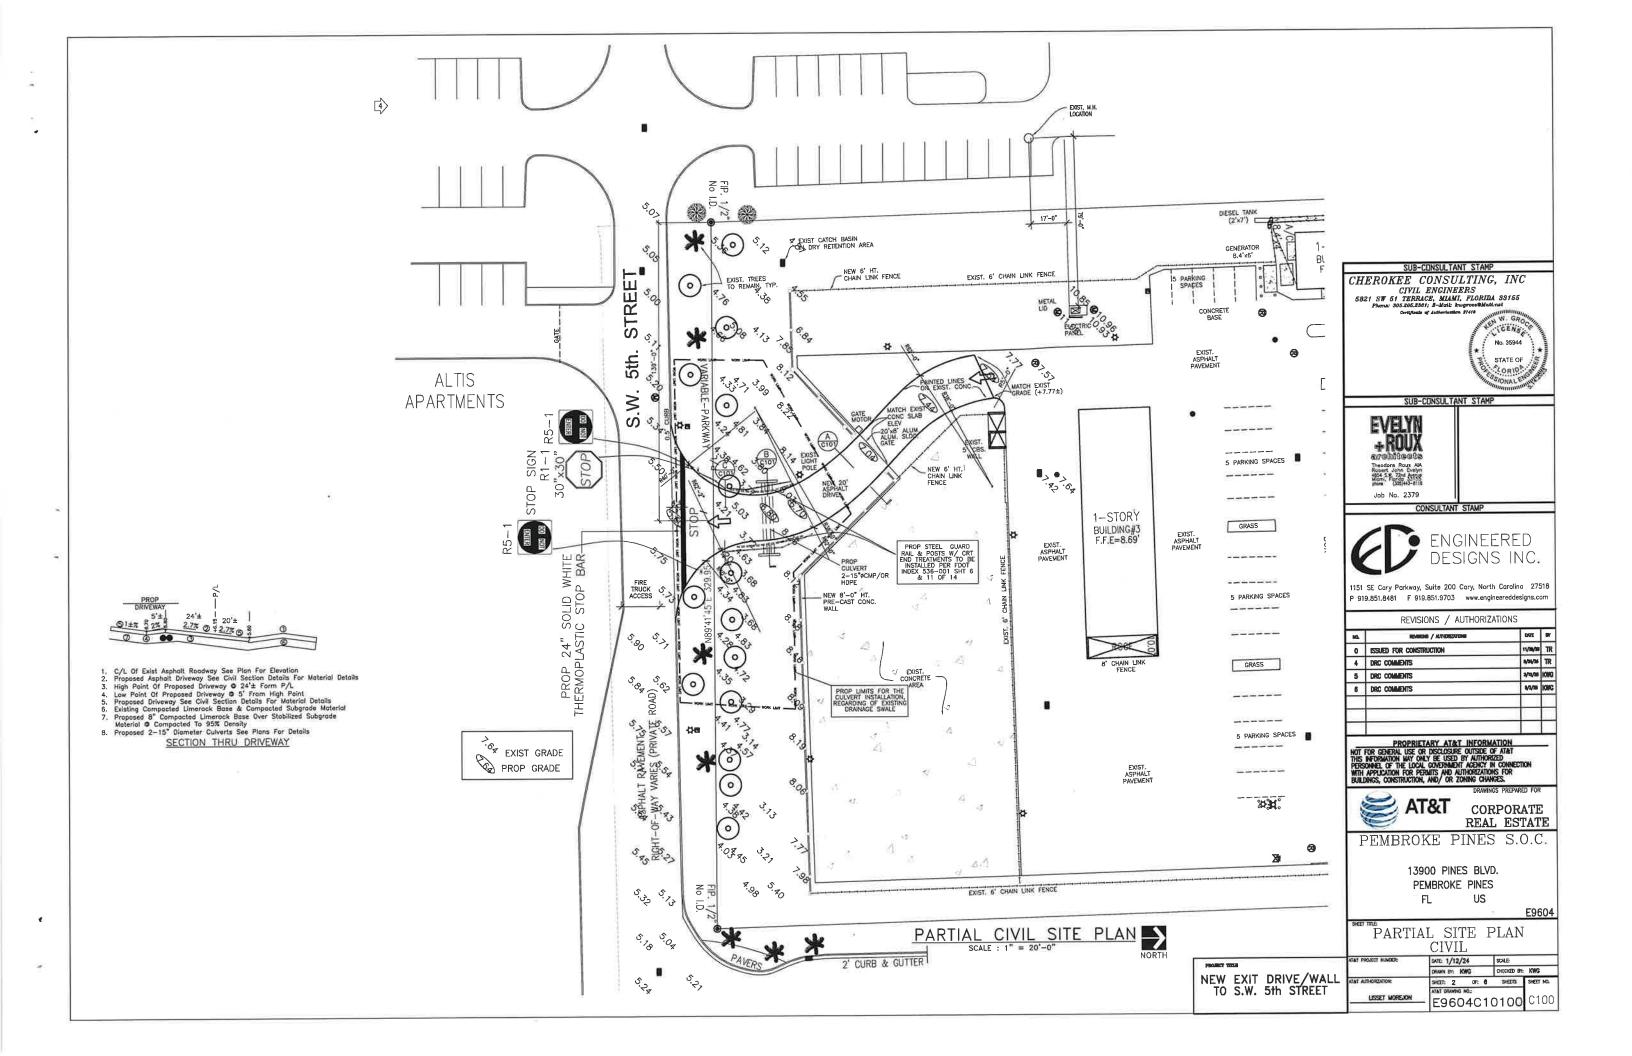


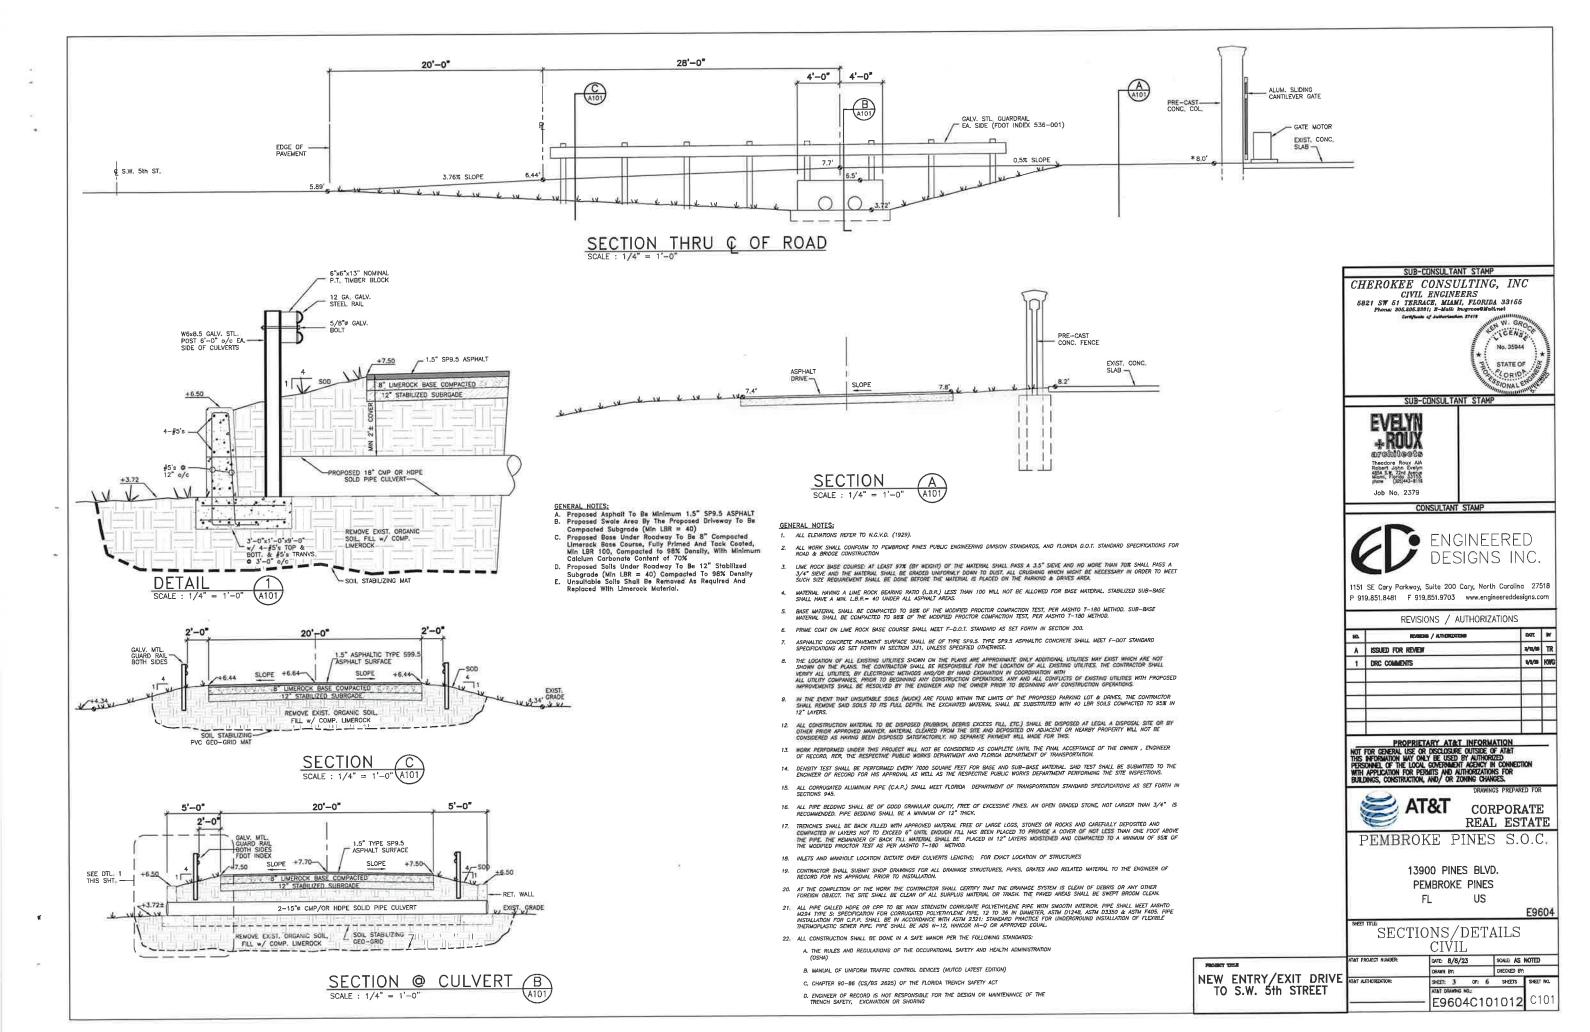

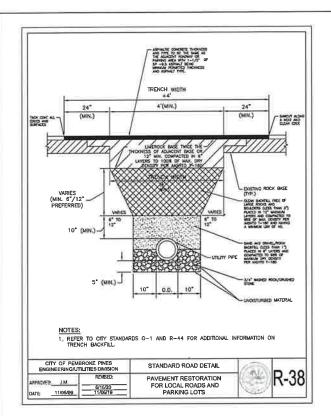

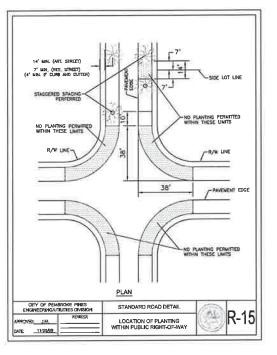

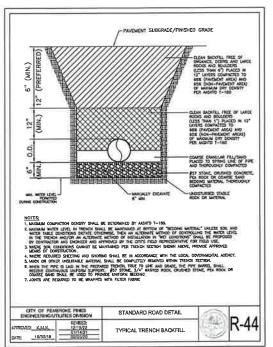

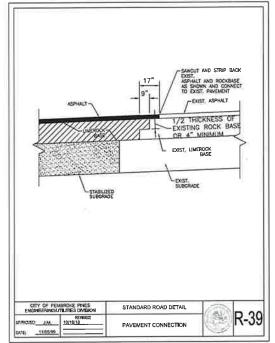



SUB-CONSULTANT STAMP



Job No. 2379



1151 SE Cary Parkway, Suite 200 Cary, North Carolina 27518 P 919.851,8481 F 919.851.9703 www.engineereddesigns.com

REVISIONS / AUTHORIZATIONS

0 ISSUED FOR CONSTRUCTION 11/16/25 TR 4 DRC COMMENTS 42/16/20 ICNG 5 DRC COMMENTS 42/16/20 ICNG 6 DRC COMMENTS 42/16/20 ICNG	HO.	PEMBORS / AUTHORIZATION	DATE	P/
5 DRC COMMENTS 2/12/10 KWG	0	ISSUED FOR CONSTRUCTION	11/31/33	TR
0 pile 00-2110	4	DRC COMMENTS	6/34/34	TR
8 DRC COMMENTS 4/4/20 KNG	5	DRC COMMENTS	3/13/80	KWG
	6	DRC COMMENTS	V/3/20	KWG

PROPRIETARY AT&T INFORMATION

NOT FOR CEMERAL USE OR DECLOSURE OUTSIDE OF AT&T
THES REFORMATION MAY ONLY BE USED BY ANTHOREDE
PERSONNEL OF THE LOCAL COVERNMENT MEDICY IN CONNECTION
WITH APPLICATION FOR PERMITS AND AUTHORIZATIONS FOR
BUILDINGS, CONSTRUCTION, AND/ OR ZONNO CHANGES.



AT&T CORPORATE

REAL ESTATE

PEMBROKE PINES S.O.C.

13900 PINES BLVD. PEMBROKE PINES US 1 FL


E9604


PARTIAL SITE PLAN CIVIL


NEW EXIT DRIVE/WALL TO S.W. 5th STREET

STANDARD DETAILS


DATE: 1/12/24 SCALE:
DRAWN BY: KWG CHECKED BY: KWG SHEET: 4 OF: 6 SHEETS SHEET NO. LISSET MOREJON E9604C10100 C102

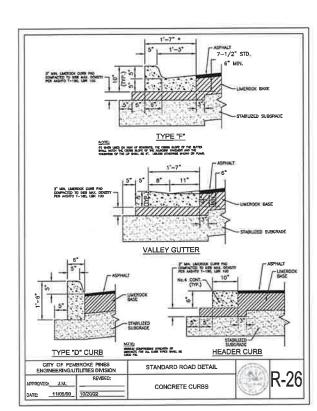

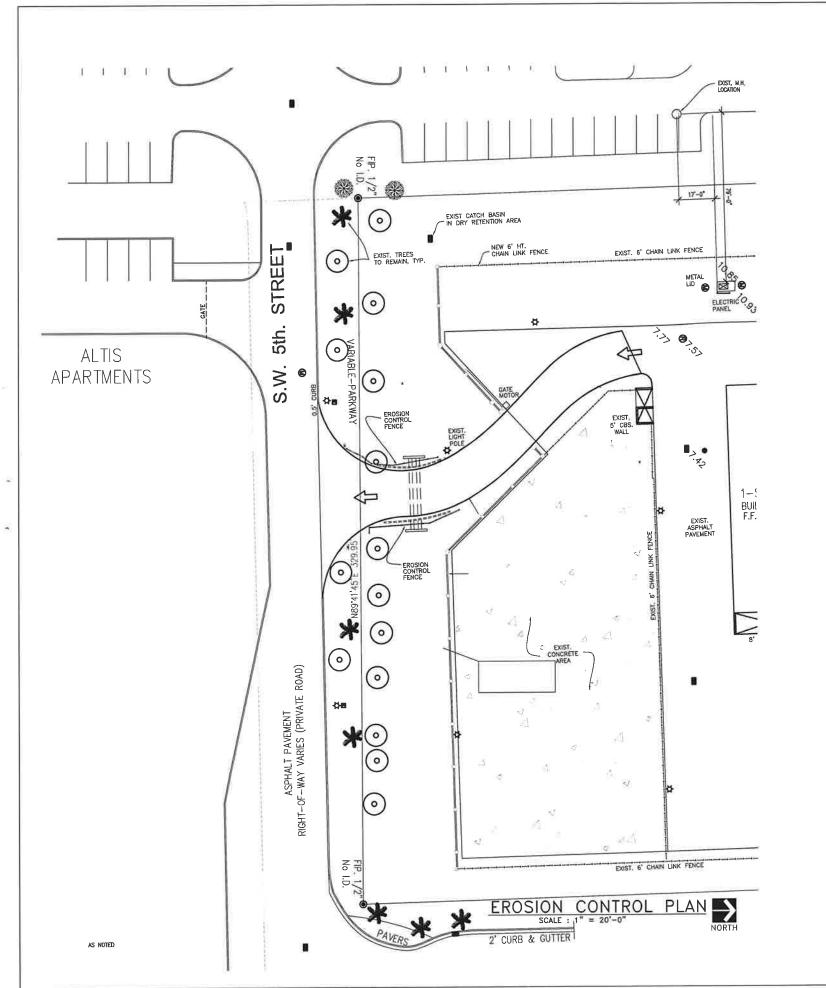

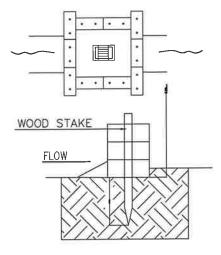

HAY BALE PROTECTION AROUND INLET

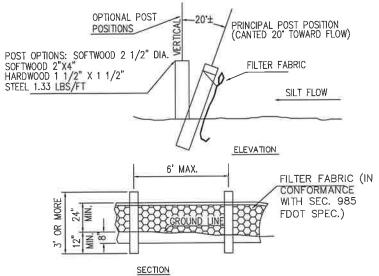

TEMPORARY SILT FENCE

NOTES:

- 1. HAY BALES SHALL BE TRENCHED 3" TO 4" AND ANCHORED WITH 2 1" X 2" (OR 1" DIAM.) X 4" WOOD STAKES. STAKES OF OTHER MATERIAL OR SHAPE PROVIDING EQUIVALENT STRENGTH MAY BE USED IF APPROVED BY THE ENGINEER.
- 2. ADJACENT BALES SHALL BE BUTTED FIRMLY TOGETHER. UNAVOIDABLE GAPS SHALL BE PLUGGED WITH HAY OR STRAW TO PREVENT SILT FROM PASSING.
- 3. SILT FENCES SHALL BE PROVIDED AS SHOWN TO AROUND THE LAKE TO PREVENT CONSTRUCTION DEBRIS FROM WASHING INTO LAKE.
- 4. HAY BALES SHALL BE INSTALLED AT ALL NEW AND AND EXISTING INLETS DURING CONSTRUCTION.

EROSION CONTROL DETAILS





SUB-CONSULTANT STAMP



Job No. 2379

CONSULTANT STAMP



1151 SE Cary Parkway, Suite 200 Cary, North Carolina 27518 P 919.851.8481 F 919.851.9703 www.engineereddesigns.com

REVISIONS / AUTHORIZATIONS

NQ.	PENSONS / AUTHORIZATIONS	DALE	BY.
0	ISSUED FOR CONSTRUCTION	11/39/20	TR
4	DRC COMMENTS	s/syst	TR
5	DRC COMMENTS	1/11/16	KWG
			L
			Ш

PROPRIETARY AT&T INFORMATION

NOT FOR CHEFAL USE OR DISCLOSIVE OUTSIDE OF AT&T
THIS INFORMATION MAY ONLY BE USED BY AUTHORIZED
PPESONNEL OF THE LOOAL COMERNMENT MEDICAL IN CONNECTION
BITH APPLICATION FOR PERMITS AND AUTHORIZATIONS FOR



CORPORATE REAL ESTATE


PEMBROKE PINES S.O.C.

13900 PINES BLVD. PEMBROKE PINES FL US

E9604

EROSION CONTROL PLAN CIVIL

NEW EXIT DRIVE/WALL TO S.W. 5th STREET

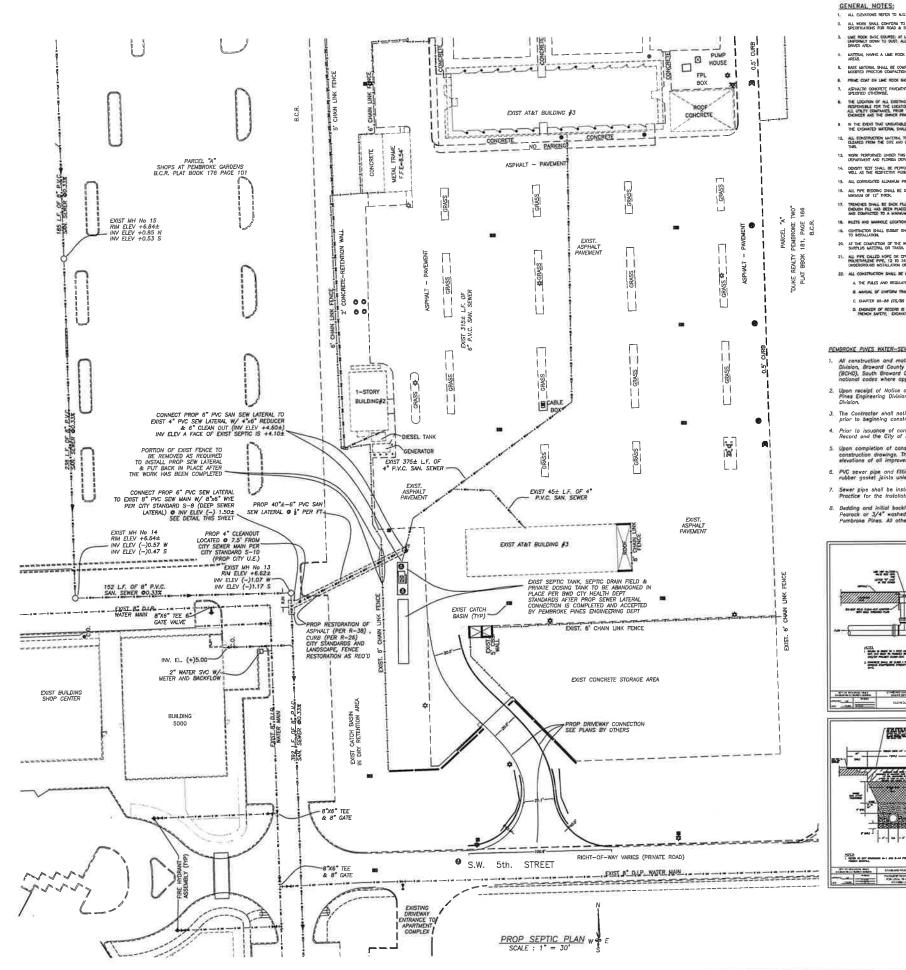

GENERAL NOTES:

- ALL WORK SMALL CONFORM TO PENERGINE PINES PUBLIC WORKS DEPARTMENT'S WATER, SEMEN, GRADING AND DRAINAGE REGULATIONS AND STAN SPICEFICIENTS FOR ROLD & BRIDGE CONSTRUCTION
- THE MODE BYZE CONNEC AT CHECKING WHICH MIGHT BY WILDING SHAT WATE Y 22, ABOUT MO MOST LIMIT LIES SHAT WERE VIT, SIDEL WID JACKET WIT CHECKING THE MIGHT DATE OF MIGHT BY WITHING SHAT WAS WELL AND WELL LIMIT SHAT WITH SHAT WAY A 22, ABOUT WID MIGHT SHAT WITH SHAT WAY A 34, ABOUT WID JACKET WAS WELL AND WELL LIMIT SHAT WAS WELL AND JACKET WAS WELL AND WELL AND WELL LIMIT SHAT WAS WELL AND JACKET WAS WELL AND JACK


- ASPHALING CONCRETE PANDLENT SURFACE SHALL BE OF TIPE S-3. TYPE S-3 ASPHALING CONCRETE SHALL WEST F-DOT STANDARD SPECIFICATIONS AS SET FORTH IN SECTION 331, UNLESS SPECIFICATION OF THE STANDARD SPECIFICATIONS AS SET FORTH IN SECTION 331, UNLESS SPECIFICATION OF THE STANDARD SP
- THE LOCATION OF ALL CERTISES SERVED IN THE PLANS ARE APPROXIMENT DAY ADDROXES, STREETE MAY DON'T MODE AND THE PLANS OF ON THE PLANS. THE CONTRICTOR SHALL INCOME THE PLANS OF LOCATIONS AND ALL CHARGEST AND ADDRESS AND ADDRE
- 12. ALL CONSTRUCTION MATERIAL TO BE CONFIDENT CRUMBERS, CONTROL PROCESS FILL, CTC.) SHALL OF DESCRIPTION AND ACCOUNT PROCESSOR OF MATERIAL MATERIAL PROCESSOR OF MATERIAL PROCES


- 18. ALL PIPE BEDONG SINUL BE OF GOOD GRAVALAR QUILITY, FREE OF EXCESSIVE FINES. AN OPEN GRADED STONE, NOT LARGE! THAN 3/6" IS REDGIMENOED PIPE BEDONG SINUL BE A MINIOR OF 12" THICK.
- 18. HERE AND MARKET LICENSON DICTUTE OVER CLAYOFFE LIDEDING. FOR DUCT LIDERICA OF STRUCTURES.
- IN. CONTRACTOR SMALL SIZBUIT SHOP DRAWNES FOR ALL WATER, SENER, DANAMOR STRUCTURES, PRES, GRATES AND RELATED MATERIAL TO THE EMERGEN OF RECORD FOR MES APPROXIM, PRORE TO RESTAULATION.
- 20. AT THE COMPLETON OF THE HORK THE CONTINCTOR SHALL CONTINC THAT THE CHANNOE SYSTEM IS CLEAN OF DEERS OR ANY OTHER RORDEN GUERT, THE SITE SHALL BE CLEAN OF ALL SHAPLES MITTERS OF TRUBE, OF TRUBE, THE PARTS AND SHALL BE SHIPT BROOM CLEAN.
- 21. ALL PRE CALLED HOPE OR CIP TO BE HOW STREAMS CONDUCTE CARESTANCE PIEW WITH SWOOTH HISDOOR, PIEW SHALL HEXT AND TO HES THE STREAMS FOR A STREAMS FOR A STREAM FOR A STREAM OF THE ADVISOR OF THE STREAM OF THE ACT AND A STREAM OF THE ACT AS A STREAM OF
- 22. ALL CONSTRUCTION SHALL BE COME IN A SAFE WHICH PIEM THE FOLLOWING STANGARDS
- & MANUE OF ENVIORS TRATTIC CONTROL DEVICES (NATED LATEST EDITION)
- C. CHAPTER 90-86 (CS/8S 2023) OF THE FLORIDA TRENCH SAFETY ACT
- & AMONEER OF RECOVER AS ACT RESPONSIBLE FOR THE DESIGN OF HANTENANCE OF THE THENCH SAFETY, DISCHARGE OR SHOPING


PEMBROKE PINES WATER-SEWER SPECIFIC NOTES:


- All construction and materials shall conform to the Standards and Specifications of the City of Pembrake Pines Engineerin, Division, Broward County Department of Planning and Environmental Protection (BCDPEP), Broward County Health Departmen (BCHO), South Broward Drainage District (SEDD), South Florida Water Management District (SFWMD), and all other local and national codes where applicable.

- Upon completion of construction, the Contractor shall submit to the Engineer of Record one complete set of "as-built" construction drawings. These drawings shall be marked to show "as-built" construction changes and dimensioned isociations and elevations of oil imprevenements and shall be signed by the Contractor.
- PVC sewer pion and fittings shall be non-pressure polyvinyl chloride pipe conforming to ASTM D3034, SDR 35, with push-on nubber gastet joints unless otherwise noted.
- Sever pipe shall be installed in accordance with ASTM DZ321, and the Uni— Bell Plastic Pipe Association's "Recommended Practice for the Installation of PVC Sever Pipe".
- . Bedding and initial bookful (12 inches) over sewer mains and services shall be sand with no rock larger than 1° in diameter. Pearsock or J/4° washed rock will be used in water or where unsuitable bedding axists at the discretion of the City of Pambroke Pines. All other full shall not have rock larger than 6° in diameter.

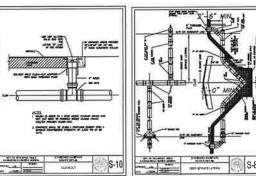

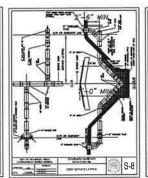

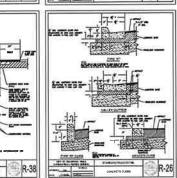

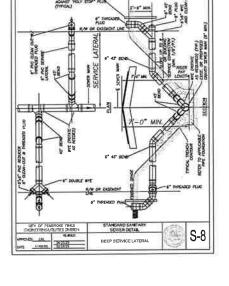

SUR-CONSULTANT STAME CHEROKEE CONSULTING, INC CIVIL ENGINEERS 5821 SW 51 TERRACE, MIAMI, FLORIDA 33155 Phone: 305.205.2361; E-Molt: begroos@Mattnet



CONSULTANT STAMP



LEVEL

REVISIONS / AUTHORIZATIONS

NEL	REVISIONS / AUTHORIZATIONS	DATE	BY
1	PER IRC COMENTS	3.12.25	K
2	PER DRC COMMENTS	5225	K
			Г
			Г
\neg			Г
\neg			Г
-			Н

PROPRIETARY AT&T INFORMATION

NOT FOR GENERAL USE OR DISCLOSURE OUTSIDE OF AT&T THIS
INFORMATION MAY ONLY BE USED BY AUTHORIZED PERSONNEL

FOR PERMITS AND AUTHORIZEDOMS FOR BUILDINGS, CONSTRUCTION,

FOR PERMITS AND AUTHORIZEDOMS FOR BUILDINGS, CONSTRUCTION, AND/ OR ZONING CHANGES.



CORPORATE


REAL ESTATE

PEMBROKE PINES SOC

13900 PINES BOULEVARD PEMBROKE PINES, FL

PROPOSED SEWER LATERAL PLAN VIEW

SCALD As Shown On Plan DATE 10.10.2024 TRAVN BY: KWG SHEET) 6 DF) 6 SHEETS SHEET NO. EC200 E9604EC10100

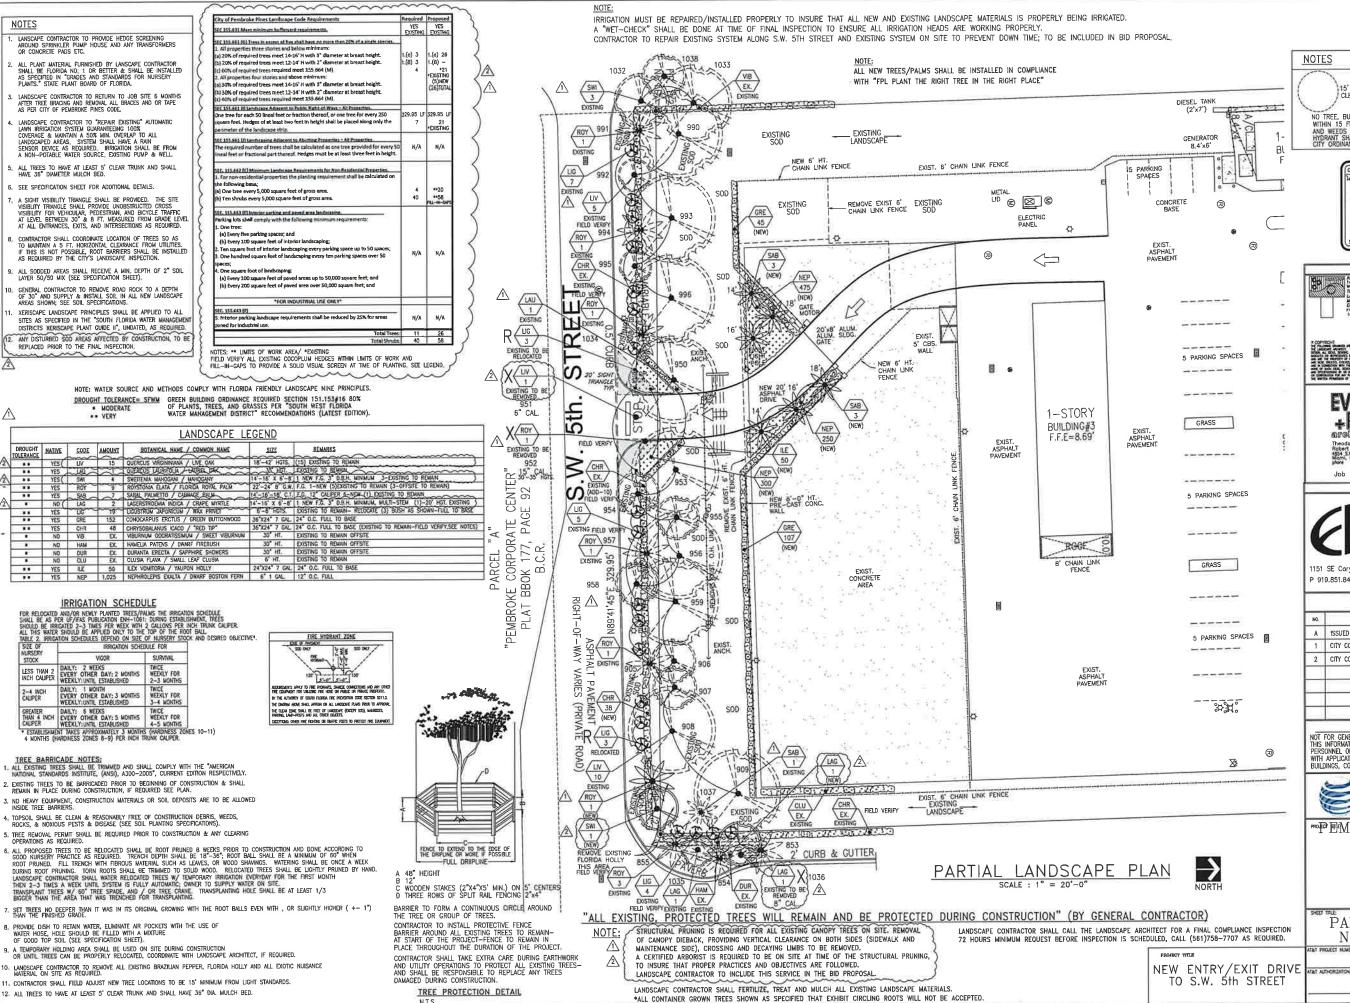

15' DIA. FIRE HYDRANT CLEAR ZONE (TYP.) FIELD VERIFY LOCATIONS

NO TREE, BUSH, HEDGE, OR SHRUB, SHALL BE PLANTED WITHIN 15 FEET DIAMETER OF A HYDRANT AND ALL GRASS AND WEEDS SHALL BE KEPT TRIMMED SUCH THAT THE HYDRANT SHALL BE FULLY VISIBLE FROM THE STREET. CITY ORDINANCE 93.25CF.



SUB-CONSULTANT STAMP EL E. RAWLS REAFCOOTSS

RBL#23-10-2220

+ ROUX

Job No. 2379



DESIGNS INC.

151 SE Cary Parkway, Suite 200 Cary, North Carolina 27518 P 919.851.8481 F 919.851.9703 www.engineereddesigns.com

	R	EVISIO	NS	/	AUTHORIZATIONS	
		REVISIONS	/ AU	THORE	ZATIONS	Ŀ
HED !	mun	TRAFFIC	cmi	nv		

NO.	REVISIONS / AUTHORIZATIONS	DAIL	DI
Α	ISSUED WITH TRAFFIC STUDY	11/28/23	TR
1	CITY COMMENTS	07/23/24	RGB
2	CITY COMMENTS	11/25/24	RGB
_			-

PROPRIETARY AT&T INFORMATION NOT FOR GENERAL USE OR DISCLOSURE OUTSIDE OF ATAT
THIS INFORMATION MAY ONLY BE USED BY AUTHORIZED
PERSONNEL OF THE LOCAL GOVERNMENT AGENCY IN CONNECTION
WITH APPLICATION FOR PERMITS AND AUTHORIZATIONS FOR
BUILDINGS, CONSTRUCTION, AND/ OR ZONING CHANGES.



CORPORATE REAL ESTATE

E9604

™PEMBROKE PINES S.O.C.

13900 PINES BLVD. PEMBROKE PINES US

PARTIAL LANDSCAPE

NEW ENTRY PLAN


DATE: 8/8/23 SCALE: AS NOTED DRAWN BY: R.BARTLETT CHECKED BY: RGB/MER SHEET: 1 OF: 3 SHEETS SHEET NO. E9604L100 L100


IRRIGATION SCHEDULE relocated and/or newly planted trees/plans the Brigation Schedule.

EE AS PER DY/INS PURLICATION ENH-1081: DURING ESTABLISHERT, TREES
LD BE RIRGATED 2-3 TIMES PER WEDK WITH 2 CALLONS PER NICH TRUNK CAUPER.
INSE WATER SHOULD BE APPUED ONLY TO THE 10P OF THE ROOT BALL.

SIZE OF	IRRIGATION SCHE	DULE FOR	
NURSERY STOCK	VIGOR	SURVIVAL	
LESS THAN 2 INCH CALIPER	DAILY: 2 WEEKS EVERY OTHER DAY: 2 MONTHS WEEKLY:UNTIL ESTABLISHED	TYPICE WEEKLY FOR 2-3 MONTHS	
2-4 INCH CALIPER	DAILY: 1 MONTH EVERY OTHER DAY: 3 MONTHS WEEKLY: UNTIL ESTABLISHED	TWICE WEEKLY FOR 3-4 MONTHS	
Greater Than 4 Inch Caliper	DAILY: 6 WEEKS EVERY OTHER DAY: 5 MONTHS WEEKLY: UNTIL ESTABLISHED	TWICE WEEKLY FOR 4-5 MONTHS	



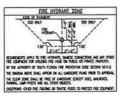

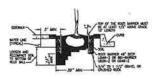

ROOT BARRIER DETAIL (DIPICAL)

NOTE: A ROOT DHORRER SISTEM SHALL BE INSTALLED IN STUATIONS WHERE A TREE OR PAUM IS PLANTED WITHIN 10 OF A PAYED SHRACE OR ROTALITACTURE.

1) PAINE, 0.005 TREAT PRAYER REVISEMENT 3) ROUNDED EXCES
2) ZEPTER AND SISTEM

2 (2) ZEPTER AND SISTEM


1) 24" PEPTH.

NOTE: BIO BARRIERS SHALL BE INSTALLED WHERE TREES ARE IN THE WONTY OF UNDERGROUND LINES, FIELD VERFY AS REQUIRED.

THEES SHALL BE INSPECTED AT TIME OF FINAL LANDSCAPE INSPECTION FOR APPROVAL

= ROOT BARRIER (TYPICAL) SEE LOCATIONS NOTE: ALL TREES INSTALLED WITHIN 4' OF PUBLIC INFRASTRUCTURES SHALL BE INSTALLED WITH ROOT BARRIERS AS REQUIRED.

"ALL EXISTING, PROTECTED TREES WILL REMAIN AND BE PROTECTED DURING CONSTRUCTION" (BY GENERAL CONTRACTOR)

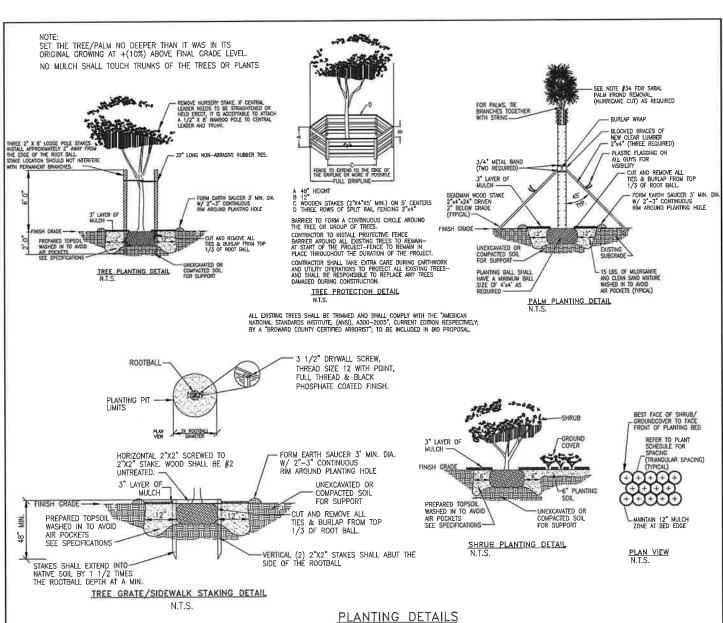

N T.S

NOTE: NO PLANT MATERIALS SHALL BE PLANTED WHERE THEY WILL OBSTRUCT VIEWS TO ROADWAY SIGNAGE OR BE PLACED WITHIN SIGHT LINES.

LANDSCAPE SPECIFICATIONS

- CONTRACTOR SHOULD MAKE HIS OWN TAKE OFF TO ELIMINATE DISCREPANCIES.
 IN CASE THEY OCCUR, THE PLAN WILL TAKE PRECEDENCE OVER THE PLANT LIST.
- EXACT LOCATION OF PLANT MATERIAL MAY VARY SLIGHTLY, COORDINATE FIELD LOCATIONS WITH OTHER TRADES PRIOR TO COMMENCEMENT OF WORK. THE LANDSCAPE PLANS SHALL NOT BE UTILIZED FOR STAKING, LAYOUT OR LOCATIONS OF ANY SITE STRUCTURE OR FEATURE INCLUDING BUT NOT LIMITED TO BUILDINGS, SIGNS, SIDEWALKS, EASIDMENTS, UTILITIES OR ROADWAYS.
- SIDEMAKS, DESIMENTS, UITUILES OF ROWARDS OF CONTRACTOR SHALL BE "FLORIDA \$1" OR BETTER AND SHALL BE INSTALLED AS SPECIFIED IN "FLORIDA DEPT. OF ASSICULTURAL GRADES AND STANDARDS", CURRENT EDITION RESPECTIVELY.
- ALL PLANTING TO BE DONE ACCORDING TO GOOD NURSERY PRACTICE.

- LANDSCAPE ARCHITECT SHALL BE NOTIFIED OF ANY CHANGES IN THE MATERIAL OR DESIGN PRIOR TO INSTALLATION OF THE SAME.
- OWNER RESERVES THE RIGHT TO REJECT ANY OR ALL BIDS.
- LANDSCAPER SHALL HAVE A COMPETENT SUPERINTENDENT PRESENT ON THE JOB WHO SHALL BE AUTHORIZED TO REPRESENT THE LANDSCAPER IN HIS ABSENCE.
- WHO SHALL BE AUTHORIZED TO REPRESENT THE CANDEAUER IN THE ADSENCE.

 PLANTS SHOULD BE TYPICAL FOR THEIR WARETY AND SPECIES, SOUND, HEALTHY
 WOORDUS, FREE FROM PLANT DISEASE, INSECTS OR THEIR EGS. THEY SHALL
 HAVE HEALTHY NORMAL ROOTS AND SHALL NOT BE ROOT BOUND. QUIALITY AND
 SZE: ALL PLANT MATERIALS SHALL BE NURSERY GROWN UNLESS OTHERMISE NOTED.
- ALL PLANT MATERIAL SHALL BE HANDLED IN A CAREFUL MANNER DURING TRANSPORTATION AND INSTALLATION.
- PLANTS SHALL NOT BE PRUNED OR TOPPED BEFORE DELIVERY.
- OWNER RESERVES THE RIGHT TO APPROVE ALL PLANT MATERIALS.
- LANDSCAPER SHALL REMOVE ALL TRASH AND DEBRIS FROM THE SITE DALY. THE PREMISES SHALL BE KEPT NEAT AND ORDERLY AT ALL TIMES WHILE WORK IS IN PROGRESS. THE LANDSCAPE CONTRACTOR SHALL LAY OUT HIS MORK ACCORDING TO THE PLANS AND SPECIALIZATION AND WILL BE RESPONSIBLE FOR ALL IMPOSEMEMENTS EXCEDSING SPECIAL CARE. IN LAYING OUT WORK TO KEEP WITHIN PROPERTY LIVES AND RECOGNING EASEMENTS. THE LANDSCAPE CONTRACTOR WILL BE HELD RESPONSIBLE FOR ANY ERRORS. CONTRACTOR TO NOTIFY LANDSCAPE ARCHITECT OF ANY DISCREPANCIES IN LAYING.
- METHODS OF PROTECTION SHALL BE MAINTAINED AT ALL TIMES, AS REQUIRED TO INSURE ALL PERSONS AND PROPERTY AGAINST INJURY, AND SHALL BE MAINTAINED LIMIT. THE COMPLETION OF ALL WORK.

 PLANT MATERIALS ASSERVATIONS ON THE PLANT LIST: FG (FIELD GROWN): CT (INDICATES CLEAR TRAIN MESSUREMENT FROM THE TOP OF BULL TO BREST BRANCHING OR BACE OF THE LOWEST FROMD): GA. (GALLON CAN): GAL. (3 CALLON CAN): OA (INDICATES GREAT HEIGHT FROM TOP OF BULL TO BROWN OF CONTROL OF SHOWING: SPR (MICHATES SPREAD): HAY (INDICATES HEAVY): MAY (INDICATES
- SUBSTITUTION: PLANT SUBSTITUTION REQUESTS, FOR PLANT MATERIAL NOT OBTAINABLE IN THE TYPE AND SIZES SPECIFICD SHALL BE MADE PRIOR TO SUBMISSION OF BIDS. ALL SUBSTITUTION REQUESTS SHALL BE ORDECTED TO THE LANDSCAPE ARCHITECT FOR CONSIDERATION AND APPROVAL. IT IS THE LANDSCAPE CONTRACTOR'S OBLICATION TO KNOW WHEER THEY CAN DISTAN ALL MATERIAL AT THE TIME OF BIDDING AND AT THE TIME A CONTRACT IS EXECUTED. 22-
- 23. THE CONTRACTOR'S GUARANTEE SHALL NOT APPLY IN THE EVENT OF FIRE, FLOOD, HURRICANE, WINDSTORM, OR OTHER "ACTS OF GOO" OR DAMAGES TO LANDSCAPING IN PROGRESS CAUSED BY ANY PERSONS OTHER THAN THOSE PERSONS UNDER THE DOMINION AND CONTROL OF THE CONTRACTOR.
- SET TREES NO DEEPER THAN IT WAS IN ITS ORIGINAL GROWING WITH THE ROOT BALLS EVEN WITH, OR SLIGHTLY HIGHER $(+-1^\circ)$ THAN THE FINISHED GRADE.
- DELIVERY RECEIPTS FOR TOPSOIL, PLANTING SOIL & MULCH SHALL BE SUPPLIED TO THE INSPECTOR OR LANDSCAPE ARCHITECT UPON REQUEST.

- 26. COMMERCIAL FERTILIZER COMMERCIAL FERTILIZER SMALL BE AN ORGANIC FERTILIZER CONTAINING MITROGEN, PHOSPHORIC ACID, AND PRIZEM IN EQUAL PERCENTAGES OF AVAILABLE IN HOSPHORIC GOVERNMENT, INTROCEN SMALL BE OF AVAILABLE IN HOSPHORIC FOR COMMERCIAL INTROCES, SMALL BE DELIVERED TO THE SITE UNDERTED AND REGINAL CONTAINERS, EACH BEARING THE MANUFACTURER'S GLARAMETED ANALYSIS.

 INTRIL FERRILIZATION OF TREES, SHRIBES, GROUND COVERS, SHALL BE WITH "MUORGANIE" OR AN APPROVED COMPLETE FERRILIZER APPLY "MUCREMANTE" IN A CRICLE AROUND THE PLANT BEFORE MUCHING, APPLY "MUORGANIE" FERRILIZER AFTER MUCHING, APPLY "MUORGANIE" FERRILIZER MUORGANIE" FERRILIZER AFTER MUCHING, APPLY "MUORGANIE" FERRILIZER MUOR MUORGANIE" FERRILIZER MUOR MUORGANIE" FERRILIZER MUOR MUORGANIE" FERRILI
- 5 LBS. OR 14.5 CUPS / PALMS
 3 LBS. OR 8.70 CUPS / 12'-16' MATERIAL
 2 LBS. OR 8.50 CUPS / 6'-12' MATERIAL
 0.69 LBS. OR 2.00 CUPS / 6'-8' MATERIAL
 0.19 LBS. OR 1/2 CUP / 3 GAL MATERIAL
 0.10 LBS. OR 1/4 CUP / 1 GAL MATERIAL

ALL PLANTING MATERIAL SHALL BE GURANTEED 365 DAYS (1 YEAR) FROM TIME
OF FINAL INSPECTION & APPROVAL.

ALL SOD TO BE ST AUGUSTINE PARMETTO TSA—FREE (WEED FREE) SOUD, UNLESS OTHERWISE NOT BE SOON THE RELEASE, UNFORM IN COMPOSITION, DRY, AND FREE FERDLESS SHALL BE SLOW THE RELEASE, UNFORM IN COMPOSITION, DRY, AND FREE FROM LESS TO RECEIVE A 3" LAYER OF ELICALYPIUS MILCHATGOBRAUGH. (NINN-CYPRESS).
ALL TREES TO HAVE A 2 1/2" MINIMUN TRUNK CALIFER OR UNLESS OTHERWISE SHOWN.
ALL TREES TO HAVE A 2 1/2" MINIMUN TRUNK CALIFER OR UNLESS OTHERWISE SHOWN.
ALL TREES FIELD GROWN (URIO CAN TREES NOT ACCEPTABLE), UNLESS OTHERWISE SHOWN.
ALL TREES FIELD GROWN (URIO CAN TREES NOT ACCEPTABLE), UNLESS OTHERWISE SHOWN.
ALL WASSCAPER TO FURNEH ALL MATERIALS AND LABOR NALUDON PLANTS, MULCH, TOP DRESSING, SOL, PERPARATION, DECORATIVE HEAVE (1500 STATES PROMEDIATION, THE TRUNK CALIFER APPLY PAIR SPECIAL FRETILIZER AS PRINCIPLY OF MINISCO, SICH PERPARATION, DECORATIVE HEAVE (1500 STATES PROMEDIATION).

ALL TREES FIELD GROWN (URIO CAN TREES NOT ACCEPTABLE), UNLESS OTHERWISE SHOWN.

ALL TREES FIELD GROWN (URIO CAN TREES NOT ACCEPTABLE), UNLESS OTHERWISE SHOWN.

ALL DREAGNER PROMEDIATION OF THE SAME (1500 STATES PROMEDIATION OF ALL LANGESCAPE REQUIRED FROM FILED AT THE TRUNK CALIFER APPLY PAIR SPECIAL FRETILIZER AS PROMEDIATION.

ALL TREES FIELD GROWN (LIRIO CAN TREES NOT ACCEPTABLE), UNLESS OTHERWISE SHOWN.

ALL TREES FIELD GROWN (LIRIO CAN TREES NOT ACCEPTABLE), UNLESS OTHERWISE SHOWN.

ALL TREES FIELD GROWN (LIRIO CAN TREES NOT ACCEPTABLE), UNLESS OTHERWISE SHOWN.

ALL TREES FIELD GROWN (LIRIO CAN TREES NOT ACCEPTABLE), UNLESS OTHERWISE SHOWN.

ALL TREES FIELD GROWN (LIRIO CAN TREES NOT ACCEPTABLE), UNLESS OTHERWISE SHOWN.

ALL TREES FIELD GROWN (LIRIO CAN TREES NOT ACCEPTABLE), UNLESS OTHERWISE SHOWN.

ALL TREES FIELD GROWN (LIRIO CAN TREES NOT ACCEPTABLE), UNLESS OTHERWISE SHOWN.

ALL TREES FIELD GROWN (LIRIO CAN TREES NOT ACCEPTABLE), UNLESS OTHERWISE SHOWN.

ALL TREES FIELD GROWN (LIRIO CAN TREES NOT ACCEPTABLE), UNLESS OTHERWISE SHO

- OF 1.0 MM TO 3.0 MM AND ASSORPHON RATE OF 300 TIMES ITS WEIGHT IN WATER. APPLY USING THE FOLLOWING ANOUNTS:

 1 PAC PER TREE 38" BALL SZE
 2 PACS PER TREE 04" BALL SZE
 1 PAC PER 720 GAL CONTAINER
 0.5 PACS PER 73—10 GAL CONTAINER
 0.25 PACS PER 74—10 GAL CONTAINER
 0.25 PACS PER 74—10 GAL CONTAINER
 2.26 LANDSCAPE CONTAINER
 2.28 LANDSCAPE CONTAINER
 2.28 LANDSCAPE CONTAINER
 2.28 LANDSCAPE CONTAINER
 2.30 FART SAME TO THESE FACILITIES URBING THE PLANTING OPERATION WILL
 1 BE REPARED AT THE EXPENSE OF THE LANDSCAPE CONTRACTOR IN A MANNER
 2.29 PLANTING SOIL "PLANTING SOIL STALL BE COMPOSED OF 50X SAND AND 50X
 DECOMPOSED OFFICIAL WITHER ANY MAINTINNS IN THIS COMPOSITION SHALL BE
 2.29 PLANTING SOIL "PLANTING SOIL STALL BE COMPOSED OF 50X SAND AND 50X
 DECOMPOSED OFFICIAL WITHER ANY WAINTINNS IN THIS COMPOSITION SHALL BE
 3.20 PLANTING SOIL STALL BE COMPOSED OF 50X SAND AND 50X
 DECOMPOSED OFFICIAL WITHER ANY WAINTINNS IN THIS COMPOSITION SHALL BE
 4.20 PLANTING SOIL STALL BE COMPOSED OF 50X SAND AND 50X
 DECOMPOSED OFFICIAL WITHER ANY WAINTINNS SIN SCHAPLE BE FREE OF STONES,
 PLANTIS, BOOTS AND OTHER FORDERM MATERIALS WHICH MORTH BE A HENDRAINE
 TO PLANTING OPERATIONS OR BE DETRIMENTAL TO 0000 PLANT GROWTH. "SOIL SHALL
 BE DELIVERED IN A LOOSE FRABEL CONDITION AND APPLIED IN ACCORDANCE WITH
 THE PLANTING SPECIPICATIONS.

 3.0 WATER FOR PLANTING WILL BE AVAILABLE AT THE SITE AND WILL BE PROVIDED BY
- THE PLANTING SPECIFICATIONS.

 30, WAITER FOR PLANTING WILL BE AVAILABLE AT THE SITE AND WILL BE PROVIDED BY THE OWNER.

 11. PRUNNIE: REMOVE DEAD AND BROKEN BRANCHES FROM ALL PLANT MATERIAL. PRUNNE: OR SETAIN TYPICAL GROWTH HABIT OF INDIDING LING STEELS, RETAINING AS MUCH HIGHT AND SPREAD AS POSSBEE. MAKE ALL PRUNNING CUITS WITH A STAFFAR AS TO ENGINEE ELEMANTION OF STUBES. "MACROBING" CLUTS, REDAIN ANCE TO LING OF GROWTH WILL NOT BE PREMITTED AND TREES WILL NOT BE POLLD, TOPPED, OR TO STAFFAR AS TO STAFFAR AS THE PROVINCE OF THE PROVINCE AND THE AND THE PROVINCE AND THE PROVINCE AND THE AND THE AND THE PROVINCE AND THE PLANTSCHE CONTRACTOR.
- HATRICKED.

 2. SITE PREPARATION: IT SHALL BE THE RESPONSIBILITY OF THE LANDSCAPE CONTRACTOR TO FANCE (FINE) GRADE ALL LANDSCAPE AREAS TO BE SOCIOED (PRIOR TO APPLICATION OF 500) ELIMANTINO ALL BUMPS, DEPRESSIONS, STICKS, STORES, AND OTHER DEBRIS TO THE SANSYACTION OF THE OWNER.
- OF 500) ELIMARING ALL BLUFS, DEPRESSIONS, STOCKS, STOKES, AND OTHER DEBWS
 TO THE SAIRSFACTION OF THE OWNER.

 33. MANTENANCE: MAINTENANCE SHALL BEGIN IMMEDIATELY AFTER EACH PLANT
 IS PLANTED AND SHALL CONTINUE UNIT. ALL PLANTING MAS PASSED FINAL INSPECTION
 AND ACCEPTANCE. MAINTENANCE SHALL INCLUDE WATERING, WESSED FINAL INSPECTION
 AND ACCEPTANCE. MAINTENANCE SHALL INCLUDE WATERING, WESSED, CULTIVATING,
 REMOVAL OF DEAD MATERIAS, RESETTING PLANTS TO PROPER GRADES OR UPRIGHT
 POSITIONS AND RESTORATION OF THE PLANTING SAUCER AND ANY OTHER NECESSARY
 OPERATIONS. PROPER PROTECTION OF ANAL BE REMOVED AND ANY
 ALL SETTING FROM PLANTING OPERATIONS SHALL BE REPORTED PROMPT ALL SE
 ALL SETTING FROM PLANTING OPERATIONS SHALL BE REPORTED PROMPT AND
 WITH STRESS PROBLEMS OF THE PAIL, THUS GIVING HOLDER SURWING RATE
 OF THE SAME. (NOTE: OTHER PAIL SPECIES THE BRANCHES TOCKTICE MY THE
 BOGGERADABLE THING: TO A TOCH BUNDLE AROUND BUD FOR PROTECTION AS REQUIRED).

 36. ALL APPLICABLE FERBERL STATE, AND LOCAL PERMITS SHALL BE ATTAINED PROR FROM TO
 REMOVAL, RELOCATION, OR INSTALLATION OF PLANT MATERIAS. INDICATED WITHIN THE PLANS
 OF PLAN DOCUMENTS.

 36. A SIGHT MISBULTY TRINGUE SHALL BE PROVIDED. THE SIGHT VISIBILITY TRANGLE SHALL PROVIDED
 UNDISTRICTED CROSS-VISIBILITY FOR WHICHCARP, PEDESTRAIN, AND BICYCLE TRAFFIC AT LEVEL.
 BETWEEN 30° & 8 FT MEASURED FROM GRADE LEVEL AT ALL EMPRANCES, EXITS, AND INTERSECT.

SUD"-LUNSUE FANT

BECKERD BARRETT LANGGAPEINE.

| 1447 TRIBUTON, FL 3344

VELLISOTON, FL 3344

LANGGAPE ARCHITECTURE LE24000332

LENGLAE E SANIS BLAGOO1433

CHAL - FORTING FANT BRAGOO1433

SUB-CONSULTANT STAMP



8

Theodore Roux Ala Robert John Evelyn 4854 S.W. 72nd Avecus Willowski, Versige 53155 phare (305)443-8118



1151 SE Cary Parkway, Suite 200 Cary, North Carolina 27518 P 919.851.8481 F 919.851.9703 www.engineereddesigns.com

	REVISIONS / AUTHORIZATI	ONS	
NO.	REVISIONS / AUTHORIZATIONS	DATE	BY
A	ISSUED WITH TRAFFIC STUDY	11/28/23	TF
			_

PROPRIETARY AT&T INFORMATION NOT FOR GENERAL USE OR DISCLOSURE OUTSIDE OF ATACT THIS INFORMATION MAY ONLY BE USED BY AUTHORIZED PERSONNEL OF THE LOCAL GOVERNIBUTH AGENCY IN CONNECTION WITH APPLICATION FOR PERMITS AND AUTHORIZATIONS FOR BUILDINGS, CONSTRUCTION, AND/ OR ZONING CHANGES.



DRAWINGS PREPARED FOR

CORPORATE REAL ESTATE

™PEMBROKE PINES S.O.C.

13900 PINES BLVD. PEMBROKE PINES FL US

E9604

SPECIFICATIONS

SHEET DATE: 8/8/23 SCALE: AS NOTED

DRAWN BY: R.BARTLETT CHECKED BY: RGB/MER SHEET: 2 OF: 2 SHEETS SHEET NO. L200 E9604L200

IRRIGATION MUST BE REPAIRED/INSTALLED PROPERLY TO INSURE THAT ALL NEW AND EXISTING LANDSCAPE MATERIALS IS PROPERLY BEING IRRIGATED. A "WET-CHECK" SHALL BE DONE AT TIME OF FINAL INSPECTION TO ENSURE ALL IRRIGATION HEADS ARE WORKING PROPERLY. CONTRACTOR TO REPAIR EXISTING SYSTEM ALONG S.W. 5TH STREET AND EXISTING SYSTEM ON SITE TO PREVENT DOWN TIME; TO BE INCLUDED IN BID PROPOSAL. PROJECT TITLE

NEW ENTRY/EXIT DRIVE TO S.W. 5th STREET

AT&T - 13900 Pines Blvd, Pembroke Pines, FL 33027 SCIENTIFIC NAME DISH (IN) HEIGHT SPIEZAD CA (FT) (FT) 35 20 ystonea elata 35 18 yes treet tree tovstonea elata 14 Excellent - 859 remain 42 18 Good - 80% remain YES 15 42 20 Good - 70% remain ercus virginians Good - 75% Good - 80% remain vercus virginiana 950 Laurel Oak Good - 75% remain ercus laurifalia YES 20 15 Fair - 50% remove yes street tree 15 40 15 954 Live Oak yes 955 Laurel Oak 28 13 Fair - 60% remain yes vercus laurifolia 40 45 cus vingiviana 25 Good - 70% remain Yes 15 yes street tree 15 40 Pair - 50% remain 20 Good - 65% remain yes street tree Good - 75% remain 990 Live Oak Good - 80% ercus virginiana remain 991 Royal Palm Good - 85% yes remain tonea elata 992 Live Oak Yes Fair - 45% remein ercus virpiniana 9 1.0 15 993 Live Oalt Good - 80% 35 50 remain yes 14 37 remain 18 12 remain yes 35 remaile yes 1032 Mahoguny 13 30 remain yes 16 35 35 Good - 80% remun yes 1033 M treat tree 24 40 15 Fair - 45% recritic yes treat tree 10 20 12 Good - 20% remain no 1034 Crapemyrtia remove remain 1037 Labal Palm 16 13 600d - 75% yes 12 28 20 Fuir - 50% remain ves ANG

IRRIGATION SCHEDULE

IRRIGATION SOFTLOGGE

FOR RELOCATED AND/OR NEMY PLANTED TREES/PALAS THE RENCATION SCHEDULE
SHALL BE AS PER UF/FAS PUBLICATION FOR THE STREAM ESTABLISHMENT, TREES
SHOULD BE RENCATED 2-3 TIMES PER META WITH 2 CALLONS PER NICH TRUMS CAUPER.
ALL THIS WATER SHOULD BE APPLIED ONLY TO THE TOP OF THE ROOT BALL
THAN SET SHOULD BE APPLIED ONLY TO THE TOP OF THE ROOT BALL
THAN STREET SHOULD BE APPLIED ONLY TO THE TOP OF THE ROOT BALL
THAN STREET SHOULD BE APPLIED ONLY TO THE TOP OF THE ROOT BALL
THAN STREET SHOULD BE APPLIED ONLY TO THE TOP OF THE ROOT BALL
THAN STREET SHOULD BE APPLIED ONLY TO THE TOP OF THE ROOT BALL
THAN STREET SHOULD BE APPLIED ONLY TO THE TOP OF THE ROOT BALL
THAN STREET SHOULD BE APPLIED ONLY TO THE TOP OF THE ROOT BALL
THAN STREET SHOULD BE APPLIED ONLY TO THE TOP OF THE ROOT BALL
THAN STREET SHOULD BE APPLIED ONLY TO THE TOP OF THE ROOT BALL
THE TOP OF T

SIZE OF	IRRIGATION SCHEDULE FOR					
NURSERY STOCK	VIGOR	SURVIVAL				
LESS THAN 2 INCH CALIPER	DAILY: 2 WEEKS EVERY OTHER DAY: 2 MONTHS WEEKLY: UNTIL ESTABLISHED	TWICE WEEKLY FOR 2-3 MONTHS				
2-4 INCH CALIPER	DAILY: 1 MONTH EVERY OTHER DAY: 3 MONTHS WEEKLY:UNTIL ESTABLISHED	TWICE WEEKLY FOR 3-4 MONTHS				
GREATER THAN 4 INCH CALIPER	DAILY: 6 WEEKS EVERY OTHER DAY: 5 MONTHS WEEKLY: UNTIL ESTABLISHED	TWICE WEEKLY FOR 4-5 MONTHS				

4 MONTHS (HARDINESS ZONES 8-9) PER INCH TRUNK CAUPER.

- TREE BARRICADE NOTES;
 ALL EXISTING TREES SHALL BE TRIMMED AND SHALL COMPLY WITH THE "AMERICAN NATIONAL STANDARDS INSTITUTE, (ANS), A300—2005", CURRENT EDITION RESPECTIVELY. 2. EXISTING TREES TO BE BARRICADED PRIOR TO BEGINNING OF CONSTRUCTION & SHALL REMAIN IN PLACE DURING CONSTRUCTION, IF REQUIRED SEE PLAN.
- . NO HEAVY EQUIPMENT, CONSTRUCTION MATERIALS OR SOIL DEPOSITS ARE TO BE ALLOWED INSIDE TREE BARRIERS.
- TOPSOIL SHALL BE CLEAN & REASONABLY FREE OF CONSTRUCTION DEBRIS, WEEDS, ROCKS, & NOXIOUS PESTS & DISEASE (SEE SOIL PLANTING SPECIFICATIONS).
- TREE REMOVAL PERMIT SHALL BE REQUIRED PRIOR TO CONSTRUCTION & ANY CLEARING OPERATIONS AS REQUIRED.
- OPERATIONS AS REQUIRED.

 6. ALL PROPOSED TREES TO BE RELOCATED SHALL BE ROOT PRUNED 8 WERKS PRIOR TO CONSTRUCTION AND DONE ACCORDING TO GOOD NURSERY PRACTICE AS REQUIRED. TRENCH DEPTH SHALL BE 18"—35"; ROOT BALL SHALL BE A MINIMUM OF 60" WHEN ROOT PRUNED. BILL TRENCH WITH FIREDUS MATERIAL SURLY AS LEAVES, OR WOOD SHAWNOS. WATERIAN SHALL BE GINCE A WEEK DURING ROOT PRUNING. TORN ROOTS SHALL BE TRAINED TO SOUD WOOD. RELOCATED TREES SHALL BE LIGHTLY PRUNED BY HAMD, LANDSCAPE CONTRACTOR SHALL WATER RELOCATED TREES BY TEMPORAY IRRICATION EVERYDMY FOR THE FIRST MONTH THEM 2.—3 TIMES A WEEK UNTIL SYSTEM IS FULLY AUTOMATIC; OWNER TO SUPPLY WATER ON SITE.

 TRAINSPLANT TREES "HO 60" TREE SADE, AND / OR TREE CRINE. TRAINSPLANTING HOLE SHALL BE AT LEAST 1/3 BIGGER THAN THE AREA THAT WAS TRENCHED FOR TRAINSPLANTING.

-FULL DRIPLINE

THE TREE OR GROUP OF TREES.

C WOODEN STAKES (2"X4"X5' MIN.) ON 5' CENTERS D THREE ROWS OF SPLIT RAIL FENCING 2"x4"

BARRIER TO FORM A CONTINUOUS CIRCLE AROUND

THE IREC ON GROUP OF INCENTIAL PROTECTIVE FENCE BARRIER AROUND ALL EXISTING TREES TO REMAIN—AT START OF THE PROJECT—FENCE TO REMAIN IN PLACE THROUGHOUT THE DURATION OF THE PROJECT.

TREE PROTECTION DETAIL

edureadas aprit to fire hygraits, samese connectors and art oth The edupatent for villoric fire host, on plelic or private property.


THE CLEAN TIME SHALL BE FREE OF UNKNOWN (DECEMPT SEED), MALES

A 48" HEIGHT

- SET TREES NO DEEPER THAN IT WAS IN ITS ORIGINAL GROWING WITH THE ROOT BALLS EVEN WITH , OR SUGHTLY HIGHER (+- 1") THAN THE FINISHED GRADE.
- PROVIDE DISH TO RETAIN WATER, ELIMINATE AIR POCKETS WITH THE USE OF WATER HOSE, HOLE SHOULD BE FILLED WITH A MIXTURE OF GOOD TOP SOIL (SEE SPECIFICATION SHEET).

- A TEMPORARY HOLDING AREA SHALL BE USED ON SITE DURING CONSTRUCTION OR UNTIL TREES CAN BE PROPERLY RELOCATED, COORDINATE WITH LANDSCAPE ARCHITECT, IF REQUIRED.
- LANDSCAPE CONTRACTOR TO REMOVE ALL EXISTING BRAZILIAN PEPPER, FLORIDA HOLLY AND ALL EXOTIC MUISANCE MATERIAL ON SITE AS REQUIRED.
- 11. CONTRACTOR SHALL FIELD ADJUST NEW TREE LOCATIONS TO BE 15' MINIMUM FROM LIGHT STANDARDS.
- 12. ALL TREES TO HAVE AT LEAST 5' CLEAR TRUNK AND SHALL HAVE 36" DIA. MULCH BED.

"ALL EXISTING, PROTECTED TREES WILL REMAIN AND BE PROTECTED DURING CONSTRUCTION" (BY GENERAL CONTRACTOR)

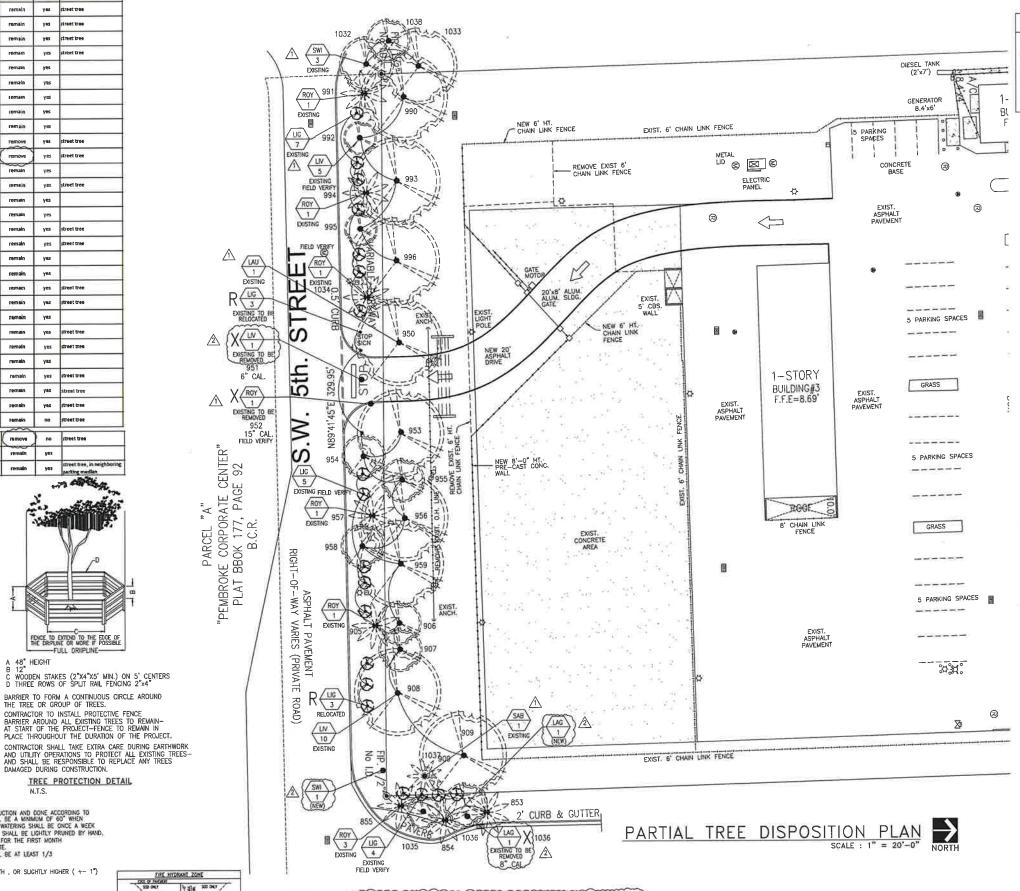

NOTES

15' DIA, FIRE HYDRANT CLEAR ZONE (TYP.) FIELD VERIFY LOCATIONS

NO TREE, BUSH, HEDGE, OR SHRUB, SHALL BE PLANTED WITHIN 15 FEET DIAMETER OF A HYDRANT AND ALL GRASS AND WEEDS SHALL BE KEPT TRIMMED SUCH THAT THE HYDRANT SHALL BE FULLY VISIBLE FROM THE STREET. CITY ORDINANCE 93.25°C.





RBL#23-10-2220 **EVELYN** +ROUX Robert John Evelyn 4854 S.W. 72nd Ayenus Mismi, Florido 33155 phone (305)443-8116 Job No. 2379



1151 SE Cary Parkway, Suite 200 Cary, North Carolina 27518 919.851.8481 F 919.851.9703 www.engineereddesigns.com

	REVISIONS / AUTHORIZATIONS		
NQ.	REVISIONS / AUTHORIZATIONS	DATE	BY
1	CITY COMMENTS	07/23/24	RGB
2	CITY COMMENTS	11/25/24	RGB
_			$\overline{}$

PROPRIETARY AT&T INFORMATION NOT FOR GENERAL USE OF DISCLOSURE OUTSIDE OF ATEXT
THIS INFORMATION MAY ONLY BE USED BY AUTHORIZED
PERSONNEL OF THE LOCAL GOVERNMENT AGENCY IN CONNECTION
WITH APPLICATION FOR PERMITS AND AUTHORIZATIONS FOR
BUILDINGS, CONSTRUCTION, AND/ OR ZONING CHANGES.



PROJECT TITLE

TO S.W. 5th STREET

CORPORATE REAL ESTATE

™PEMBROKE PINES S.O.C.

13900 PINES BLVD. PEMBROKE PINES FL US

E9604 TREE DISPOSITION

E9604L300 L300

NEW ENTRY PLAN SCALE: AS NOTED DATE: 8/8/23 DRAWN BY: R.BARTLETT CHECKED BY: RGB/MER NEW ENTRY/EXIT DRIVE ATAIT AUTHORIZATIO SHEET: 3 OF: 3 SHEETS SHEET NO.

STRUCTURAL PRUNING IS REQUIRED FOR ALL EXISTING CANOPY TREES ON SITE. REMOVAL OF CANOPY DIFFACK, PROVIDING VERTICAL CLEARANCE ON BOTH SIDES (SIDEWALK AND MAINTENANCE SIDE), CROSSING AND DECAYING LIMBS TO BE REMOVED. A CERTIFIED ARBORIST IS REQUIRED TO BE ON SITE AT TIME OF THE STRUCTURAL PRUNING, TO INSURE THAT PROPER PRACTICES AND OBJECTIVES ARE FOLLOWED.
LANDSCAPE CONTRACTOR TO INCLUDE THIS SERVICE IN THE BID PROPOSAL

NOTE: 2

SPECIFICATIONS

Special Consistent

A Exapting Unities:
Telephone, light or service poles, water mains, sprinkler lines, conduit, pipes or drains, either public or private, on site affected by this project, Contractor to notify proper authorities to afford Owners time to remove, preserve, or cap same prior to any work being performed under this contract.

B. Sanitary Avangements: Provide and mortain temporary toilet located where directed. Temporary toilet, enclosed, **ather-profest, well ventilated, and kept in sonitary condition at all times.

C. Temporary Utilities: Water and Electricity chall be provided and paid for by AT&T, Contractor to install all temporary wire and pipe required.

D. Shop Decease and Catalog Information:

The Contractor shall aubmit with a letter of transmittal to the Company's Representative, shap drawings or calcing information. Shap drawings shall be submitted for all pre-labricated items and all similar items which are not shown in complete detail on the approved contract drawings.

E. Supervision:
The Controctor shall provide continuous supervision of all work included in this contract by a duly authorized and competent superintendent.

- F. As-Bullt Droxings:

 Bond prints of the necessary droxings will be supplied to the Contractor for proporation
 of "As-Bullt" prints. All changes are to be marked in red on the "As-Bull" prints as the work
 progresses. Accurately diminished locations and elevations given for underground utilities.
- Upon completion of work and prior to the request for final payment, the Contractor must deliver to the Company the completed set of "As-Buil" prints and maintenance and Operation Manuals.
- G Independent Testing Laboratory Services:
- Coboratory employed and point for by the Contractor and approved by AT&T will make all required soil Compation and Concrete tests. Test results shall be published to Architect.
- summitted to exchitect.

 Controctor is responsible for notifying loboratory prior to each Concrete Pour. Make five (5) cylinders for each filly (50) yards or fraction thereof. Test two at 7-days and 3 at 28-days

H. Certificate of Occupancy: The Contractor shall secure a Certificate of Occupancy and forward a copy to the Company's Representative before final acceptance of the project. This certificate shall not releve the Contractor from howing to comply with the regularments of the punch list.

I. Quarantee: The Contractor shall provide a guarantee against defective warsmanship, materials, or equipment for a periad of one (1) year from the date of acceptance. This governitee shall include all costs encountered in replacing of defective wars or materials. In the event the Contractor falls to take receipt of written notice, the work correcting such defect may be occumplished by the Owner, and the Contractor shall be fiable for the cost of this work.

J. Snop (knowings: Shop drawings shall be submitted to Architect for approval by Architect or Engineer of record. Snop drawings requiring specialty Engineer seal shall be sealed by a Specialty Engineer employed by Contractor or manufacturer supplying product. Engineer shall be registered in the State of Florida.

- applicable requirements of the following codes shall be met.
- All applicable requirements of the following Codes shall be proceed as A Florida Bullyang Code 2023 Edition

 B. Florida Fire Prevention Code 2023 Edition, Structural Design Criteria: See Structural Drawings for Structural Design Criteria for Loods, Concrete Reinforching and Structural steel.
- L. The contractor and all sub-contractors shall verify all grades, lines, levels, conditions and dimensions at the job site and as shown on the drawings. They shall report in writing dry errors, inconsistences, or amissions on the drawings to the Architect/Engineer (A/E) before commencing work. The contractor and all sub-contractors shall lay, out their work from established reference points and are responsible for all lines, elevations and measurements in connection with their work.
- M. The contractor is responsible for installation and removal of all sharing and bracing as required for the proper execution of the work.
- N. The contractor is responsible for the protection of all work and materials from weather damage.
- O. Verification of existing conditions, incommuch as the remodeling and/or rehabilitation of an existing after requires that certain assumptions to made regarding existing conditions, and because some of these assumptions may not be verificable without expending additional sums of maney, or destroying distressive adequate or servicable participation, the owner agrees that, except regisjence are the part of the design professional, the causer will hold harmless, indeemily and defend the design professional from and against any plains orising out of the professional services under this agreement.

PAINTING WALL SYSTEM

- Ft. Louderdale Florida Phone (954) 581-0771
- Tercole XL—70 Course Texture
 TEX—COTE XL—70, spray—on: A high build, plasticized, vinyl toluene acrylic resin system specially formulated to provide a weatherproof surface applied over concrete and musconry surfaces.

- A. General: For each coaling system specified, provide four (4) by four(4) foot wall sample for Architect's approval prior to beginning project application of each special coaling system.
- 4. All currects shall be cound and clean prior to application of primer and cootings. Such surface contaminants as dust, drf. mildew, for alls, loads substrate, etc. shall be removed by water blasting. Excessive form oils, release agents and curing compounds may require light standblasting.
- 5. Mask all glass, shrubbery and asphalt surfaces.
- 6. Over a clean and sound surface apply Primer XL-70 per manufacturer's printed instructions.
- 7. Apply coating in accordance with manufacturer's directions. Use applications and techniques best suited for rate and type of material being applied.
- 8. Avoid stopping and starting midway on wall. Continue to a natural break, such as a panel edge or corner 9. At the completion of work of other trades, touch-up and restore all damaged or defaced surfaces

2. STRUCTUPAL DESIGN CRITERIA

THE DESIGN COMPLES WITH THE REQUIREMENTS OF THE FLORIDA STATE BUILDING CODE 2023 ED, AND OTHER REFERENCED CODES AND SPECIFICATIONS, ALL REFERENCED CODES AND SPECIFICATIONS SHALL BE LATEST EDITION AT TIME OF PERMIT.

WIND LOAD CRITERIA: BASIC LOAD VELOCITY - 160 MPH AS PER AGCE 7-16 RISK CATEGORY II EXPOSURE "C"

FOUNDATIONS ARE DESIGNED TO BEAP ON GRADE FILL WITH AN ALLOWABLE BEARING CAPACITY OF 2000 P.S.F. ALL FILL PLACED UNDER SLABS AND FOOTINGS SHALL BE CLEAN SAND AND POCK FREE OF DEBRIS AND OTHER DELETEROUS MATERIALS, SOIL SUPPORTING SLAB OIL GRADE AND FORMASS SHALL BE FLACED IN LIFTS 12 NOHES OR LESS AND COMPACTED TO A MINIMUM OF 95°T, OF MANUAUDU DET DENSITY, COMPACTION ITESTS SHALL BE MADE IN ACCORDANCE WITH ASTM. DISS'S MODIFIED.

CONFORMING TO ASTM C94 TO ACHIEVE A 28 DAY COMPRESSIVE STREIGTH OF 5,000 PS. PLANT COMPINGL IS REQUIRED, NO WATER SHALL BE ADDED AFTER MAINED TRUCK LEAVES PLANT WITHOUT THE APPROVAL OF ATAIL REPRESENTATIVE OF PAULIT ENGINEER, MAXIMUM MIX TIME AT POINT OF DEPOSIT IS 90 MINUTES. MAX SCUMP. 2" ± 1"

5 REINFORCING STEEL CONFORMING TO ASTM A-615-GRADE 60, FREE FROM OIL, LOGSE SCALE AND RUST

CONFORMING TO ASTM 4-185; FREE FROM OIL, LOOSE SCALE AND RUST

- A. Fill shall be clean sand and rock, free of organic or other deleterious materials. Fill shall contain a reasonable quantity of fines suitable for compaction as specified in this section.
- 1. Grade levels shown on new growings checked against existing slight variations of grade and established at beginning of work.
- 2. Layout work on the site and verify location with AT&T project manager
- C. Protection of Existing Property:
- Absolute protection of existing property, sidewalks and trees. Owner and Contractor shall agree on entrances, exits and road to building site before start of construction.
- Provide temporary chain link construction fence and gates at perimeter of construction site. Coordinate lization with ATA! project manager. Any existing work damaged during construction, replaced by Contractor.
- 5. Keep premises clean and remove all debris and waste materials during entire life of work.

1. Clear sile of all vegelation, roots and existing concrete slab to be removed

- 1, Strip area under drive of existing top soil, arganics and other deleterious materials.
- 2. Place clean fill to meet elevations shown on plat plan in lifts of 12" to obtain a minimum of 95% of maximum density at optimum moisture as determined by Modified Proctor Tests

- 1. Strip area of existing asphalt paving and vegetation.
- 2. Place additional planting fill in 12" lifts as needed to meet elevations shown on plot plans

When encountered in work or as indicated, protect existing active sewer, gos, water, electric and other utility services. Structures: Where required for proper execution of work, relocate them as directed, if existing active services are not indicated but or encountered, required protection or relocation, request Architect in writing for determination, decision. Do not proceed until instructions are obtained.

Share and brace excavations if required Protect all slapes and earth to prevent cave-in-

As required for all accumulation of water either by rain or other reasons.

Debris, trash, etc., kept on neat piles for frequent removal from property Upon completion, entire property left clean and in neat condition, free from all debris, trash, and foreign matter.

A. LAYOUT


- Poved areas located with reference to property lines or existing buildings according to drawings and to approval of AT&T.
- Where surveyor's permanent reference monuments available, locations from properly lines determined from some.

- Work consists of tringing bottom of excavation of poved area to surface of uniform density, stabilized with material acceptable to Architect, to a minimum of 93% of maximum density of optimum matisture as determined by Modified Proctor Tests (ASMM-0-1557).
- All soft and yielding material, and other portions of subgrade which will not compact readily, removed end replaced with suilable material and whole subgrade brought to line and grade and to foundation of uniform compaction and superinting power.
- All submerged slumps, roots, or other perishable matter encountered in preparation of subgrade removed to depth of not less than one foot below sutgrade.
- 4. After subgrade properly filled and shaped, brought to firm, unyielding surface, by railing entire area with approved three wheel power roller. Areas inaccessable to roller, thoroughly compacted with approved hand largers. There subgrade is of dry, sandy nature and cannot be rolled, water applied sufficiently to compact subgrade.
- After subgrade prepared and immediately before any base or paying course is load where subgrade tested as to crewn and elevation at all points material removed or odded as candilloan facets/ and competed to bring all portions of taughtable to correct elevation and uniform beginning power.
- 6. The entire area where rock base is to construed shall be stabilized to a minimum LBR (Limerock Regning Ratio) value of 40%.

Materials: Ofte Lime Rock, or equal, obtained from pits from which oil querburden removed, and show no tendency to air state of undergo chemical change under exposure to weather. As delivered, not to contain more than three percent of roots, led mold, or other organic matter. Meet following chemical requirements.

	Grade ∯2	Percent
bonates of Calcium & magnesium	Minimum	70.0
des of Iron and Aluminum	Maximum	2.0

- Rock spread uniformly with stocks, forks, or other equipment especially constructed for purpose.
 Following spreading, rock relied until entire depth of base is compacted into dense unyielding mass by
 roller, either three wheel or tandem type verighing minimum, ten (16) tons. Base course compacted to a
 minimum of 95% of maximum density at optimum maisture as determined by Modified Proctor Tests
 ASTM of 1357.
- D. Asphalt Concrete, Type 5-3, 1" composted thickness, as specified in Section 331, Floride State Road Department Specifications for road and bridge construction (approved and adapted 1977), applied with additional requirements to does specifications that all aggregate used in alphalt concrete Pass No. Four (4) screen and have penetration of 70-65. Spreading of esphalt concrete not extricted to mechanical spreaders as mentioned in above specifications, but may be laid by skilled variemen. Compacting a mixture confirm to a Section 129.17. Compacting thature, Flerida State Road Department Specifications for Road and Eridge Construction (approved and adapted 1977). A five (5) Ion roller foe composting mixture.
- E. BAPRICADES: Provide substantial temporary barricades around areas of operations and maintain same
- F. TESTING: Laboratory retained by Contractor and approved by Architect make all necessary tests to insure compliance with specifications, A minimum of 8 Modified Practor Density Tests (ASTM D-1557) required

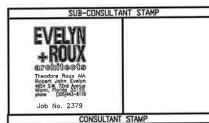


• ENGINEERED DESIGNS INC.

1151 SE Cory Parkway, Suite 200 Cary, North Carolina 27518 P 919.851.8481 F 919.851,9703 www.engineereddesigns.com

REVISIONS / AUTHORIZATIONS

NO.	REMISIONS / AUTHORIZATIONS	DATE	B
Α	ISSUED FOR REVIEW	1/24/24	TI
_			
			Ĭ
			-
			-

PROPRIETARY AT&T INFORMATION NOT FOR GENERAL USE OR DISCLOSURE OUTSIDE OF ATEXT THIS INFORMATION MAY ONLY BE USED BY AUTHORIZED FERSONNEL OF THE LOCAL GOVERNMENT ASENCY IN CONNECTION WITH APPLICATION FOR PERMITS AND AUTHORIZATIONS FOR BUILDINGS, CONSTRUCTION, AND/ OR ZCHING CHANGES.

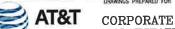

REAL ESTATE PEMBROKE PINES S.O.C.

13900 PINES BLVD.


PEMBROKE PINES US FL


NOTES

E9604

ARCHITECTURAL

DATE: 8/8/23 SCALE: AS NOTED NEW ENTRY/EXIT DRIVE MAT AUTHORIZANCE
TO S.W. 5th STREET SHEETS E9604N10100 N100

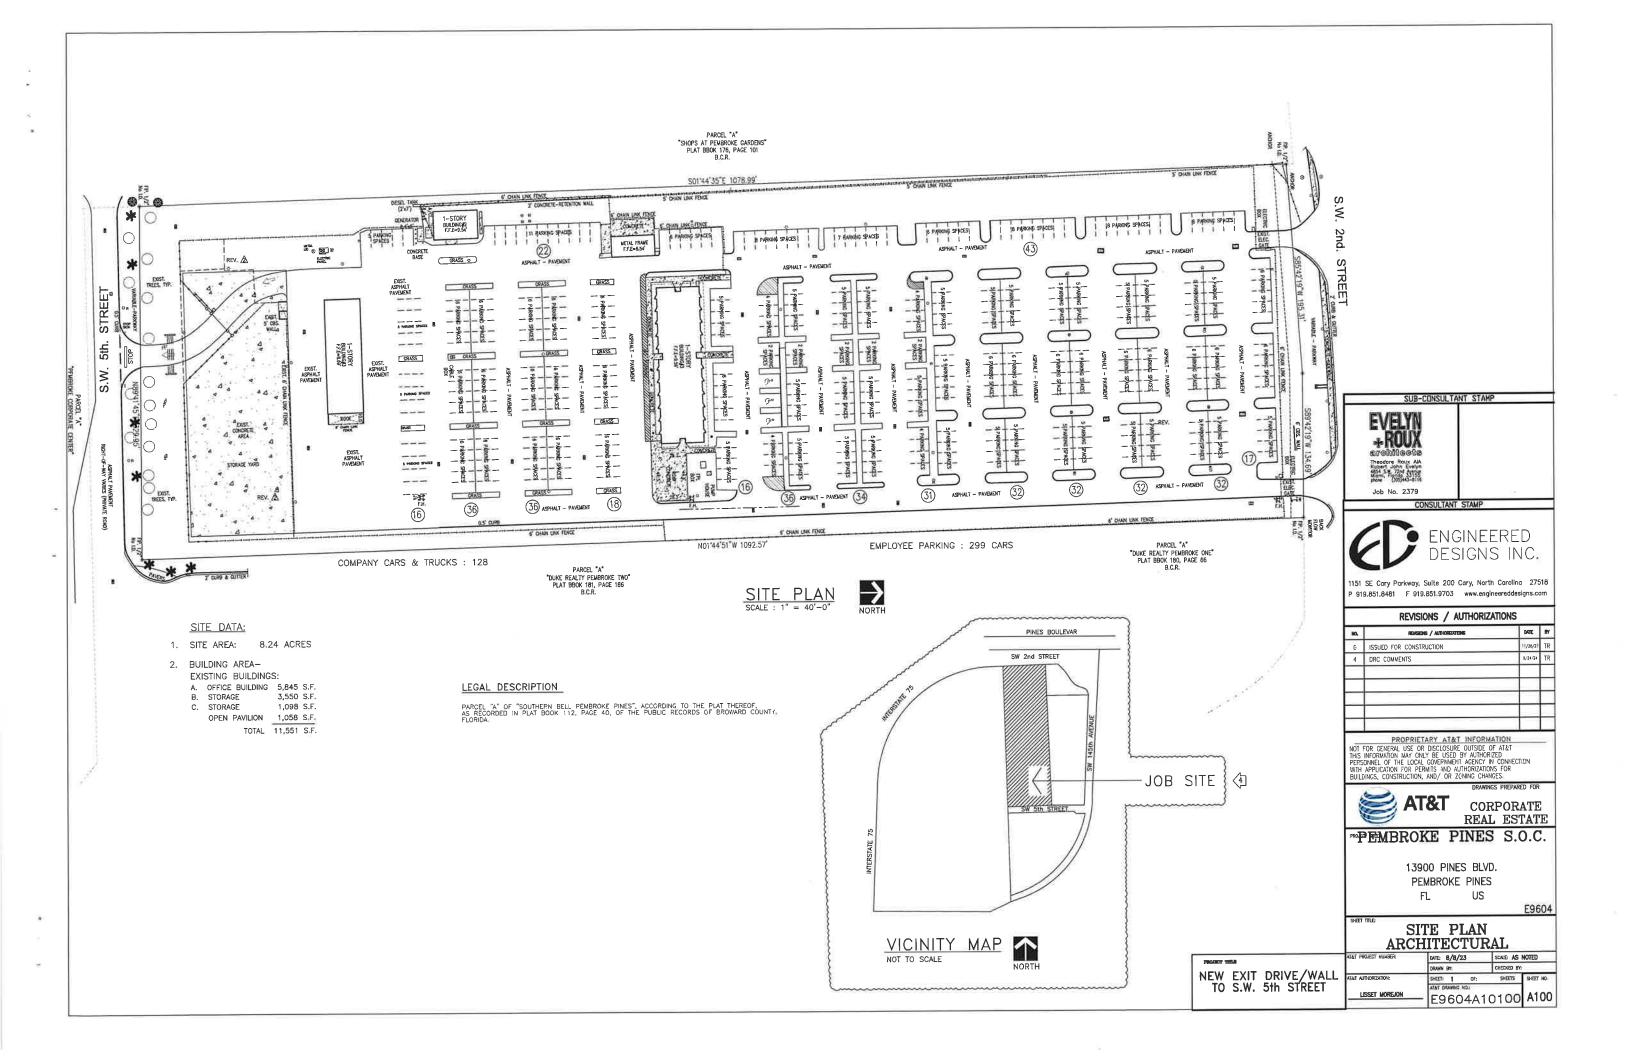

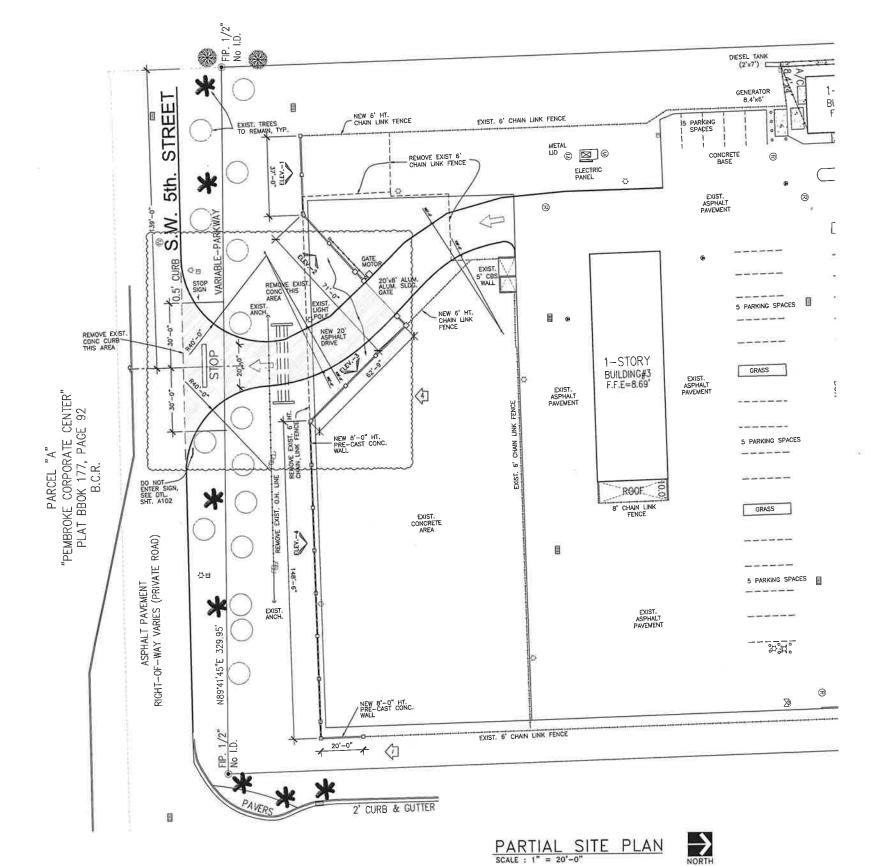

Job No. 2379

SUB-CONSULTANT STAMP




1151 SE Cary Parkway, Suite 200 Cary, North Carolina 27518 P 919.851.8481 F 919.851.9703 www.engineereddesigns.com

	REVISIONS / AUTHORIZATIONS		
ND.	REMERCHE / AUTHORIZATIONS	DATE	87
0	ISSUED FOR CONSTRUCTION	11/28/23	TR
1	WALL EXTENSION EAST SIDE	2, 27/24	TR
2	DRIVEVIAY EASEMENT	4/2/24	TR
4	DRC COMMENTS	9/24/24	TR
_			

PROPRIETARY AT&T INFORMATION

NOT FOR CENERAL USE OR DISCLOSURE OUTSIDE OF AT&T
THIS INFORMATION MAY ONLY BE USED BY AUTHORIZED
PEPSONNEL OF THE LOCAL GOVERNMENT AGENCY IN CONNECTION
WITH APPLICATION FOR PERMITS AND AUTHORIZATIONS FOR
BUILDINGS, CONSTRUCTION, AND/ OR ZCNING CHANGES.



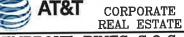

PEMBROKE PINES S.O.C.

13900 PINES BLVD. PEMBROKE PINES FL

E9604

PARTIAL SITE PLAN ARCHITECTURAL

NEW EXIT DRIVE/WALL TO S.W. 5th STREET

DATE: 8/8/23 DEANN BY: SCALE: AS NOTED CHECKED BY: SHEET: 1 OF: SHEETS SHEET NO. E9604A10101 A101

GATE OPERATION:

EXIT : GATE OPERATES AS AN EXIT GATE ONLY.

- 1. THE VEHICLE STOPS ON INNER LOOP, GATE OPENS,
- 2. THE VEHICLE PROCEEDS THRU OPENING PASSING OVER THE INNER AND OUTER LOOPS, AN IMPULSE IS TRANSMITTED TO HOLD THE GATE IN THE OPEN POSITION BY THE LOOPS AND PHOTO EYE.
- 3. THE TIMER CLOSES THE GATE AFTER THE VEHICLE HAS CLEARED THE OUTER LOOP.
- AN INFRARED LIGHT BEAM ALSO HOLDS THE GATE IN THE OPEN POSITION UNTIL THE VEHICLE HAS CLEARED THE OUTER LOOP.

FIRE DEPARTMENT ENTRY REQUIREMENTS

- PROVIDE KNOX VAULT COMPATIBLE WITH PEMBROKE PINES FIRE DEPARTMENT REQUIREMENTS, TOGGLE SWITCH OPEN SHALL OPEN GATE OPEN UNTIL TOGGLE SWITCH IS RETURNED TO CLOSED POSITION.
- 2. KNOX BOX SHALL BE MOUNTED ON CONCRETE WALL, SEE PLAN FOR LOCATION.
- GATE SHALL BE EQUIPED WITH A DIGITAL RADIO RECEIVER COMPATIBLE WITH PEMBROKE PINES FIRE DEPARTMENT'S SYSTEM. GATE SHALL OPEN UPON SIGNAL FROM FIRE DEPARTMENT REMOTE TRANSMITTER, AT A MINIMUM DISTANCE OF 20' FROM CATE.
- 4. ENTRY AND EXIT GATES SHALL OPEN WITH THE ABOVE TRANSMITTERS AND WITH THE USE OF THE TOGGLE SWITCH,

FIRE DEPARTMENT NOTES:

- 1. REVIEW AND APPROVAL BY THE AHJ SHALL NOT RELIEVE THE APPLICANT OF THE RESPONSIBILITY OF COMPLIANCE COMPLIANCE WITH THIS CODE PER NFPA 1:1.14.4.
- FIRE CODES IN EFFECT: FLORIDA FIRE PREVENTION CODE: FFPC 8th EDITION, EFFECTIVE DEC. 31, 2023 WITH BROWARD COUNTY AMENDMENTS WHICH INCLUDES NFPA 101, 2021 EDITION, NFPA 1, 2021 EDITION (ADOPTED REFERENCED REFERENCED PUBLICATIONS FOUND HEREIN).
- 3. COMMERCIAL AND RESIDENTIAL ENTRY AND INTERIOR GATES, ALL GATES REQUIRING FIRE DEPARTMENT ACCESS SERVING ACCESS TO ANY RESIDENTIAL OR COMMERCIAL BUILDING SHALL BE ELECTRICAL GATES AND SHALL BE OPERATED BY AN ELECTRICAL KEY OPERATED KINCK BOX WITH THE FIRE DEPARTMENT DECAL WITH DUST COVER AND A CLICAZENTER.
- ALL NEW AND EXISTING AUTOMATIC ENTRY GATES INSTALLED IN COMMERCIAL COMPLEX SHALL BE PROVIDED WITH A UNIVERSAL ACCESS SYSTEM AS PER THE FLORIDA FIRE PREVENTION CODE BROWARD COUNTY AMENDMENTS IN SECTION F-108.9.3.
- a, the C2E transmitter shall be mounted at a height of no less than 72°, and without any visual obstructions so that the transmitter led lights are easily seen by responding units.
- b. ACTIVATION-THE C2E TRANSMITTER WILL BE SET TO SINGLE PULSE MODE.
- c. Frequency—This is a conventional simplex channel, that is not on the P25 radio system, used for line—of—sight communications as well as in—vehicle repeater systems,
- d. LATCH BACK-THE GATE HOLD OPEN FEATURE WILL BE SET TO NON-OVERRIDE MODE OF TWO (2) MINUTES.
- e. RANGE OF OPERATION-THE C2E SETTING RANGE WILL BVE SET TO 50 FEET IN PORTABLE OPERATION.
- f. THE TECHNICAL ASSISTANCE & CUSTOMER SUPPORT NUMBER FOR C2E IS 877-939-3800
- g. CLICK 2 ENTER AUTHORIZED DEALERS CAN BE FOUND AT: https://click2enter.net/howtobuy.gsp?sn=Florida&sabrv=FL&sid=2&cid=1&v=1
- h. ALL GATE INSTALLATIONS SHALL COMPLY WITH THE REQUIREMENTS SET FORTH IN NFPA 1:18.2.4.2.
- i. ELECTRIC GATE OPERATORS AND SYSTEMS, WHERE PROVIDED, SHALL BE INSTALLED, MAINTAINED, LISTED, AND LABELED IN ACCORDANCE WITH UL 325 AS PER NFPA 1:18.2.4.2.6.1.
- THE OPERATION OF THE SLIDING GATE INITIATED BY BOTH THE ELECTRIC KNOX KEY & CLICKZENTER WILL
 MAINTAIN BOTH (RESIDENT & VISITOR) GATES OPEN AND SHALL BE SET TO ITS MAXIMUM ALLOWABLE TIME
- 6. UPON LOSS OF POWER, ALL GATES WILL REMAIN UNLOCKED AND OPENED.
- 7. PROVIDE THE CLEAR OPENING WIDTH FOR THE SLIDING GATE, MINIMUM 20' WIDE GATE.
- a, THERE SHALL BE A 14' MINIMUM WIDTH AT LEVEL 6' TO 8' FROM ROADWAY TO ACCOMODATE VEHICLE MIRRORS WHERE APPLICABLE.
- 8. SET GATE CLOSE TIME DELAY TO MAXIMUM ON GATE OPENER.
- PER NFPA 1:18.2.3.6.1. AND IN ACCORDANCE WITH UL325 WHERE REQUIRED BY THE AHJ, APPROVED SIGNS, APPROVED ROADWAY SURFACE MARKINGS, OR OTHER APPROVED NOTICES SHALL BE PROVIDED AND MAINTAINED TO IDENTIFY FIRE DEPARTMENT ACCESS ROADS OR TO PROHIBIT THE OBSTRUCTION THEREOF OR BOTH.
- 10, PER NFPA 1:18,2.3.6.2 A MARKED FIRE APPARATUS ACCESS ROAD SHALL ALSO BE KNOWN AS A FIRE LANE,
- 11. PLEASE PROVIDE SIGNAGE ON GATE STATING "EMERGENCY VEHICLE ONLY-NO PARKING AT ANY TIME".
- 12. PER NFPA 1:18.2.4.1.3* FACILITIES AND STRUCTURES SHALL BE MAINTAINED IN A MANNER THAT DOES NOT IMPAIR OR IMPEDE ACCESSIBILITY FOR THE FIRE DEPARTMENT OPERATIONS.


NOTES:


- (1) GATE MOTOR ELITE SL 3000 UL 1/2HP 120V ON CONCRETE SLAB 3'-0"x3'-0"x1'-0" WITH #4's AT 8' o/c EA, WAY, COORDINATE SLAB SIZE WITH AND MOTOR MOUNTING HEIGHT WITH WITH OPERATOR USED.
- ② FIRE DEPARTMENT KNOX BOX
- (3) 6"ø PIPE GUARD POST, SEE DETAIL THIS SHEET.
- (5) 20'-0"Wx8'-0"H CANTILEVER GATE WITH "DO NOT ENTER" SIGN, ANCHOR FENCE CO. DURAGLIDE II.
- 6 NEW 6'-0"H CHAINLINK FENCE TO MATCH EXISTING.
- TO STOP BAR AND SIGN, STOP BAR 20'-0"Lx2'-0"W.
- (8) CONTROL LOOPS.
- PROVIDE SHOP DRAWINGS FOR GATE AND CONTROLS.
- O CONTRACTOR SHALL LAY OUT GATE AND FENCING PRIOR TO ERECTION AND NOTIFY ARCHITECT OF ANY OBSTRUCTIONS.

NEW CHAINLINK FENCE:

PROVIDE SHOP DRAWINGS FOR FENCE SEALED BY SPECIALTY ENGINEER, COMPLIANCE WITH FBC 2023 CHAPTER 16 HVHZ AND BROWARD COUNTY COMPLIANCE WITH FBC 2023 SECTION 2224.



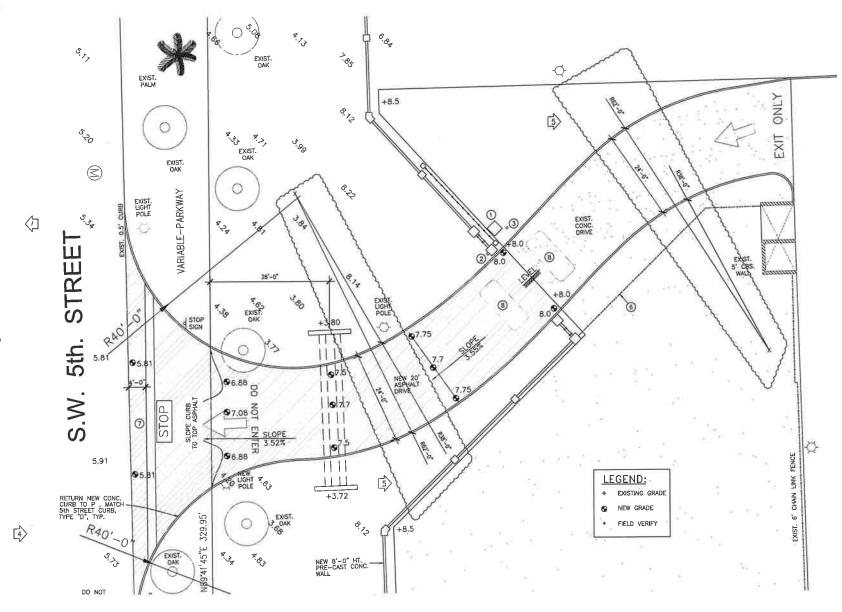

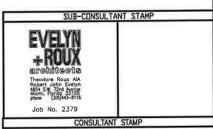



151 SE Cary Parkway, Suite 200 Cary, North Carolina 27518 P 919.851.8481 F 919.851.9703 www.engineereddesigns.com

REVISIONS / AUTHORIZATIONS

REVISIONS / AUTHORIZATIONS	DATE	87
ISSUED FOR CONSTRUCTION	11/28/23	TR
PERMIT COMMENTS	2/27/27	TR
DRC COMMENTS	9/24/24	TR
DRC CGMMENTS	3/12/25	TR
		ľ
	ISSUED FOR CONSTRUCTION PERMIT COMMENTS DRC COMMENTS	ISSUED FOR CONSTRUCTION 11/28/22 PERMIT COMMENTS 2/22/27 DRC CCMMENTS 9/24/24

PROPRIETARY AT&T INFORMATION

NOT FOR CENERAL USE OR DISCLOSURE OUTSIDE OF AT&T
THIS INFORMATION MAY ONLY BE USED BY AUTHORIZED
FERSONNEL OF THE LOCAL GOVERNMENT ACENCY IN CONNECTION
WITH APPLICATION FOR PERMITS AND AUTHORIZATIONS FOR
BUILDINGS, CONSTRUCTION, AND/ OR ZCHING CHANGES.



AT&T CORPORATE REAL ESTATE

PEMBROKE PINES S.O.C.

13900 PINES BLVD. PEMBROKE PINES


PARTIAL SITE PLAN ARCHITECTURAL


NEW EXIT DRIVE/WALL TO S.W. 5th STREET

DATE: 8/8/23 SCALE: AS NOTED
DRAWN BY: DREDSED BY: SHEET: 1 OF: SHEETS E9604A10102 A102

DRIVEWAY PLAN
SCALE: 1" = 10'-0"



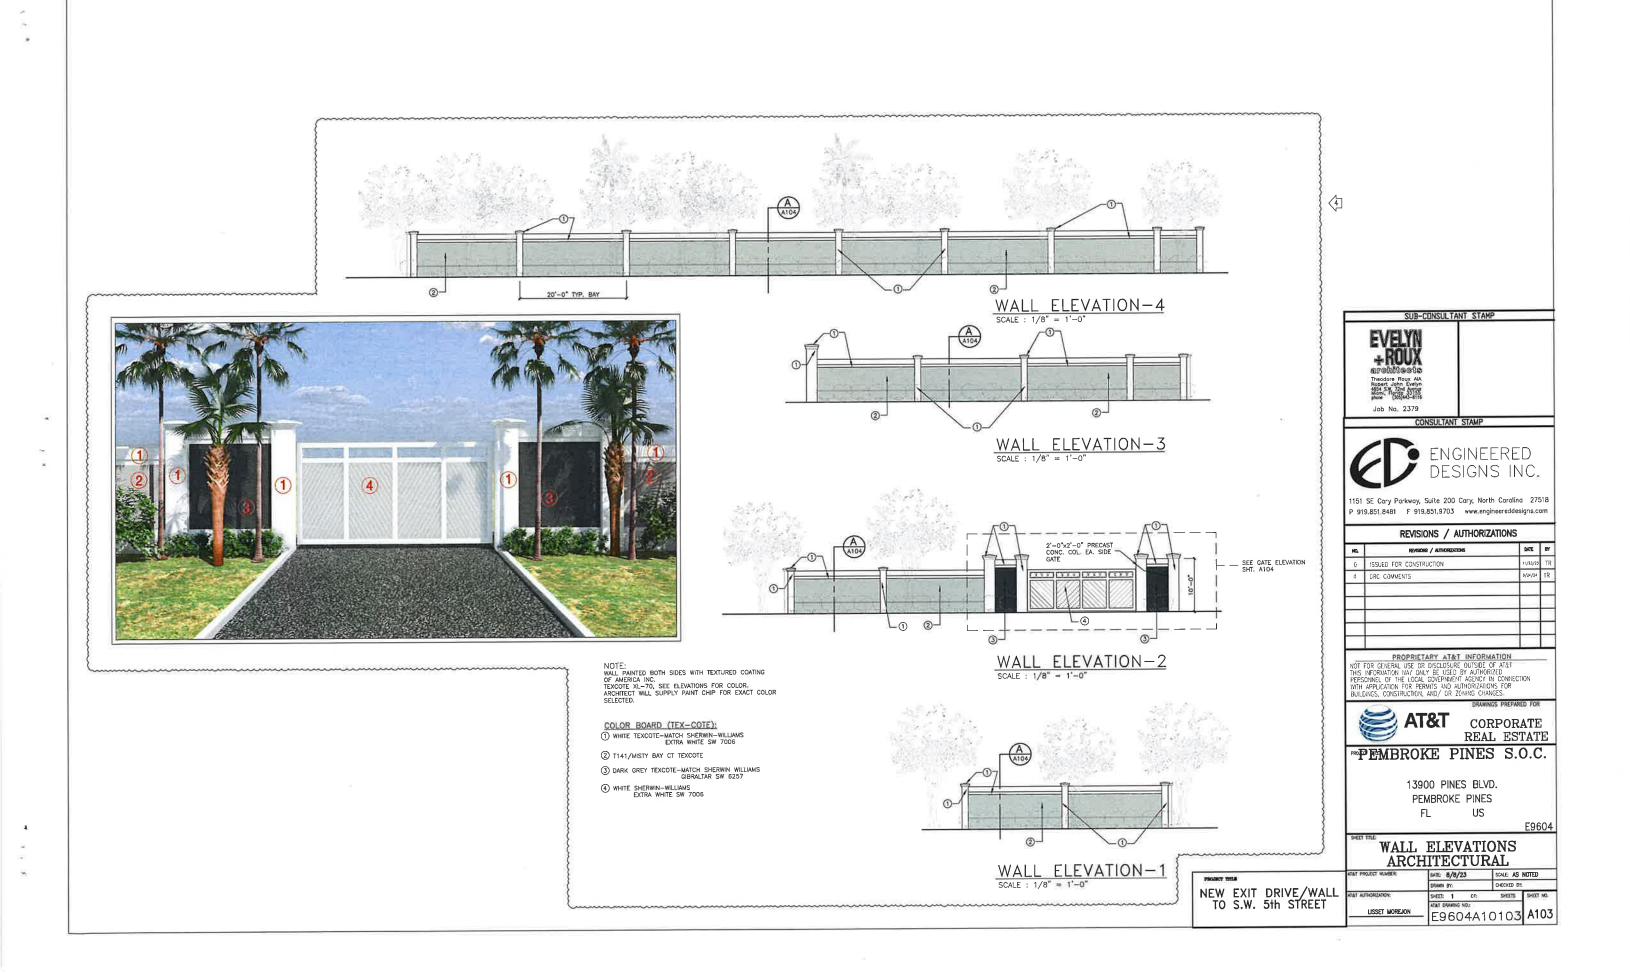

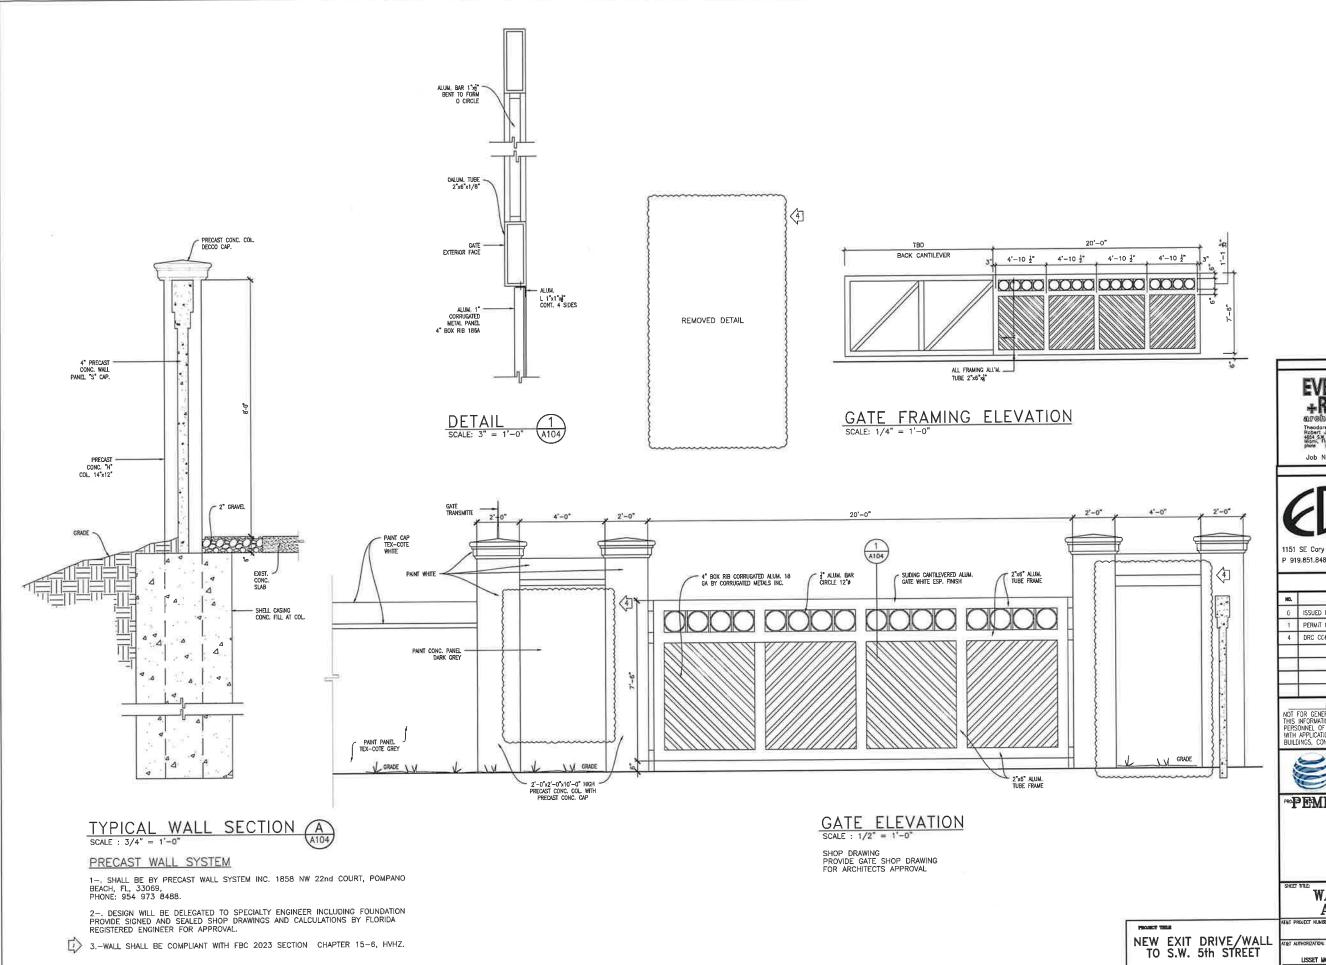

SUB-CONSULTANT STAMP Job No. 2379



1151 SE Cary Parkway, Suite 200 Cary, North Carolina 27518 P 919.851.8481 F 919.851.9703 www.engineereddesigns.com

REVISIONS / AUTHORIZATIONS

NO.	REVISIONS / AUTHORIZATIONS	DATE	BY
0	ISSUED FOR CONSTRUCTION	11/28/23	TR
1	PERMIT COMMENTS	2/27/24	
4	DRC COMMENTS	9/24/24	TR
			_
			_
			_

PROPRIETARY AT&T INFORMATION

NOT FOR GENERAL USE OR DISCLOSURE OUTSIDE OF AT&T
THIS INFORMATION MAY ONLY BE USED BY AUTHORIZED
PERSONNEL OF THE LOCAL GOVERNMENT ACENCY IN CONNECTION
WITH APPLICATION FOR PERMITS AND AUTHORIZATIONS FOR
BUILDINGS, CONSTRUCTION, AND/ OR ZONING CHANCES.



REAL ESTATE


PEMBROKE PINES S.O.C.

13900 PINES BLVD. PEMBROKE PINES FL

E9604

WALL ELEVATIONS ARCHITECTURAL

DATE: 8/8/23 DRAWN BY: SCALE: AS NOTED
CHECKED BY: E9604A10104 A104

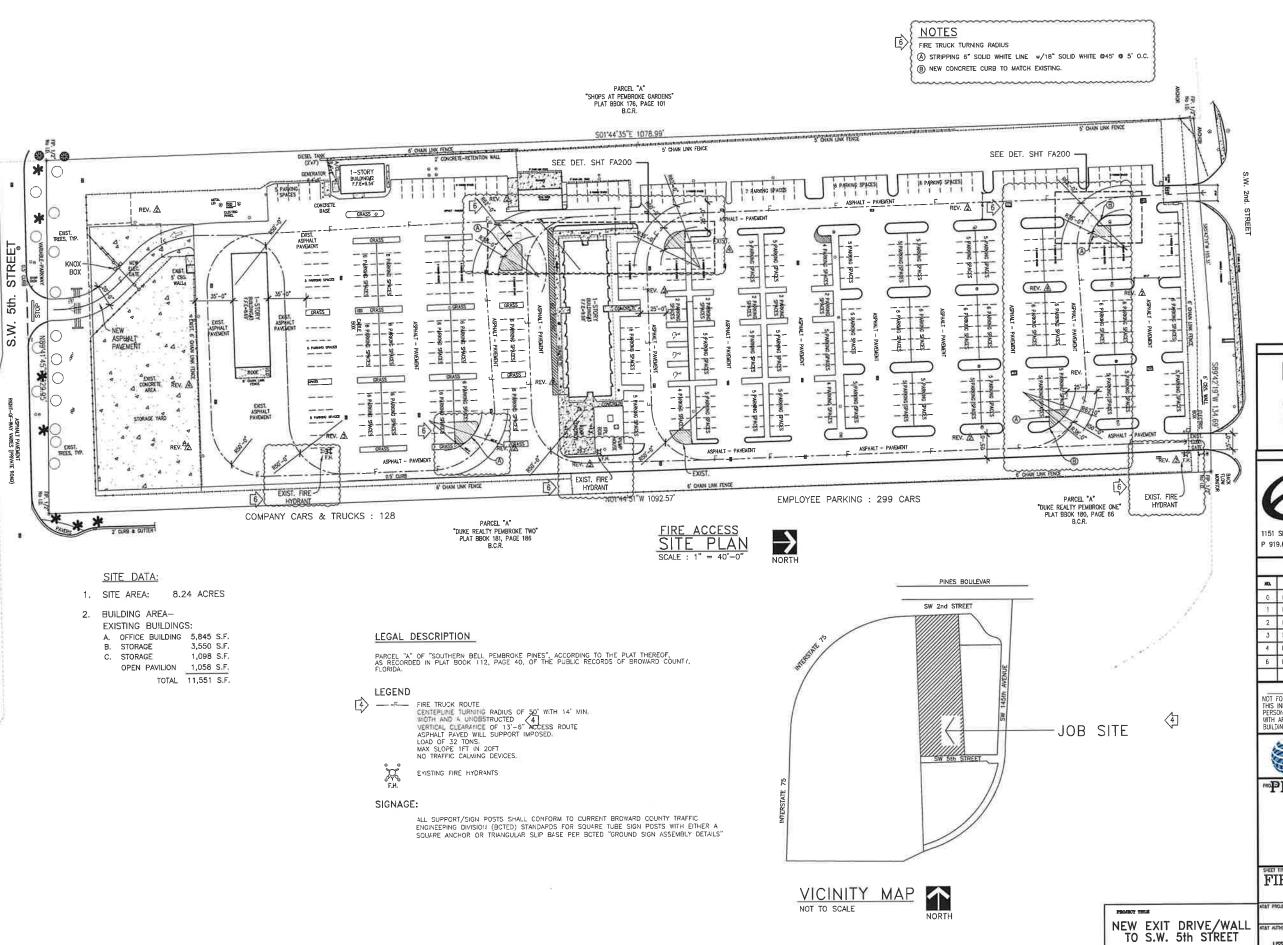


ENGINEERED DESIGNS INC.

1151 SE Cory Parkway, Suite 200 Cary, North Carolina 27518
P 919.851.8481 F 919.851.9703 www.engineereddesigns.com

	REVISIONS / AUTHORIZATIONS				
HD.	NEWSONS / AUTHORIZATIONS	DATE	BY		
0	ISSUED FOR CONSTRUCTION	11/28/23	TR		
1	PERMIT COMMENTS (NEW SHEET)	2/21/24	TR		
2	FIRE COMMENTS	7/1/24	TR		
3	FIRE COMMENTS	1/22/24	TR		
4	DRC COMMENTS	9/24/24	TR		
6	DRC COMMENTS	1/15/25	TR		

NOT FOR GENERAL USE OR DISCLOSURE OUTSIDE OF ATAT
THIS INFORMATION MAY ONLY BE USED BY AUTHORIZED
FERSONNEL OF THE LOCAL GOVERNMENT ASSINCT IN CONNECTION
WITH APPLICATION FOR PERMITS AND AUTHORIZATIONS FOR
BUILDINGS, CONSTRUCTION, AND/ OR ZENING CHANGES.

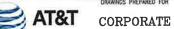



REAL ESTATE


PEMBROKE PINES S.O.C.

13900 PINES BLVD. PEMBROKE PINES FL US

E9604

FIRE ACCESS SITE PLAN CIVIL


ATAT PROJECT WINSER:	DATE: 8/8/23	SCALE: AS NOTED
	DRAWN BY:	CHECKED BY:
ATAT AUTHORIZATION:	SHEET: 1 OF:	SHEETS SHEET NO.
LISSET MOREJON	E9604FA	10100 FA100

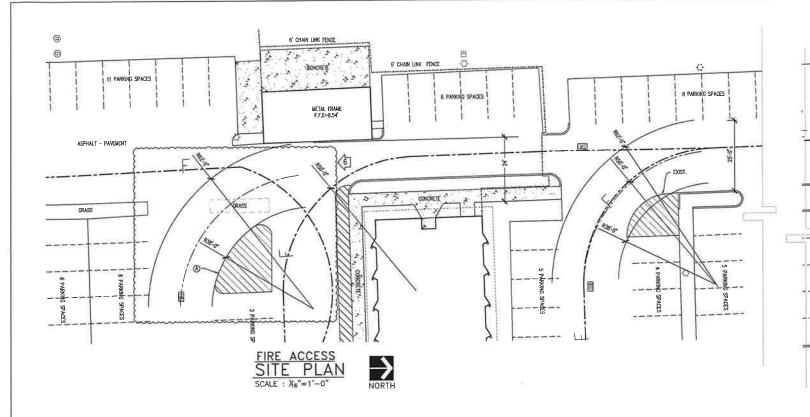

FIRE DEPARTMENT NOTES

- 1. A PROVIDE KNOX VAULT COMPATIBLE WITH PEMBROKE PINES FIRE DEPARTMENT REQUIREMENTS, TOGGLE SWITCH OPEN POSITION SHALL OPEN GATE OPEN UNTIL TOGGLE SWITCH IS RETURNED TO CLOSED POSITION.
- B KNOX BOX SHALL BE MOUNTED AT GATE ENTRANCE, SEE PLAN FOR LOCATION.
- C GATE SHALL BE EQUIPPED WITH A DOGITAL RADIO RECEIVER COMPATIBLE WITH PEMBROKE PINES FIRE DEPARTMENT'S SYSTEM. CATE SHALL OPEN UPON SIGNAL FROM FIRE DEPARTMENT REMOTE—TRANSMITTER, AT A MINIMUM DISTANCE OF 20' FROM GATE
- D ENTRY AND EXIT GATES SHALL OPEN WITH THE ABOVE TRANSMITTERS AND WITH THE USE OF TOGGLE SWITCH.
- E UPON LOSS OF POWER, ALL GATES WILL REMAIN UNLOCKED AND OPENED.
- 2. A A UNOBSTRUCTED VERTICAL CLEARANCE OF NOT LESS THAN $13^\prime 6^*$ SHALL BE MAINTAINED IN FIRE APPARATUS ACCESS ROADS.
- B PERMANENT, WEATHERPROOF SIGNAGE WILL BE REQUIRED FOR THE FIRE APPARATUS ACCESS ROUTES.
- D THERE SHALL BE A 14' MINIMUM WIDTH AT LEVEL 6' TO 8' FROM ROADWAY TO ACCOMMODATE VEHICLE MIRRORS WHERE APPLICABLE.
- E MINIMUM REQUIRED WIDTHS AND CLEARANCES ESTABLISHED UNDER 18.2.3.5 SHALL BE MAINTAINED AT ALL TIMES, NFPA 1-18.2.4.1.2. 3. FIRE APPARATUS ACCESS ROADS SHALL BE DESIGNED AND MAINTAINED TO SUPPORT THE IMPOSED LOADS OF FIRE APPARATUS (WEIGHTING A MINIMUM OF 32 TONS) AND SHALL BE PROVIDED WITH AN ALL-WEATHER DRIVING SURFACE, NFPA-1:18.2.3.5.2.
- NOTE: ROADS DURING CONSTRUCTION:
 HARD COMPACTED SURFACE SUPPORTING 32 TONS SHALL BE PROVIDED ON ROADS FOR FIRE APPARATUS TO ACCESS OF BUILDINGS UNDER CONSTRUCTION.
- 4. THE ANGLE OF APPROACH AND DEPARTURE FOR ANY MEANS OF THE FIRE APPARATUS ACCESS ROADS SHALL NOT EXCEED 1 FT DROP IN 20 FT OR DESIGN LIMITATIONS OF THE FIRE APPARATUS OF THE FIRE DEPARTMENT AND SHALL BE SUBJECT TO APPROVAL BY THE AHJ.
- 5. THE DESIGN AND USE OF TRAFFIC CALMING DEVICES SHALL REQUIRE APPROVAL BY THE AHJ AND COPP ENGINEERING DEPARTMENT. NFPA-1:18.2.-3.5.7.
- 6. WHERE REQUIRED BY THE AJH, APPROVED SIGNS, APPROVED ROADWAY SURFACE MARKING, OR OTHER APPROVED NOTICES SHALL BE PROVIDED AND MAINTAINED TO IDENTIFY FIRE APPRAVATUS ACCESS ROADS OR TO PROHIBIT THE OBSTRUCTION THEREOF OF BOTH.

 NFPA-1:18.2.3.6.1.
- A THE DESIGNATION OF THE FIRE LANES OR FIRE ZONES ON PRIVATE PROPERTY SHALL BE ACCOMPLISHED AS SPECIFED BY THE CITY FIRE CHIEF OR A SUBDRDINATE APPOINTED BY HIM TO PERFORM THIS DUTY. SIGNS SHALL BE POSTED DESIGNATING SUCH FIRE LANES OR ZONES. COPP CO 93.12.
- B. FIRE LANES SHALL BE DESIGNATED BY YELLOW THERMOPLASTIC PAINT, STRIPING, KING OF CURBS AND ROADWAY BETWEEN EACH FIRE LANE, SIGN(S) SHALL BE PROVIDED.
- C. FIRE LANE SIGN(S) SHALL BE 18" BY 24" AND SHALL BE MARKED WITH FREESTANDING SIGNS WITH THE WORDING. "NO PARKING FIRE LANE BY ORDER OF THE FIRE DEPARTMENT" OR SIMILAR WORDING, SUCH SIGNS SHALL BE 12 IN BY 18 IN IN WHITE BACKGROUND AND RED LETTERS AND SHALL BE A MAXIMUM OF SEVEN FEET IN HEIGHT FROM THE ROADWAY TO BE THE BOTTOM PART OF THE SIGN. THE SIGNS SHALL BE WITHIN SIGHT OF THE TRAFFIC FLOW AND BE MAXIMUM OF OF FEET APART. NFPA-1:18.2.3.6.3.
- ALL SUPPORT/SIGN POSTS SHALL CONFORM TO CURRENT BROWARD COUNTY TRAFFIC ENGINEERING DIVISION (BCTED) STANDARDS FOR SQUARE TUBE SIGH POSTS WITH EITHER A SQUARE ANCHOR OR TRANSGULAR SLIP BASE PER BCTED 'GROUND SIGN ASSEMBLY DETAILS". NOTE: DETAIL THIS SHIT.

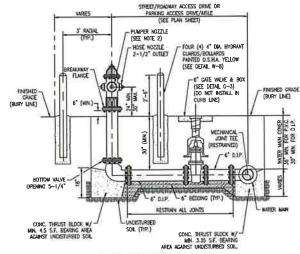

FIRE HYDRANT DETAIL

NOTES:

- 1. FIRE HYDRANT SHALL HAVE A MINIMUM 5 4" BOTTOM VALVE WITH A 4 4" PUMPER NOZZLE AND TWO (2) 2 4" HOSE NOZZLE OUTLETS. FIRE HYDRANT SHALL BE FACTORY PAINTED D.S.H.A. YELLOW.
- 2. BURY DEPTH FOR FIRE HYDRANT IS 3 FEET & 6 INCHES ABOVE THE FINISHED FLOOR LEVEL.
- PUMPER NOZZLE OF THE FIRE HYDRANT TO FACE THE NEAREST ADJACENT STREET / MARKER (RPM) SHALL BE INSTALLED IN THE CENTER OF THE TRAVEL LANE OF THE NEAREST ADJACENT STREET / ROADWAY, ACCESS DRIVE OR PARKING ACCESS / DRIVE.
 4. HYDRANT GUARDS / BOLLARDS SHALL BE PROVIDED AROUND THE FIRE HYDRANT AS SHOWN
- WHEN THE FIRE HYDRANT IS LOCATED WITHIN SIX (6') FEET OF THE EDGE OF PAVEMENT OF A PUBLIC / FACE OF CURB OF AN ACCESS DRIVE, PARKING ACCESS DRIVE / AISLE OR "TURNING RADIUS".
- 5. A SEVEN AND A HALF (7 %) FOOT CLEAR RADIUS AROUND THE FIRE HYDRANT SHALL BE MAINTAINED AT ALL TIMES.
- 6. FIRE HYDRANT GATE VALVE SHALL BE INSTALLED AS CLOSE AS POSSIBLE TO THE "SUPPLY MAIN". SHOULD THE DISTANCE FROM THE "SUPPLY MAIN" TO THE FIRE HYDRANT LOCATION EXCEED TWENTY (20) FEET THEN A SECOND GATE VALVE IS REQUIRED TO BE INSTALLED AT THE HYDRANT.
- 7. PIPING AND ASSEMBLY SHALL BE PAINTED WITH LINEAR POLYURETHANE COATING OR CITY APPROVED EQUAL BASED UPON MANUFACTURER'S RECOMMENDATION PER APPLICATION. 8. ALL CONTROL VALVES OR GATES TO BE CHAINED AND LOCKED.

Ground Sign Assembly Details


(A) STRIPPING 6" SOLID WHITE LINE w/18" SOLID WHITE @45' @ 5' O.C,

NOTES

FIRE TRUCK TURNING RADIUS

(B) NEW CONCRETE CURB TO MATCH EXISTING.

6

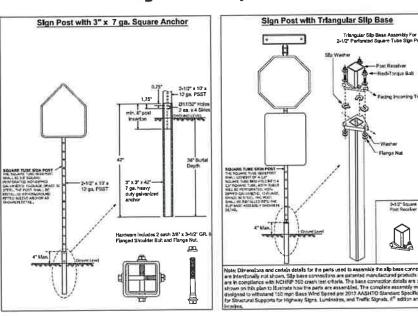



SUB-CONSULTANT STAMP

2nd

S

TREET

S85°42'19"W



1151 SE Cary Parkway, Suite 200 Cary, North Carolina 27518 P 919.851.8481 F 919.851,9703 www.engineereddesigns.com

REVISIONS / AUTHORIZATIONS				
140.	REVISIONS / AUTHORIZATIONS	DATE	BY	
5	NEW SHEET	11/27/24	TR	
6	DRC COMMENTS	1/15/25	TR	
			H	
_			Н	

PROPRIETARY AT&T INFORMATION NOT FOR CENERAL USE OF DISCLOSURE OUTSIDE OF ATAIT
THIS RECONATION MAY ONLY BE USED BY AUTHORIZED
PERSONNEL OF THE LOCAL COMPENDENT ACCOUNT OF CONJECTION
WITH APPLICATION FOR PERMITS AND AUTHORIZATIONS FOR
BUILDINGS, CONSTRUCTION, AND/ OR ZENING CHANGES.

AT&T CORPORATE REAL ESTATE


PEMBROKE PINES S.O.C.


13900 PINES BLVD. PEMBROKE PINES US FL

E9604

FIRE ACCESS SITE PLAN CIVIL

TOTAL TIME	AT&T PROJECT NUMBER:	DATE: 11/27/24	SCALE: AS NOTED	
71111		DRAWN BY:	CHECKED BY:	
	AT&T AUTHORIZATION:	SHEET: 1 OF:	SHEETS	SHEET NO.
TO S.W. 5th STREET	LISSET MOREJON	E9604FA1	0200	FA200

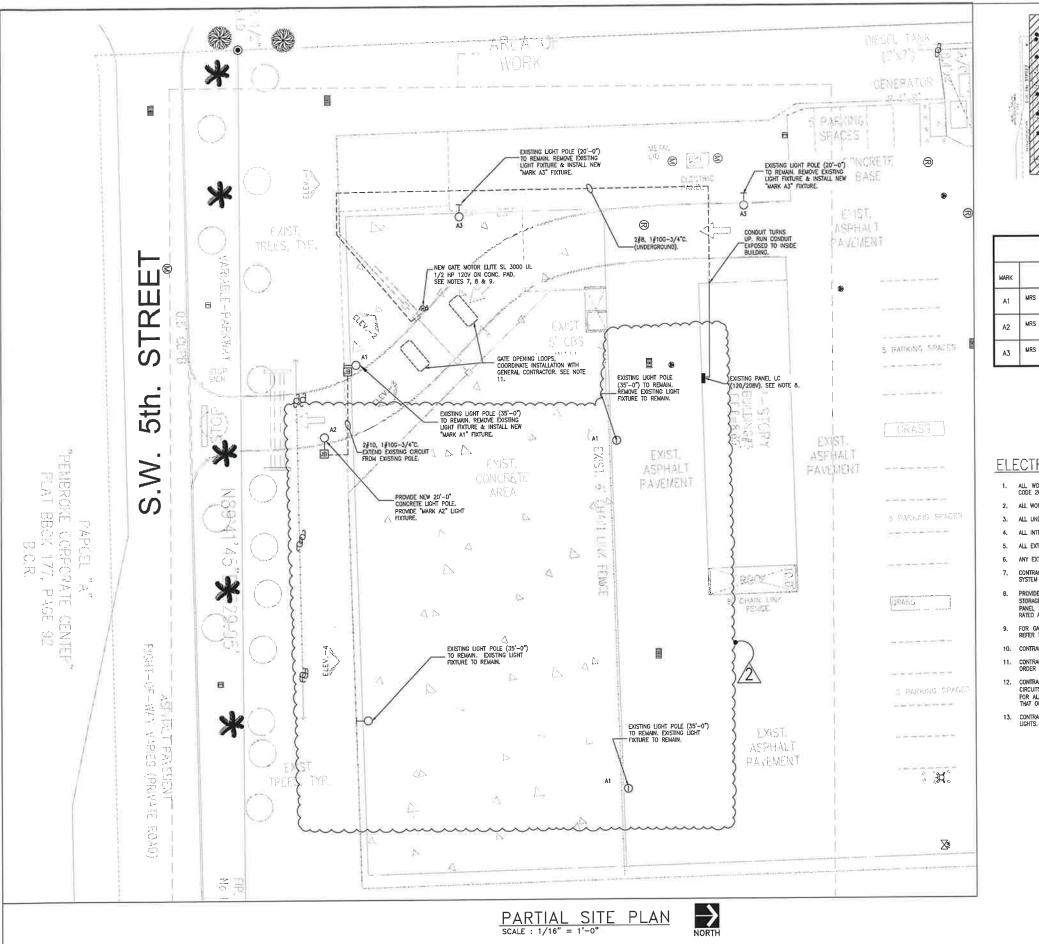

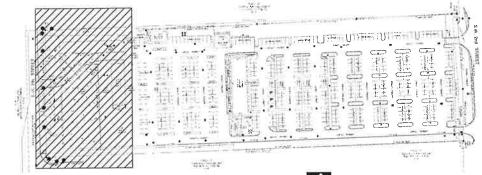

SITE MAP



LUMINAIRE SCHEDULE LUMINAIRE SERIES DESCRIPTION MANUFACTURER VOLTS INPUT WATTS NOTES TYPE MRS OUTDOOR LED AREA RS-LED-18L-SIL-3-30-700 LSI INDUSTRIES ~~~ 111 LED -LED-09L-SIL-RC-30-70CR UNIV ~~~ MRS OUTDOOR LED AREA LIGHT LED S-LED-24L-SIL-3-30-TOCK

CONTACT AT GENESIS LIGHTING: ANDREW GUEVARA, tel. 786-502-5770 aguevara@genesislighting.net

ELECTRICAL NOTES

- ALL WORK SHALL COMPLY WITH FLORIDA BUILDING CODE 2023, NATIONAL ELECTRICAL CODE 2020 & OTHER APPLICABLE LOCAL CODES.
- 2. ALL WORK SHALL BE COORDINATED WITH THE BUILDING MANAGER.
- 3. ALL UNDERGROUND CONDUITS SHALL BE PVC.
- 4. ALL INTERIOR CONDUIT SHALL BE EMT.
- 5. ALL EXTERIOR JUNCTION BOXES LOCATED IN THE GROUND SHALL BE TRAFFIC RATED.
- . ANY EXTERIOR ABOVE GROUND CONDUITS SHALL BE GALVANIZED RIGID STEEL.
- 7. CONTRACTOR SHALL COORDINATE CONDUCTOR REQUIREMENTS FOR A FULLY OPERATIONAL SYSTEM WITH THE VENDOR PROVIDING GATE EQUIPMENT.
- B. PROVIDE (1) NEW 1P, 20A CIRCUIT BREAKER IN PANEL LC SPACE 28 LOCATED IN STORAGE BULDING \$3 TO FEED NEW MOTORIZED CATE. IDENTIFY CIRCUIT AND UPDATE PANEL DIRECTORY. EXISTING PANEL LC IS SQUARE D TYPE NOOB, 120/2084, 36, 4W RATED AT 150A MCB PANEL
- FOR GATE SEQUENCE OF OPERATION AND DETAILS OF GATE, BOLLARDS AND ENTRANCE, REFER TO ARCHITECTURAL SHEETS.
- 10. CONTRACTOR SHALL PATCH ASPHALT AFTER CONDUIT INSTALLATION,
- 11. CONTRACTOR SHALL PATCH, PAINT AND FIRE SEAL ANY HOLES CREATED IN WALLS IN ORDER FOR CONDUIT INSTALLATION.
- 12. CONTRACTOR SHALL RE-USE EXISTING LIGHTING CIRCUIT FOR NEW LIGHT FIXTURES. EXTEND CIRCUITS AS NECESSARY, EXISTING LIGHTING CONTROLS SHALL BE MAINTAINED. (TYPICAL FOR ALL NEW FIXTURES). TOTAL LOAD ON NEW LUMINARES IS EQUAL TO OR LESS THAN THAT OF EXISTING LUMINAIRES.
- 13, CONTRACTOR SHALL TRACE, IDENTIFY AND LOCATE EXISTING CIRCUIT SERVING EXISTING LIGHTS.

SUB-CONSULTANT STAMP

ProCon Engineering, Inc.
MEP Engineering Consultants

7240 S.W. SWIE TERRACE MIAMI, FLORIDIA S3155 FFICE: (305) 2822-7850 FLK:(305) 265-7798 E-MAIL: proconenginears@bellsouth.net CA #9374 ProCon #: 24-04



CONSULTANT STAMP



1151 SE Cary Parkway, Suite 200 Cary, North Carolina 2751

REVISIONS / AUTHORIZATIONS

NO	REVISIONS / AUTHURIZATIONS	DATE	41
0	ISSUE FOR CONSTRUCTION.	01/30/24	AP/TA
◬	REVISION 3.	08/07/24	AP/FA
_			H
			_

PROPRIETARY AT&T INFORMATION

NOT FOR GENERAL USE OR DISCLOSURE DUTSIDE OF ATLT

THIS INFORMATION MAY DIM, YE USED BY AUTHORIZED
PERSONNEL OF THE LOCAL GOVERNMENT AGENCY IN CONNECTION
WITH APPLICATION FOR PERHITS AND AUTHORIZATIONS FOR
BUILDINGS, CONSTRUCTION, AND/ OR ZUNING CHANGES.

DRAVINGS PREPARED FOR



CORPORATE REAL ESTATE

PROJECT THUPROJECT DRAWING


01 13900 PINES BLVD PEMBROKE PINES


FL US HLWDFL09 143829.01.01

> PARTIAL SITE PLAN NEW WORK

AT&T PEMBROKE PINES SOC NEW GATE

ATET PROJECT MUNBER	DATEG1/30/2024	SCALE: N.T.S.	
	DRAWN BY: A.P.	CHECKED BY: F.A.	
ATET AUTHORIZATION	DECT) 1 DF: 5	SHEETS SHEET NO.	
LISSET MOREJON	ATET BRAVING NO	01E01	

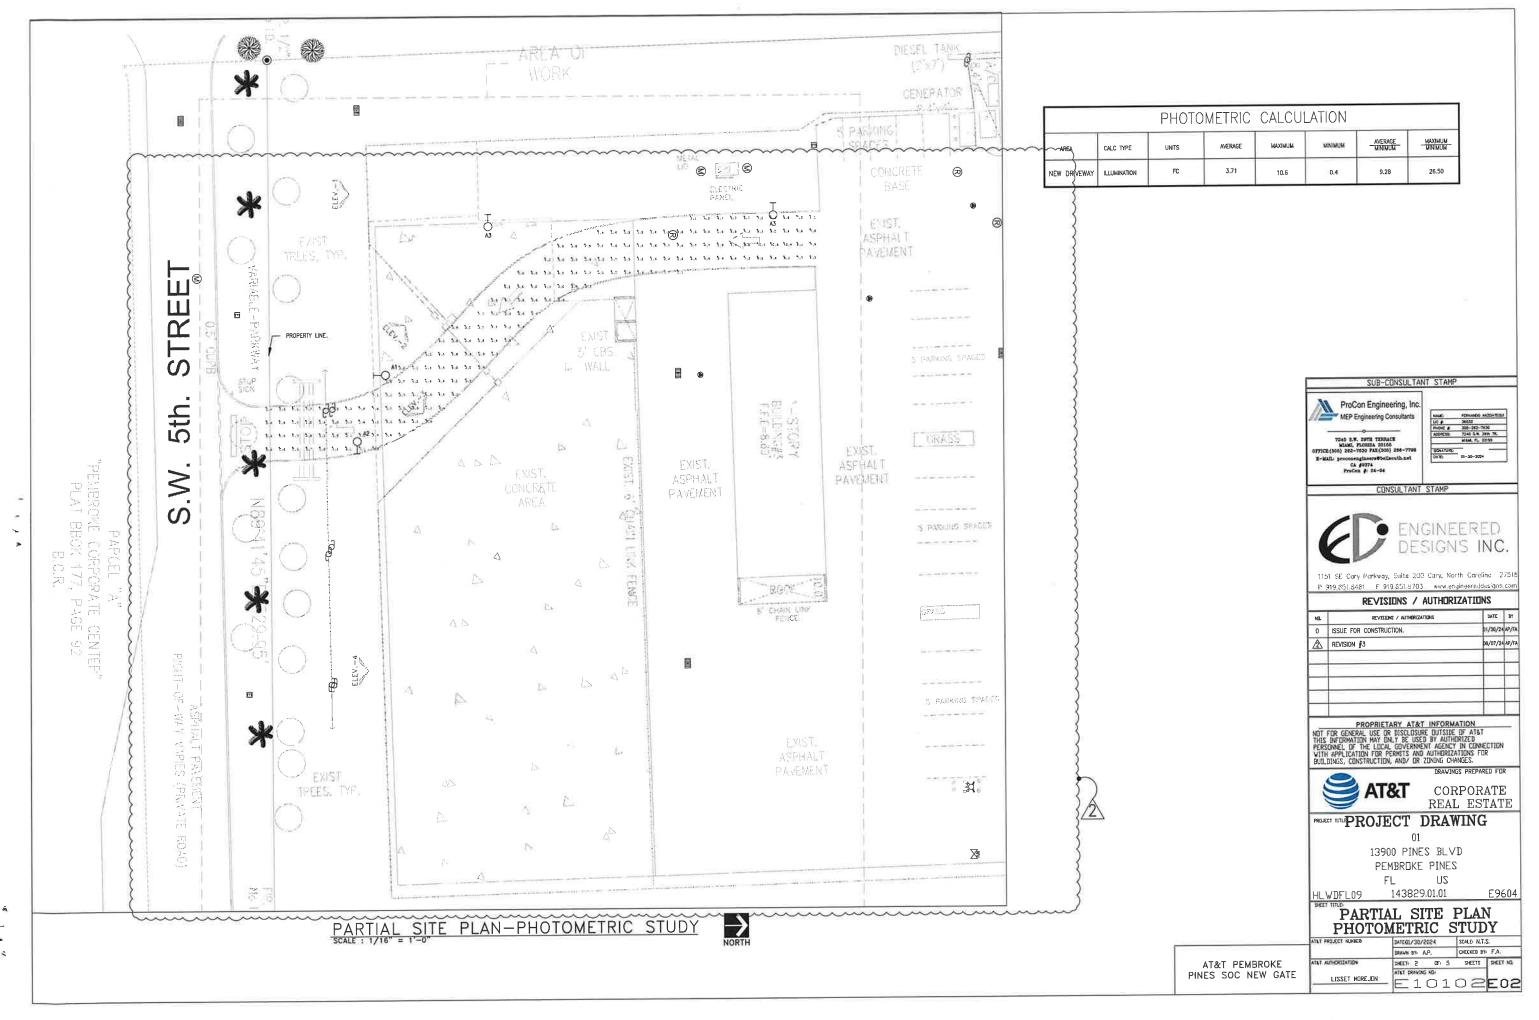

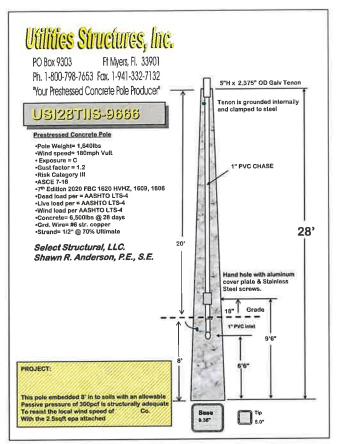



NEW POLE SPEC SHEET


SCALE: NOT TO SCALE

12


4

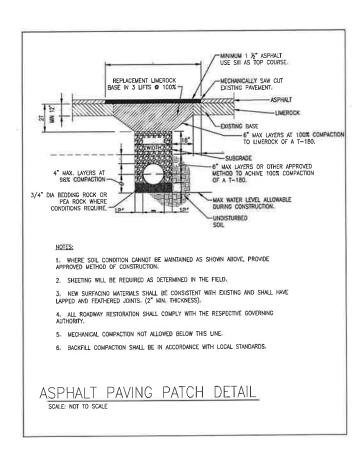

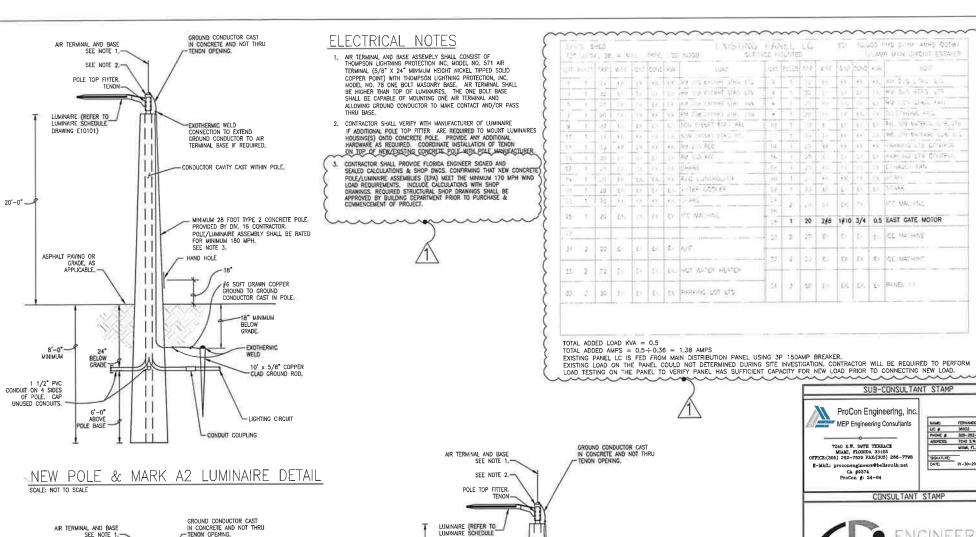

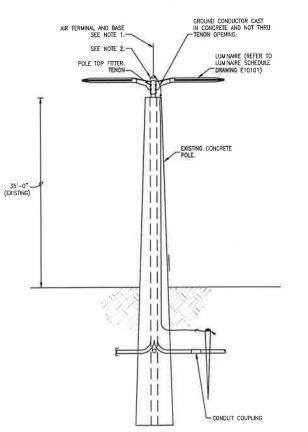

(APPLICABLE FOR 2 EXISTING 35'-0" POLES) MARK A1- 180 DEGREES APART LUMINAIRE DETAIL SCALE: NOT TO SCALE

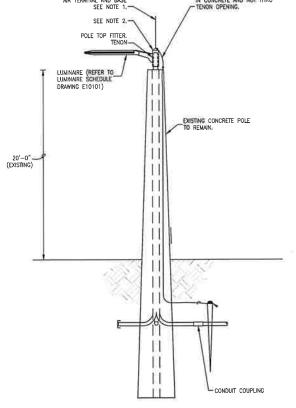

(APPLICABLE FOR 2 EXISTING 20'-0" POLES) MARK A3 LUMINAIRE DETAIL SCALE: NOT TO SCALE

SUB-CONSULTANT STAMP

ProCon Engineering, Inc. MEP Engineering Consultants

7240 S.W. SPTH TERRACE MIAMI, FLORIDA 38165 FFICE:(306) 252-7830 PAX:(305) 286-7798 roconengineers@bel CA #9374 ProCon #: 24-04



CONSULTANT STAMP



1151 SF Cory Parkway Suits 200 Cary, North Caroline 2. P 919 801 8481 F 919 051 9703 Aww engineere ides gno c

REVISIONS / AUTHORIZATIONS

INC 4 1010140 / HOTTIDIALETTICA			
NO.	REVISIONS / AUTHORIZATIONS	DATE	BY
0	ISSUE FOR CONSTRUCTION	01/30/24	AP/F
1	REV#1-BLDG DEPT. COMMENTS	03/08/24	RP/TI

PROPRIETARY AT&T INFORMATION NOT FOR GENERAL USE OF DISCLOSURE OUTSIDE OF ATET
THIS INFORMATION MAY DNLY BE USED BY AUTHORIZED
PERSONNEL OF THE LOCAL SOVERMENT AGENCY IN CONNECTION
WITH APPLICATION FOR PERMITS AND AUTHORIZATIONS FOR
BUILDINGS, CONSTRUCTION, AND/ OR ZONING CHANGES.



CORPORATE REAL ESTATE

E9604

ROJECT TITLEPROJECT DRAWING

13900 PINES BLVD PEMBROKE PINES

143829.01 ILWDFL09

ELECTRICAL DETAILS

PRICOT\30\5054 SCALE: N.T.S.
CHECKED BY: F.A. DRAVN BY: A.P. AT&T PEMBROKE SHEETS 3 DF: 5 SHEETS SHEET MO. PINES SOC NEW GATE E50003**E03**



Modular Board - Uses LEDs to indicate all Input and output functions of the gate operator.

ERD - If the gate hits a vehicle while closing, it re-opens if it hits a vehicle while opening, it stops, reverses 4 to 6 inches and stops again.

Electronic Inputs - Radio receiver, key switch, safely loop, canter loop, telephone entry system, computer input, fire dept, key match & 3 push-button station.

Timer - Adjustable timer can be set from 0 to 60 seconds

Power Input On/Oil Switch - Controls power input to the board with convenient switch.

Burglar Alarm - With Omni Option board, interfaces with existing home alarm or elarm output.

3 Push Button Control - On board gale operator control for close, stop, and open.

S THE SL-3000-UL

The SL-3000-ULT is smooth and exceptionally quiet. This unit can handle continuous cycles daily with gales up to 1000 his. and 37 ft. in length and has a traveling speed of 12 linches per second, it is designed for high traffic applications such as heavily accessed galed communities and commercial buildings.

The SL-3000 Series slide gate operators are Ine St.-3000 Senes side gate operators are used by high demand customers and are the most popular stide gate operators in the country. Users include large development and management companies, as well as prestigious residential gated communities and custom homes.

Spike Suppressors - 20,000 Amps and new lighting protection with modular orani surge suppressor. Initial response time: 0 000000000001 seconds. Alternate Outputs – With Omni Option Board 3 push button command control, burglar alarm input and output, QCC option available.

Soft Step — Gate travels through the cycle at normal speed and comes to a step slowly for more accurate gate cycle. Equipped with integrated time delay for long mechanical life expectancy.

120 VAC Power - Built-In 120 VAC power receptacle (NEMA 5-15)

Motor Orive - Solid-State electronic motor drivé system is incorporated into board.

Safety Alarm — If the gate his an object brice while opening or dosing, the system will shall down and atom will sound be feet eliminate. After the minutes the system will submarkedly rood listelf. To reject the system during the live minutes, a manual reset button must be used.

Electrical Specifications

THE SL-3000-UL™ SERIES SLIDE GATE OPERATORS

Limit switch device with high speed ball bearings

Elite's operators are skillfully crafted in the USA. Every unit is curefully inspected both electronically and mechanically to provide the quality expected. Elite uses computer elided design to assure the most precise fit for their operator components. High quality and years of proven reliability places Elite St. Series slide gate operators ahead of the competition.

-#41 chain is guided by two slotted UHMW rollers which prevent the chain from slipping off of the drive sprocket, thereby requiring loss maintenance.

The SL Series use a solid steel, machined pulley and notched v-groove belt for highly efficient torque transfer from motor to gear reducer.

The 1/2 HP, instant reversing parking gate motor uses high speed ball bearings for a smooth and quiet operation. High density ·A highly efficient, extremely quiet, 30 to 1 worm gear

reversing

and oil bath

Mecanical Specifications

Chassis - Constructed with 1/4" sanded, welded, and gold zinc plated sheet metal. Worm Gear Reduction - 30-to-1 worm gear reduction in an oil bath.

Motor - 1/2 hp, instant reversing, 120VAC, 4 amp, 1625 rpm, high speed ball bearings.

Cover - High density polyethylene plastic for excellent heat and corresion resistance. Finishing - All metal parts are gold zinc plated for rust proof protection.

Weight - 112 lbs Shipping - 130 lbs.

Emergency Release - Hand crank is standard. Best option is our DC-1000U™.

Cycles - Continuous Output Shaft - 1" cold rolled sleet

itles – Maximum gate length 37'. Maximum gate weight 1000 lbs.

Gate Traveling Speed' - 12" per second average.

Dimensions - L18" X W19" X H25" Approval - ETL and UL Listed and compliant to UL325 and UL991 slandards.

S THE SL-3000-UL

THE SL-3000-UL™ SERIES SLIDE GATE OPERATORS

FEATURES OF THE SL-3000-UL™ SLIDE GATE OPERATOR



The SL-3000-ULTM is manufactured with a precision limit switch system. This system uses high speed ball bearings and high quality components for efficiency.



REVERSING SENSOR

The digital current sensor continuously monitors the motor current, it can be set but both the opening and closing cyclos. If the gate is closing and his a whiche, the secure detects the increased lead on the motor and meresals. If the gate is copening and his a whiche, it stops and meresals — to be entained to the companing and his a whiche, it stops and meresals — to be entained to the country of the control is smart crought to operate on oth level installations and not to react to when resistance.







QUICK CLOSE CIRCUIT

The QCC is a function of Eites' slide gate operators that can be enabled by installation of a optional "Gode Button" into the OmniOption control board sold exclusively by Eite. Recommended for large gates, 16 feet and longer, this unit is ideal for inductival opplications (six storage leciblies, werehouses, and gated communities with a guard house. The illustrations below visually describe the effectiveness of the QCC. Picture #1: The authorized ownnand vehicle entires and leaves the loop. Picture #2: The gate closes as the surfacilities entire and leaves the foot. Picture #2: The gate closes as the surfacilities entire and leaves the foot. Picture #3: Unauthorized vehicle stempts to enter, but GCC stops the gate, which forces the unauthorized vehicle to either move ahead (if there is room) or back up. QCC will not reset until the unauthorized vehicle has cleared the loop.



Design and specifications subject to change without notice

THE SL-3000-UL" SERIES SLIDE GATE OPERATORS

All new U.L. model Eite SL-3000-U.L.** commercial slide gate operators now use the OmniCortirol** board for enhanced, reliable operation conforming to the new UL-325 and UL-391 specifications. This schwanced electronic control board now offers integrated functions to make all input and outputs of the gate operator easy to access in offers solid state motor control, spike suppressors, safely aleas and many other unique features. The new OmniCortiol*** board assures the fatest requirements and most advanced technology in the industry, keeping all Eite commercial operators in a class by themselves.

PLUG-IN LOOP DETECTORS

These high quality loop detectors are for use with the Eite Omni Board. The electronics are manufactured exclusively for Eitle by Rono A&E, a respected name in loop detection technology, Whith Eitle's proven design and integration technology, these component detectors will make installation and maintenance of loop detection systems simple. They are available for use with the SL-S000-UL^{oo} for Erd Loop and Safety Loop.

STANDARD LIGHTNING PROTECTION

Elite undertook the project of protecting the Elite commercial gate operators against lightning strike with a level of protection up to a 50 foot radius of near lightning strike. The result of this project is a tominal block that has been specifically designed to prevent durange to the Orniflosard caused by lightning strike. The ability to handle high power and the fast response capitality is accomplished by the use of a two-stage, hybrid network of surge suppressors integrated in the terminal block. This network of surge suppressors will protect a total of 11 lines for the gate operators (3 lines for the master/slave continualization, and 8 lines for the various input commands). The 110 volt power time protection on the Ornaliboard and the Plug-In Loop Detectors is built Into the Ornaliboard itself.



S THE SL-3000-UL

Dodge and specifications subject to change without notice.

THE SL-3000-UL™ SERIES SLIDE GATE OPERATORS

OPTIONAL ITEMS FOR THE SL-3000-UL™ SLIDE GATE OPERATO

POWER WHEELS

POWER WHEELS
The 4', 5' and 6' Power Wheels™ are manufactured by a computer controlled latte machine and made from solid, cotel rolled steet. They can be used on early gates and no wheels and no manufactured to the company participances. Power Wheels™ are 30%-more efficient in longue transfer from wheels are proportion than other wheels such a captured than other wheels such as captured than other wheels captured to make the gold zinc.





ALARM RESET BUTTON

The optional salety alarm reset button will instantly reset the built-in salety alarm stren on all new OmniControl operators, allowing normal function without waiting for the alarm status

THE DC-1000 POWER BACKUP

Don't be a prisoner of your own gate. Using the DC-1000U™ keeps traffic moving during

the DC-1000UTM keeps traffic moving during a power failure.
Set up A: In case of a power failure, the gale will open automatically. When the power is restored, the operator will return to normal condition.
Set up B: Cate will not open automatically and the power is restored to the power state of the power state.



GEARBOX HEATER

An optional gearbox heater is available to keep the gearbox running in it's optimum temperature range.



S THE SL-3000-UL



GATE MOTOR SPEC SHEET

AT&T PEMBROKE PINES SOC NEW GATE ProCon Engineering, Inc.

SUB-CONSULTANT STAMP

MEP Engineering Consultants

E-MAIL proconengineers@bell CA #9374 FreCon #: 24-04

NAME FERNAND ANZOATEUS
UE # 36632
PROME # 306-322-7630
400/655 7245 38, 386-78,
MAIA, FL 33155

CONSULTANT STAMP



1151 SE Cary Parkway, Suite 200 Cary, North Carolina 27518 P 919 851 8481 F 919 851 9703 www.engindereddies.co

REVISIONS / AUTHORIZATIONS

MI	REVISIONS / AUTHORIZATIONS	DATE	BY
1	REV#1-BLDG DEPT. COMMENTS	03/08/24	AP/18
_			H
H			
\vdash			

PROPRIETARY AT&T INFORMATION

NOT FOR GENERAL USE OR DISCLOSURE DUTSIDE OF AT&T
THIS INFORMATION MAY DRY SE USED BY AUTHORIZED
PERSONNEL OF THE LOCAL GOVERNMENT ASSEMY IN CONNECTION
VITH APPLICATION FOR PERMITS AND AUTHORIZATIONS FOR
SUILDINGS, CONSTRUCTION, AND/ OR ZONING CHANGES.



CORPORATE REAL ESTATE

E9604


13900 PINES BLVD PEMBROKE PINES

FL HLWDFL09

143829.01

ELECTRICAL DETAILS II

ATET PROJECT MUNEER	DATEQUEST A.P.		SCALE: N.T.S.		
			CHECKED BY: F.A.		
ATET AUTHORIZATION	DICCO 4 DE	5	SHEETS	SHEET NO.	
LISSET MOREJON	ATET BRAVING NO) C	14	E04	

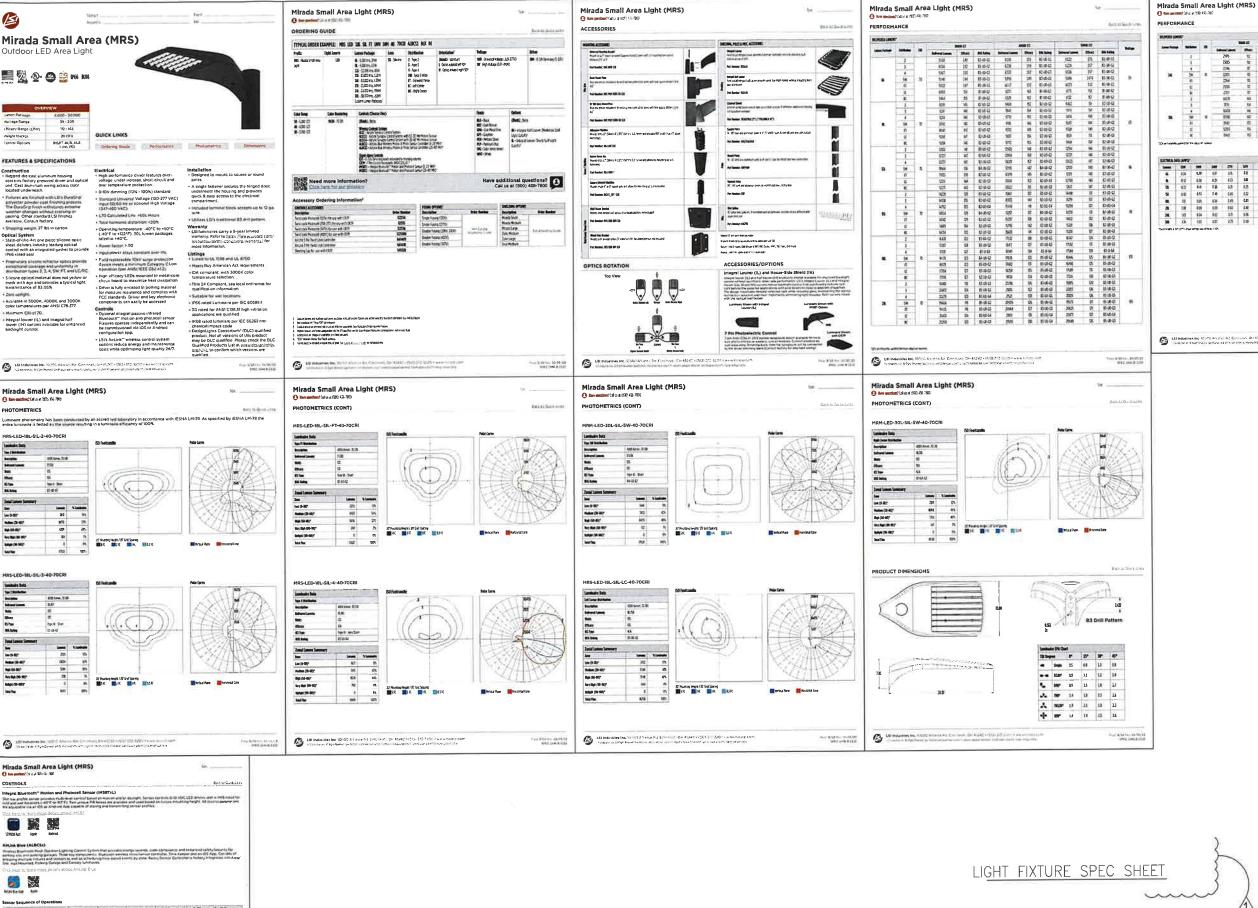

100

On Light Load Dist Light Load Dalla to Dan 



REVISIONS / AUTHORIZATIONS

NCL	REVISIONS / AUTHORIZATIONS	DATE	
1	REV#1-BLDG DEPT. COMMENTS	03/08/24	s;
H			
\vdash			
⊢		_	
\vdash	BRODRIFTARY ATAT INFORMA	TION	۰

PROPRIETARY AT&T INFORMATION

NOT FOR GENERAL USE OR DISCUSSURE DUTSIBE OF AT&T
THIS INFORMATION MAY DNLY BE USED BY AUTHORIZED
PERSONNEL OF THE LOCAL GOVERNENT AGENCY IN CONNECTION
WITH APPLICATION FOR PERHITS AND AUTHORIZATIONS FOR
BUILDINGS, CONSTRUCTION, AND/ OR ZONING CHANGES.



CORPORATE

E9604

REAL ESTATE
PROJECT DRAWING

13900 PINES BLVD

PEMBROKE PINES FL US HLWDFL09 143829.01

ELECTRICAL DETAILS III

DATEO//30/2024 SCALD N.T.S.

DRAWN BY A.P. CHECKED BY F.A.

THE AUTHORIZATION SHEET 5 DF 5 SHEETS SHEET NO.

ATEN DRAWNING NO.

LISSET MOREJON E 5 0 5 E 0 5

AT&T PEMBROKE PINES SOC NEW GATE