MedSquare Pembroke Pines

ZONING - INDEX OF DRAWINGS

| COVER SHEET | A000 |
|------------------------------|------------------|
| SITE CONTEXT | A001 |
| SITE DIAGRAMS | A002 |
| GRASS SITE PARKING DIAGRAM I | LAYOUT PLAN A002 |
| BUILDING AREAS | A003 |
| BUILDING AREAS | A003 |
| SITE PLAN & SITE DATA | A100 |
| FIRE TRUCK ACCESS PLAN | A100 |
| GROUND LEVEL | AlOI |
| LEVELS 2 & 3 | A102 |
| ROOF PLAN | A103 |
| ELEVATIONS | A201 |
| ELEVATIONS | A202 |
| ELEVATIONS | A203 |
| ELEVATIONS | A204 |
| SECTIONS | A301 |
| SITE PHOTOMETRICS | A501 |
| SITE EM PHOTOMETRICS | A501 |
| RENDERING | A901 |
| RENDERING | A902 |
| | |



City of Pembroke Pines Received

SEP 3 0 2024

Planning & Economic Development






4955 SW 75th Avenue Miami, Florida 33155 T. 786.879.8882 F. 786.350.1515

Pembroke Pines, Florida


Site Plan Resubmittal

#21236

06/14/2024

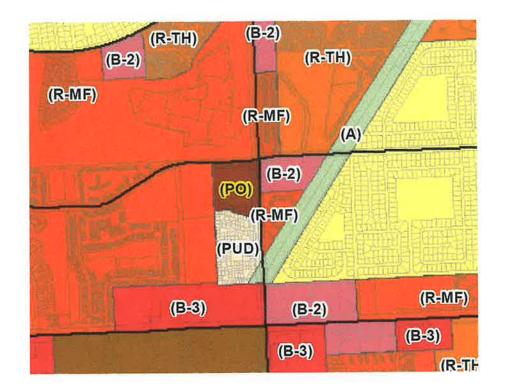

Zoning Map

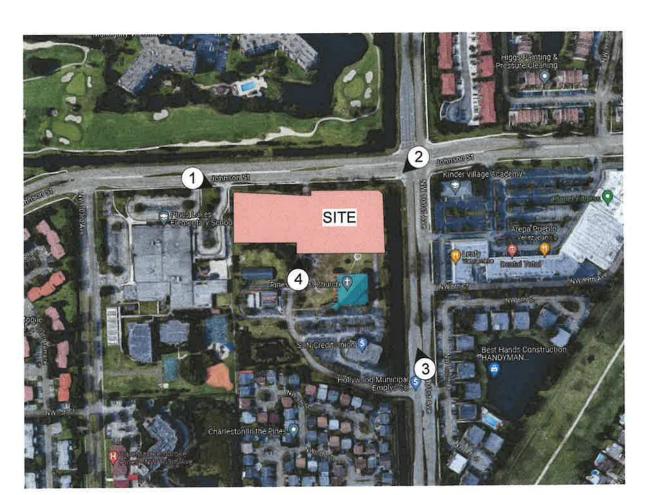



Land Use Map









drawing data:

project info :

Pembroke Pines

MedSquare

MAS AJP new construction Pembroke Pines, Florida

Digitally signed by Robert K Morisette Date: 2024,09.19 13:33:03-04'00'

ROBERT K. MORISETTE, AIA, NCARB, LEED AP BD+C, C FLORIDA REGISTERED ARCHITECT # AR 93259

Site Context

#2123


06/14/202

12" = 1'-0

Site Plan Resubmittal


sheet number : A001

Aerial
SCALE 12' = 1-0'

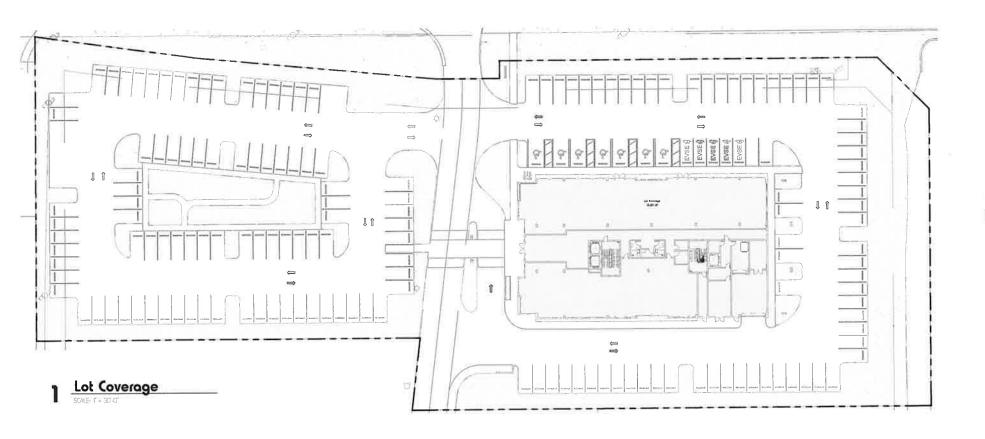

Legend

Lot Coverage

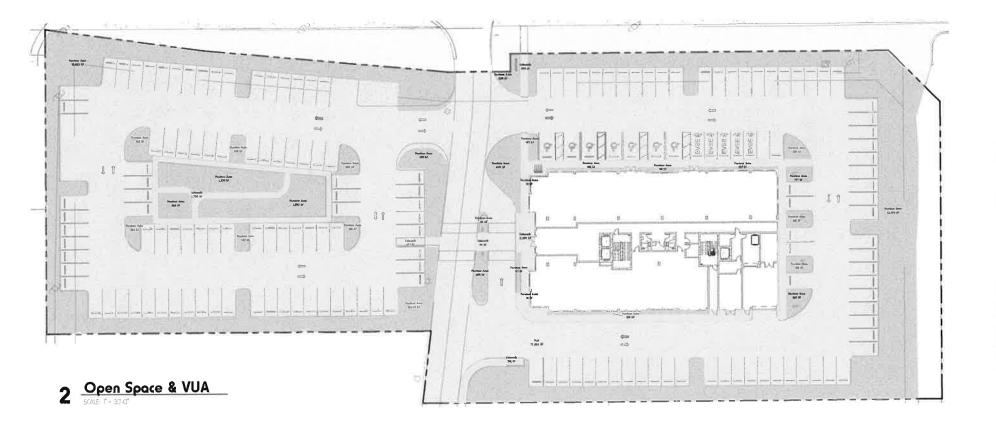

<u>Lengend</u>

Pervious Area
Sidewalk
VUA

| NET AREA | 13 | 0,909.00 SF | 3.01 AC | |
|---------------|-----|-------------|---------|-----------|
| LOT COVERAGE | 30% | 57,841 SF | 12% | 16,011 SF |
| OPEN SPACE | 10% | 13.091 SF | 30% | 39,573 SF |
| VUA | | N/A | 55% | 72,052 SF |
| PERVIOUS AREA | | N/A | 26% | 33.718 SF |



project info :

Pembroke Pines MAS AJP NEW CONSTRUCTION Pembroke Pines, Florida **MedSquare**

seal:

Digitally signed by Robert K Morisette Date: 2024.09.19 13:33:03-04'00'

ROBERT K. MORISETTE, AIA, NCARB, LEED AP BD+C, C FLORIDA REGISTERED ARCHITECT # AR 93259

| revisions : | | | | |
|-------------|-----------------------|----------|--|--|
| H.V | Description | Date | | |
| | Rezoning Submittal | 06/30/20 | | |
| | Site Plan Review | 11/01/20 | | |
| | Site Plan Resubmittal | 03/15/20 | | |

drawing data:

Site Diagrams

#2123 1" = 30'-0

06/14/202

Site Plan Resubmittal





MAS AJP NEW CONSTRUCTION Pembroke Pines, Florida Pembroke Pines MedSquare

Digitally signed by Robert K Morisette Date: 2024,09.19 13:33:03-04'00'

ROBERT K. MORISETTE, AIA, NCARB, LEED AP BD+C, C

| revisions : | | | | |
|-------------|-----------------------|---------|--|--|
| Rev. # | Description | Date | | |
| | Rezoning Submittal | 06/30/2 | | |
| | Site Plan Review | 11/01/2 | | |
| | Site Plan Resubmittal | 03/15/2 | | |

drawing data:

Grass Site Parking Diagram Layout Plan


06/14/202


Site Plan Resubmittal


sheet number:

A002A



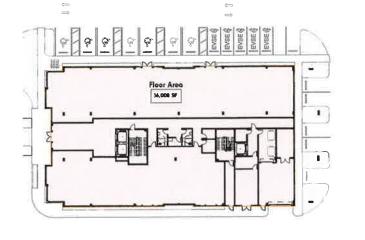

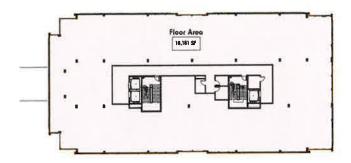

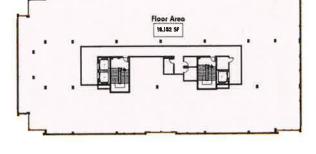

2 Level 2

SCALE | = 30-0

3 Level 3

| Level | Name | Area |
|-------|------|------|

| Level 1 | Floor Area | 16008 SF |
|---------|------------|----------|
| Level 2 | Floor Area | 18151 SF |
| Level 3 | Floor Area | 18152 SF |
| Level 3 | Floor Area | 52311 |

| Level | Name | Area |
|-------|------|------|

 Level 1
 Usable
 9776 SF

 Level 2
 Usable
 14522 SF


 Level 3
 Usable
 14522 SF

 Grand total: 4
 38819 SF


Usable 5,936 SF



1 Level 1 SCALE 1' = 30-0'

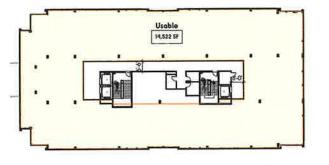

5 Level 2

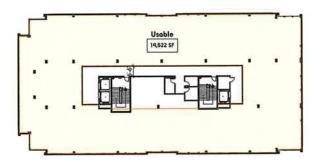

6 Level 3

SCALE I' = 30-0



project info :

MedSquare
Pembroke Pines
MAS AJP
NEW CONSTRUCTION
Pembroke Pines, Florida

seal:

Digitally signed by Robert K Robert K Morisette Date: 2024,09.19 13:33:04-04'00'

ROBERT K. MORISETTE, AIA, NCARB, LEED AP BD+C, C FLORIDA REGISTERED ARCHITECT # AR 93259

drawing data:

Building Areas

project number :

#2123

drouding coolors


1" = 30'-0

drawing date : 06/14/202

nase :

Site Plan Resubmittal

e i idii iteedii

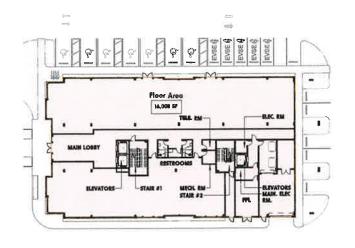

Floor Area

10,151 50

TELE EM

BESTROOMS

BESTROOMS

STAIR 62

ELEVATORS

Floor Area

18,152 SF

BLEVATORS

STAIR #1

MECH. RM

BLEVATORS

STAIR #2

BLEVATORS

Level 1 - Gross Area

2 Level 2 - Gross Area

3 Level 3 - Gross Area

| Level | Name | Area |
|---------|------------|----------|
| Levei 1 | Floor Area | 16008 SF |
| Level 2 | Floor Area | 18151 SF |
| Level 3 | Floor Area | 18152 SF |
| | | 52311 95 |

Area Schedule (Gross Building)

Area Schedule (Rentable)

Level Name Area


Level 1 Rentable 12600 SF


 Level 1
 Rentable
 12600 SF


 Level 2
 Rentable
 16272 SF

 Level 3
 Rentable
 16427 SF

 Grand Total Rentable
 45298 SF

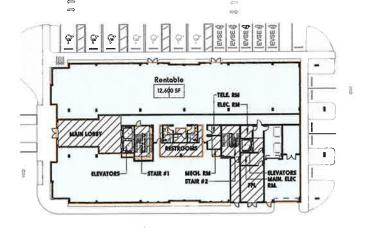

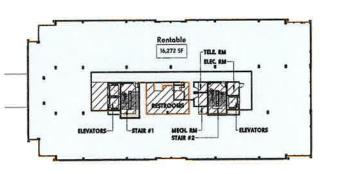

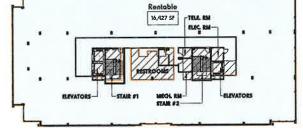

4 Level 1 - Rentable Area

SALE: 1' = 30-0'

5 Level 2 - Rentable Area

SCALE (1 = 30-0)

6 Level 3 - Rental Area

Ochitects
25th Avenue t. 786.879.8882

project info:

MedSquare
Pembroke Pines
MAS AJP
NEW CONSTRUCTION
Pembroke Pines, Florida

seal:

Digitally signed by Robert K Morisette Date: 2024.09,19

ROBERT K. MORISETTE, AIA, NCARB, LEED AP BD+C, C FLORIDA REGISTERED ARCHITECT # AR 93259

13:33:05-04'00'

drawing data:

Building Areas

project number : #2123

drawing scale:


1" = 30'-0 drawing date :


06/14/202 nase :

Site Plan Resubmittal

et number :

A003A

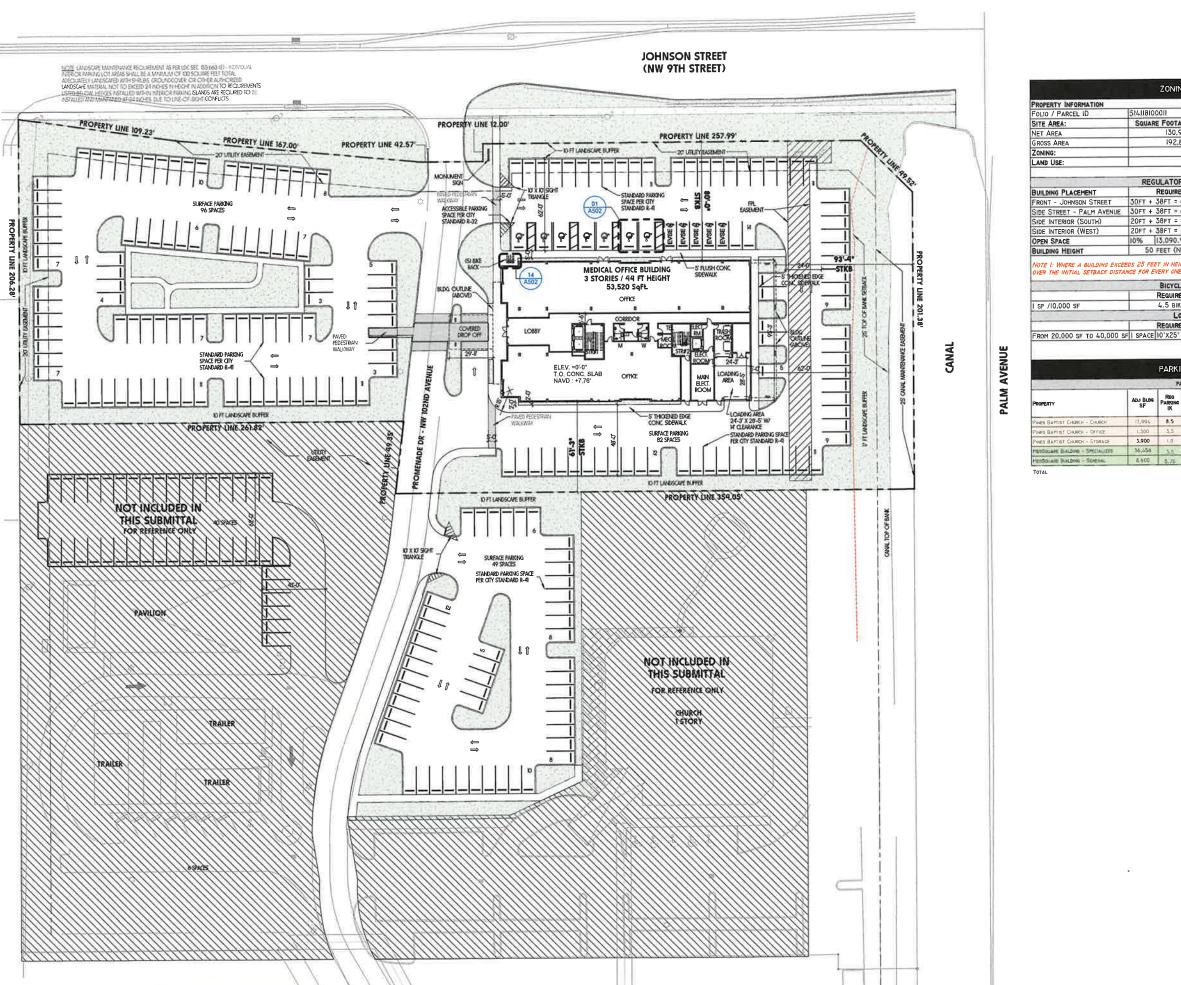

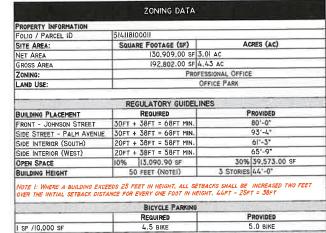

4.5 BIKE LOADING REQUIRED

| PARKING | | | | | | | |
|----------------------------------|----------------|----------------------|-----------------------------|------------------------------------|----------------------|--------------------------------|-------------------|
| PROPERTY | ADJ BLDG SF | REQ PARKING IK | TOTAL REQUIRED SPACES | PROVIDED VIA SURFACE PARKING | PROVIDED VIA LAWN | PROVIDED VIA NEW PARKING | TOTAL PROVIDED |
| PINES BAPTIST CHURCH - CHURCH | 17,994 | 8.5 | 153 | 82 | 48 | 49 | 179 |
| PINES BAPTIST CHURCH - OFFICE | 1,300 | 3,5 | 5 | 0 | 0 | 0 | 0 |
| PINES BAPTIST CHURCH - STORAGE | 2,900 | 1.0 | 4 | 0 | . 6 | 0 | 0_ |
| PERSONANE BUILDING - SPECIALIZED | 36,456 | 3,5 | 128 | (24) | 18 | -21 | 128 |
| PERSONAIR BUILDING - GENERAL | 8.600 | 5.75 | 5.0 | 50 | 0 | .0 | 50 |
| TOTAL | | | 340 | 260 | 4.6 | 40 | 357 |

PROVIDED

1 SPACE 10'X25

rchitects t. 786.879.8882 f. 786.350.1515 0

S

project info:

MAS AJP NEW CONSTRUCTION Pembroke Pines, Florida **Pembroke Pines MedSquare**

Digitally signed by Robert K Morisette Date: 2024.09.19 13:33:05-04'00'

ROBERT K. MORISETTE, AIA, NCARB, LEED AP BD+C, C FLORIDA REGISTERED ARCHITECT # AR 93259

drawing data:

Site Plan & Site Data


project number:

#2123

1" = 30'-0

06/14/202

Site Plan Resubmittal

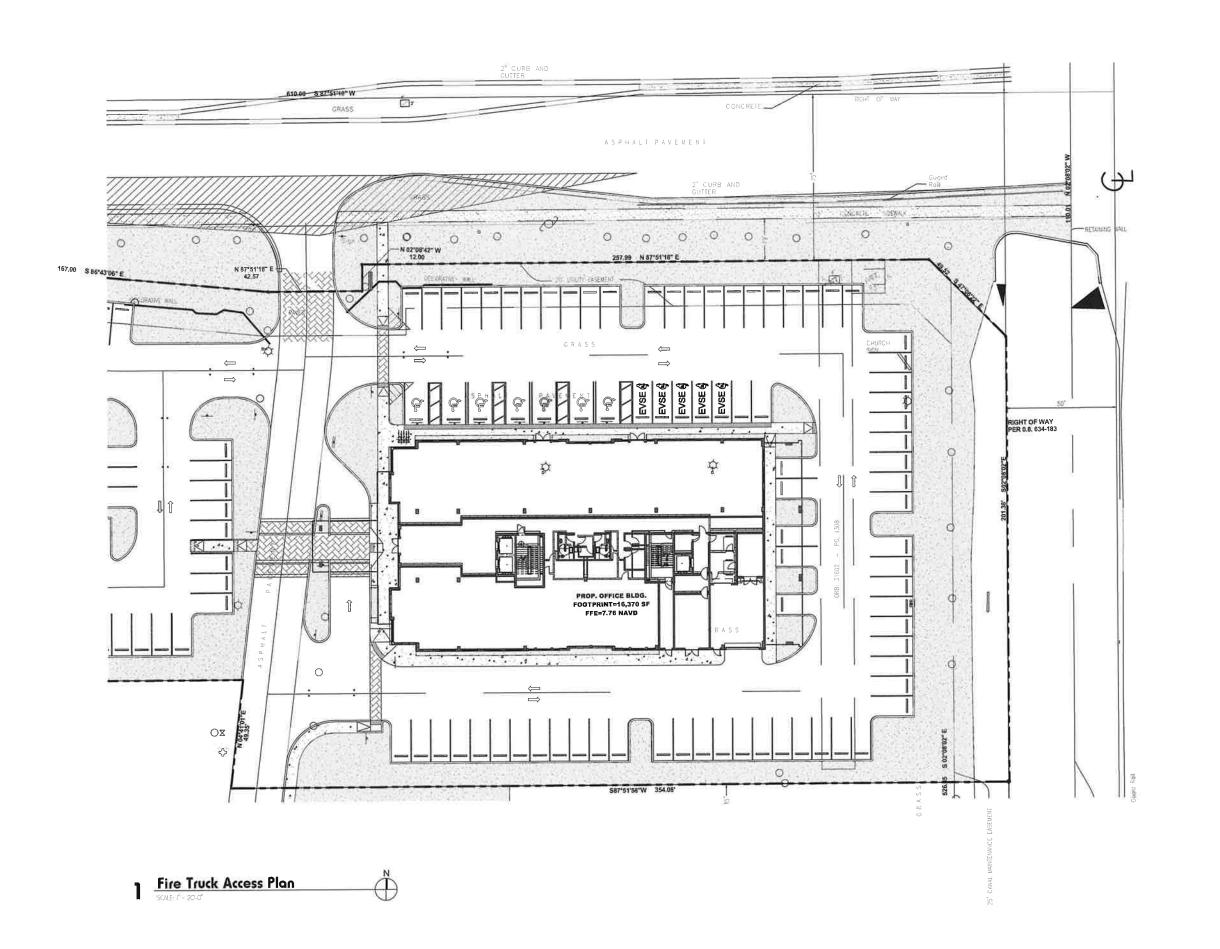



MedSquare
Pembroke Pines
MAS AJP
NEW CONSTRUCTION
Pembroke Pines, Florida

seal:

Digitally signed by Robert K Morisette Date: 2024.09.19 13:33:06-04'00'

NOBERT K. MORISETTE, AIA, NCARB, LEED AP BD+C, C FLORIDA REGISTERED ARCHITECT # AR 93259

| v. # | Description | Date |
|-----------------|-----------------------|----------|
| | Rezoning Submittal | 06/30/20 |
| | Site Plan Review | 11/01/20 |
| $\neg \uparrow$ | Site Plan Resubmittal | 03/15/20 |

drawing data:

Fire Truck
Access Plan

project number :

drawing scale:

1" = 20'-0

drawing date:


06/14/202

Site Plan Resubmittal

#2123

sheet number:

A100A

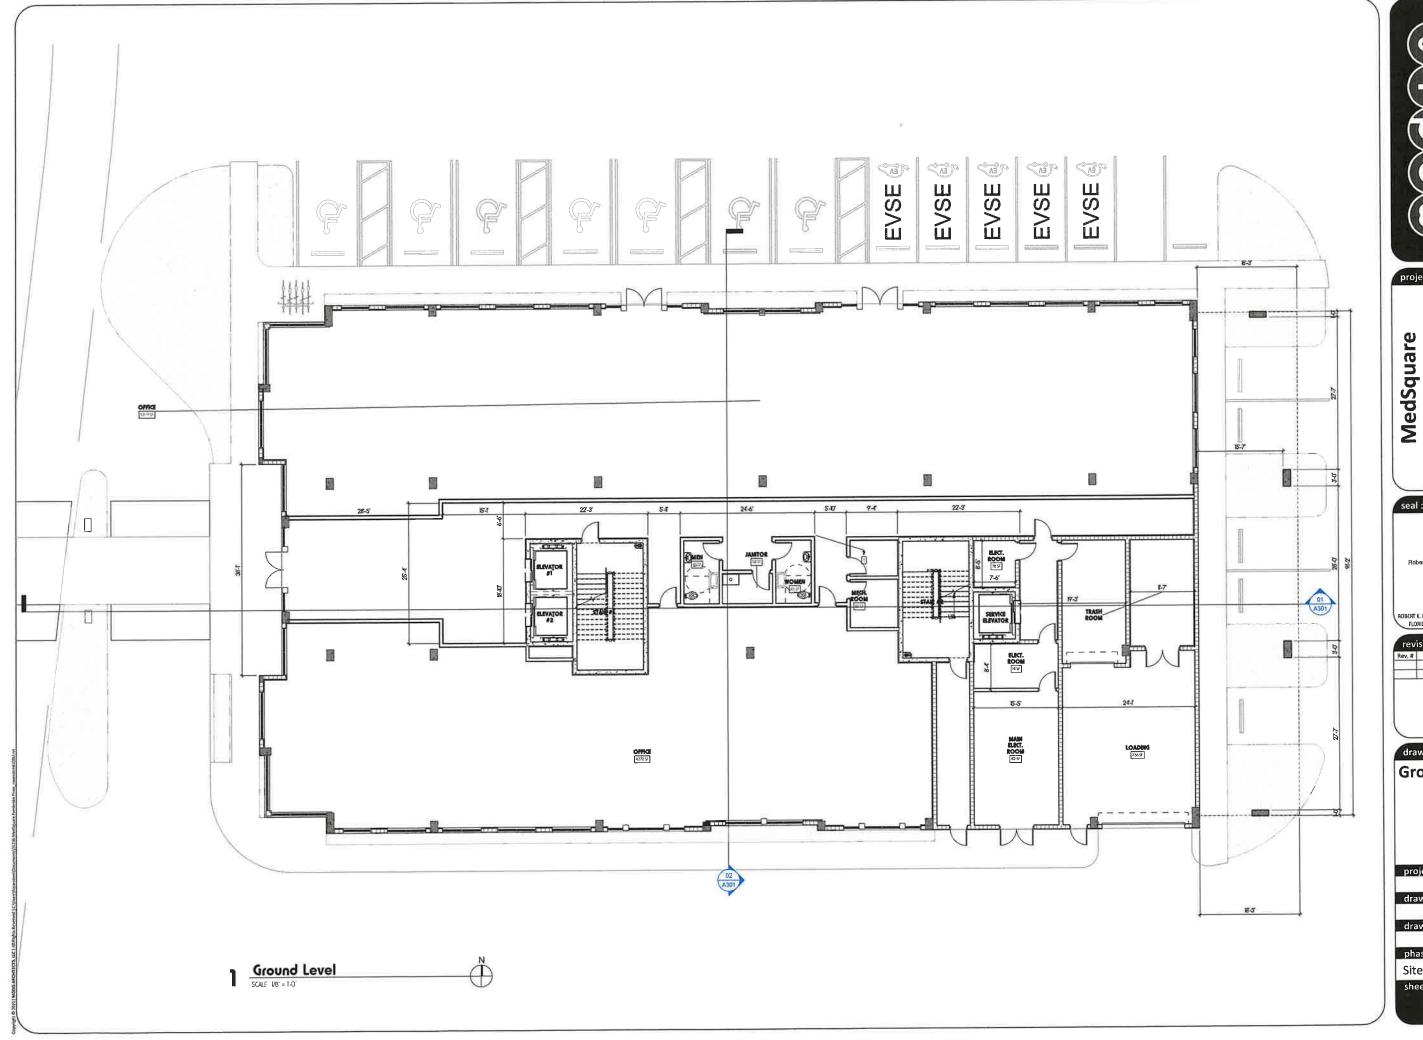

MAS AJP NEW CONSTRUCTION Pembroke Pines, Florida Pembroke Pines

seal:

Digitally signed by Robert K Morisette Date: 2024.09.19 13:33:06-04'00'

ROBERT K. MORISETTE, AIA, NCARB, LEED AP BD+C, C FLORIDA REGISTERED ARCHITECT # AR 93259

Description
Site Plan Review
Site Plan Resubmittal

drawing data:

Ground Level


#2123

1/8" = 1'-0

06/14/202

Site Plan Resubmittal

sheet number: A101

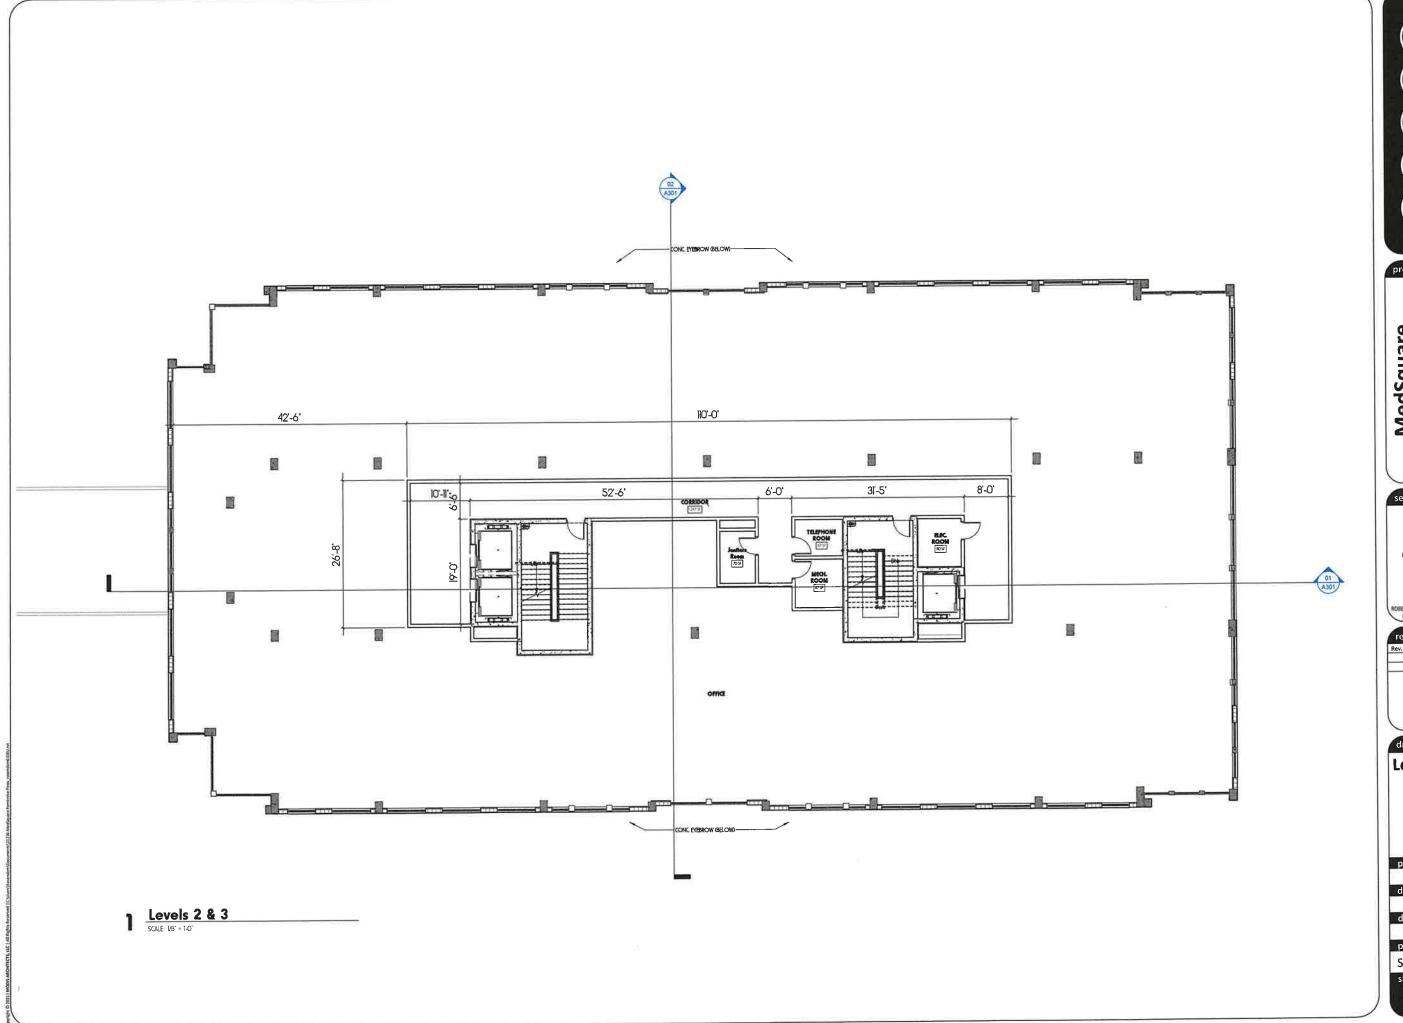



MedSquare Pembroke Pines MAS AJP NEW CONSTRUCTION Pembroke Pines, Florida

Digitally signed by Robert K Robert K Morisette Date: 2024,09.19 13:32:55-04'00'

ROBERT K. MORISETTE, AIA, NCARB, LEED AP BD+C, C FLORIDA REGISTERED ARCHITECT # AR 93259

| visions : | | | | |
|-----------|-----------------------|----------|--|--|
| # | Description | Date | | |
| \exists | Site Plan Review | 11/01/20 | | |
| ╛ | Site Plan Resubmittal | 03/15/20 | | |

drawing data:


Levels 2 & 3

#2123

1/8" = 1'-0

06/14/202

Site Plan Resubmittal

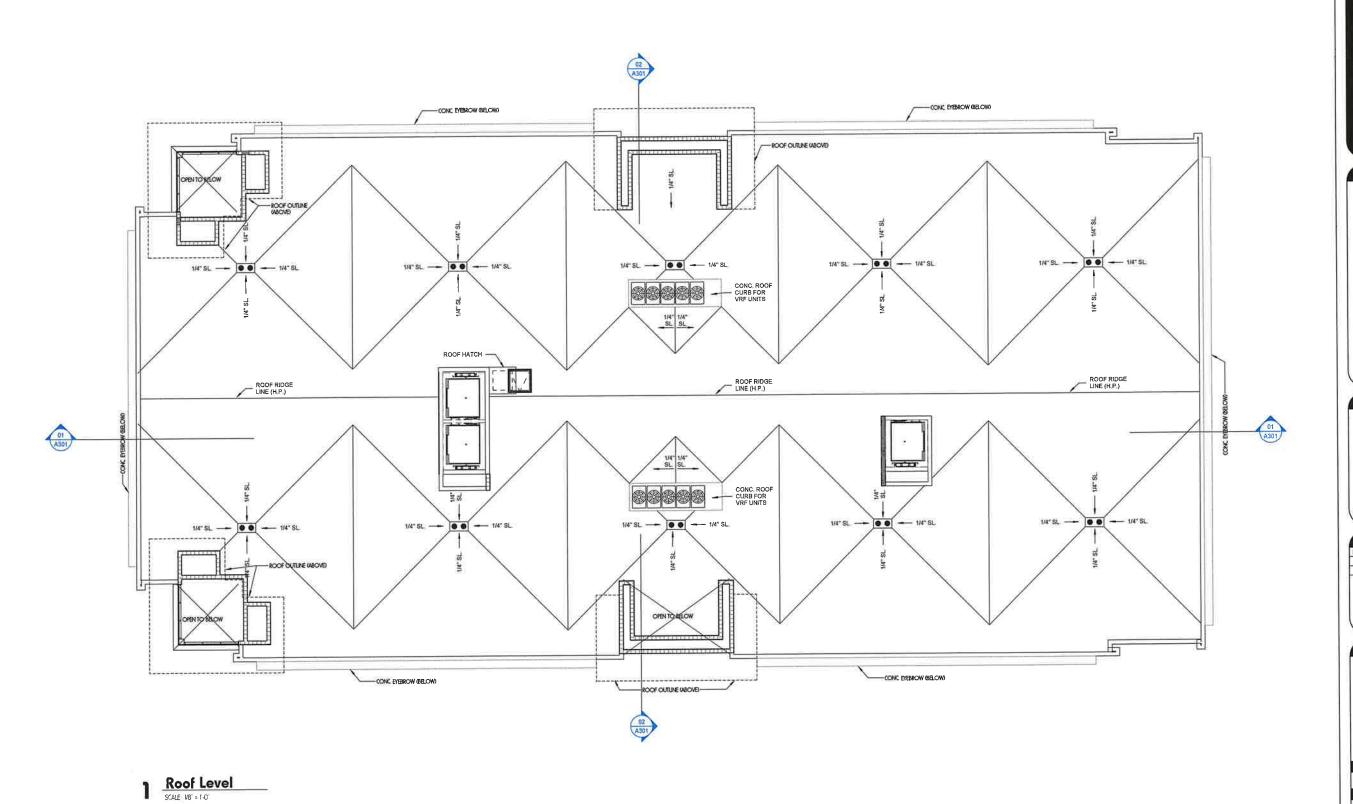

OCChilects Sth Avenue t. 786.879.

project info:

MedSquare
Pembroke Pines
MAS AJP
NEW CONSTRUCTION
Pembroke Pines, Florida

seal :

Digitally signed by Robert K Hobert K Morisette Date: 2024.09,19 13:32:56-04'00'

ROBERT K. MORISETTE, AIA, NCARB, LEED AP BD+C, C FLORIDA REGISTERED ARCHITECT H AR 93259

evisions :

p. # Description Date
Site Plan Review 11/01/2
Site Plan Resubmittal 03/15/2

drawing data:

Roof Plan

project number : #2123

drawing scale :

1/8" = 1'-0


drawing date:

06/14/202

ise :

Site Plan Resubmittal

eet number :

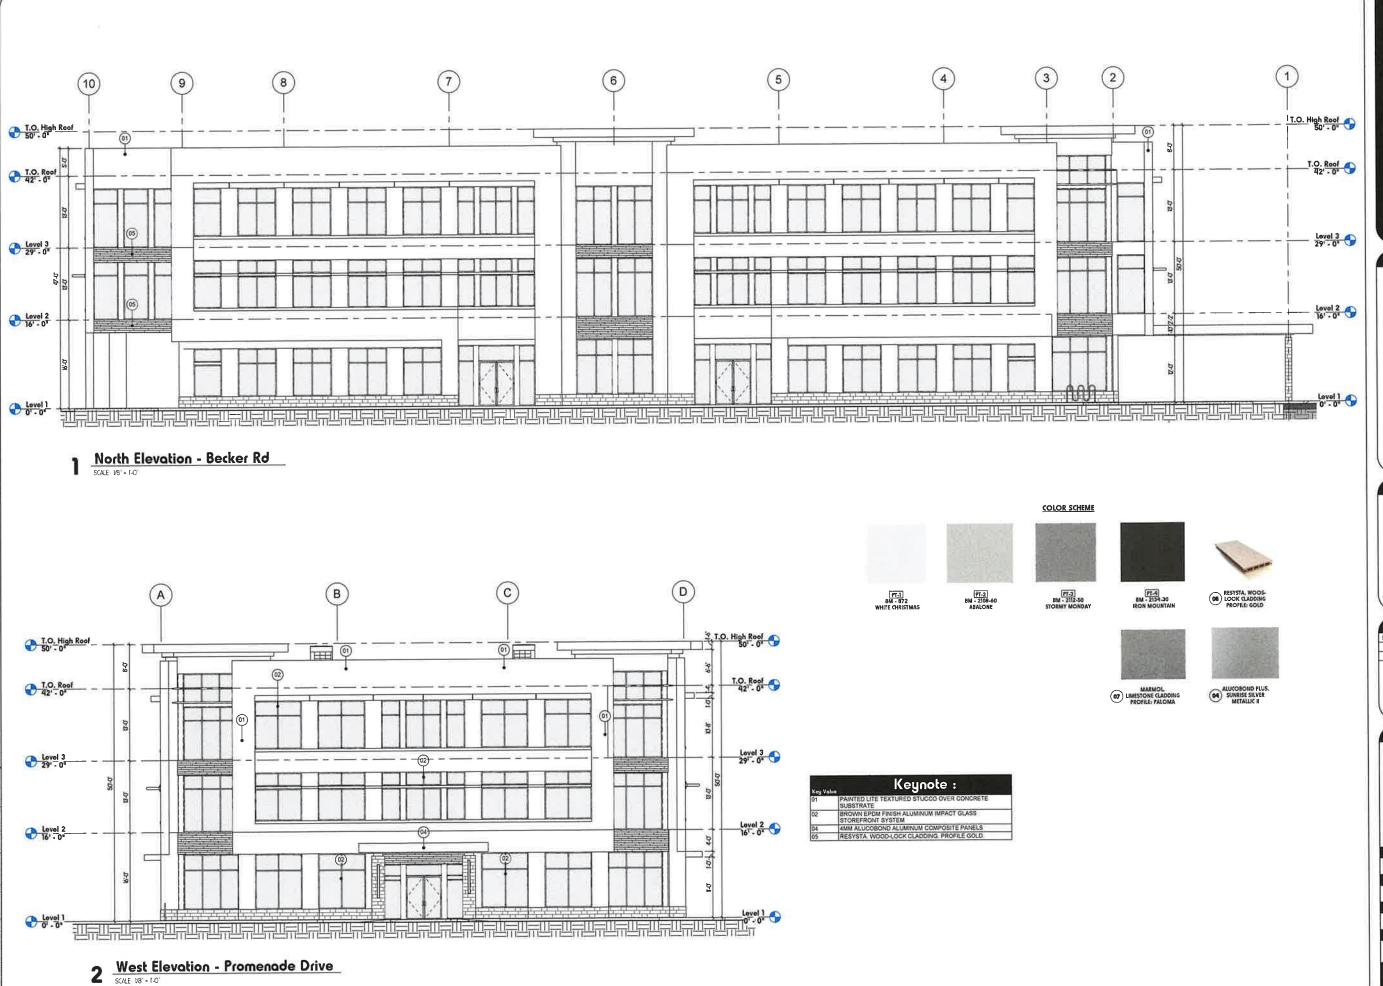

Orchitects th Avenue t. 786.879.88 da 33155 f. 786.350.15

project info:

MedSquare
Pembroke Pines
MAS AJP
NEW CONSTRUCTION
Pembroke Pines, Florida

coale

Digitally signed by Robert K Morisette Date: 2024.09,19 13:32:56-04'00'

ROBERT K, MORISETTE, AIA, NCARB, LEED AP BD+C, C

RIDA REGISTERED ARCHITECT # AR 93259

VISIONS

Description Date
Site Plan Review 11/01/20
Site Plan Resubmittal 03/15/20

drawing data:

Elevations

roject number

#2123

drawing scale:

As indicate

drawing date:

06/14/202

ase:

Site Plan Resubmittal

sheet number:



○ rchit⊖cts 4955 SW 75th Avenue t. 786.879.8882 Miami, Florida 33155 f. 786.350.1515 MODIS Architects, LLC S

project info :

 \mathbf{E}

MAS AJP NEW CONSTRUCTION Pembroke Pines, Florida Pembroke Pines MedSquare

Digitally signed by Robert K Morisette Date: 2024.09.19 13:32:57-04'00'

ROBERT K. MORISETTE, AIA, NCARB, LEED AP BD+C, C

FLORIDA REGISTERED ARCHITECT # AR 93259 Rev. # Description Date
Site Plan Review 11/01/20

drawing data:

Elevations

project number: #2123

As indicate

06/14/202

Site Plan Resubmittal

sheet number



MAS AJP NEW CONSTRUCTION Pembroke Pines, Florida Pembroke Pines

seal:

Digitally signed by Robert K Morisette Robert K Morisette Date: 2024,09,19 13;32:57-04'00'

ROBERT K., MORISETTE, AIA, NCARB, LEED AP BD+C, C FLORIDA REGISTERED ARCHITECT # AR 93259

Elevations

#2123

As indicate

06/14/202

Site Plan Resubmitta sheet number:



orchit⊖cts t. 786.879.8882 f. 786.350.1515 ြဟ

project info :

MAS AJP new construction Pembroke Pines, Florida Pembroke Pines MedSquare

seal:

Digitally signed by Robert K Morisette Robert K Morisette Date: 2024.09.19 13:32:58-04'00'

ROBERT K. MORISETTE, AIA, NCARB, LEED AP BD+C, C FLORIDA REGISTERED ARCHITECT # AR 93259

Description Site Plan Review 11/01/20 Site Plan Resubmittal 03/15/20


drawing data:

Elevations


#2123 As indicate

06/14/202


Site Plan Resubmittal

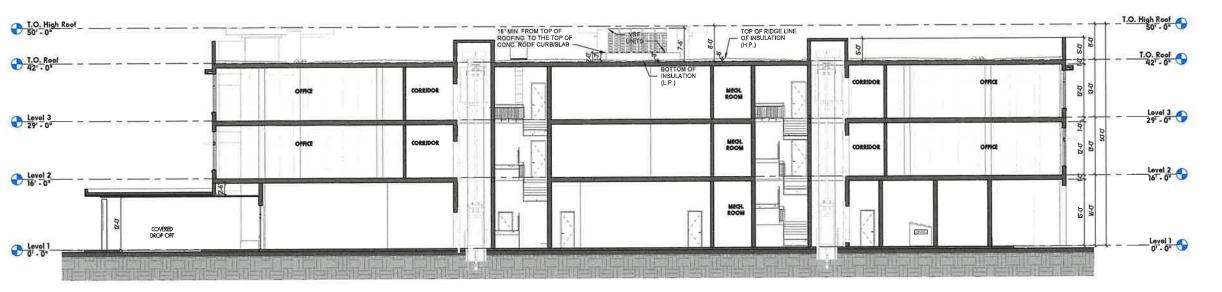

Ol Section A

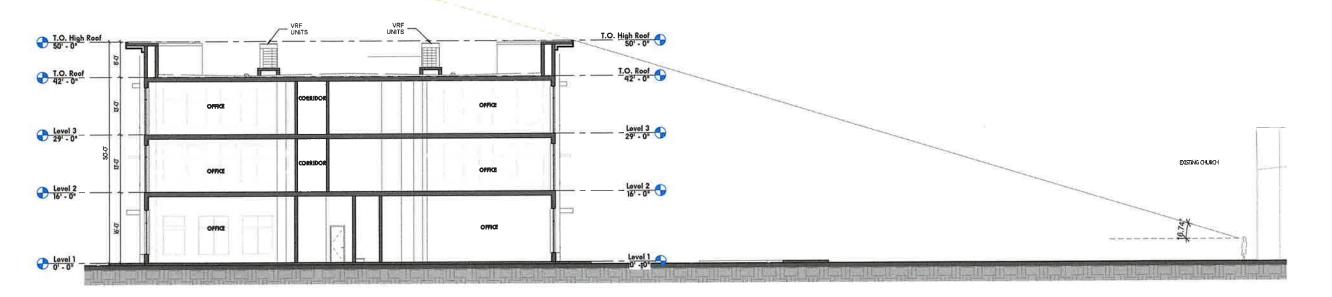

Section BSCALE |1 = |0-0"

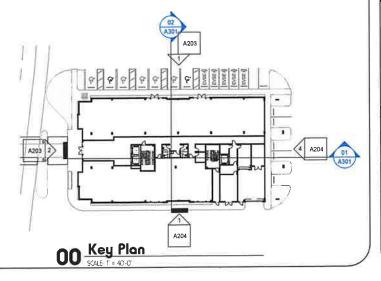

Orchitects 5th Avenue t. 786.879.8882 prida 33155 f. 786.350.1515

project info :

E

MedSquare
Pembroke Pines
MAS AJP
NEW CONSTRUCTION
Pembroke Pines, Florida

seal :

Digitally signed by Robert K Robert K Morisette Date: 2024,09.19 13:32:58-04'00'

ROBERT K. MORISETTE, AIA, NCARB, LEED AP BD+C, C FLORIDA REGISTERED ARCHITECT # AR 93259

drawing data:

Sections

project number : #2123

1-9

As indicate


drawing date :

06/14/202

iase:

Site Plan Resubmittal

eet number:

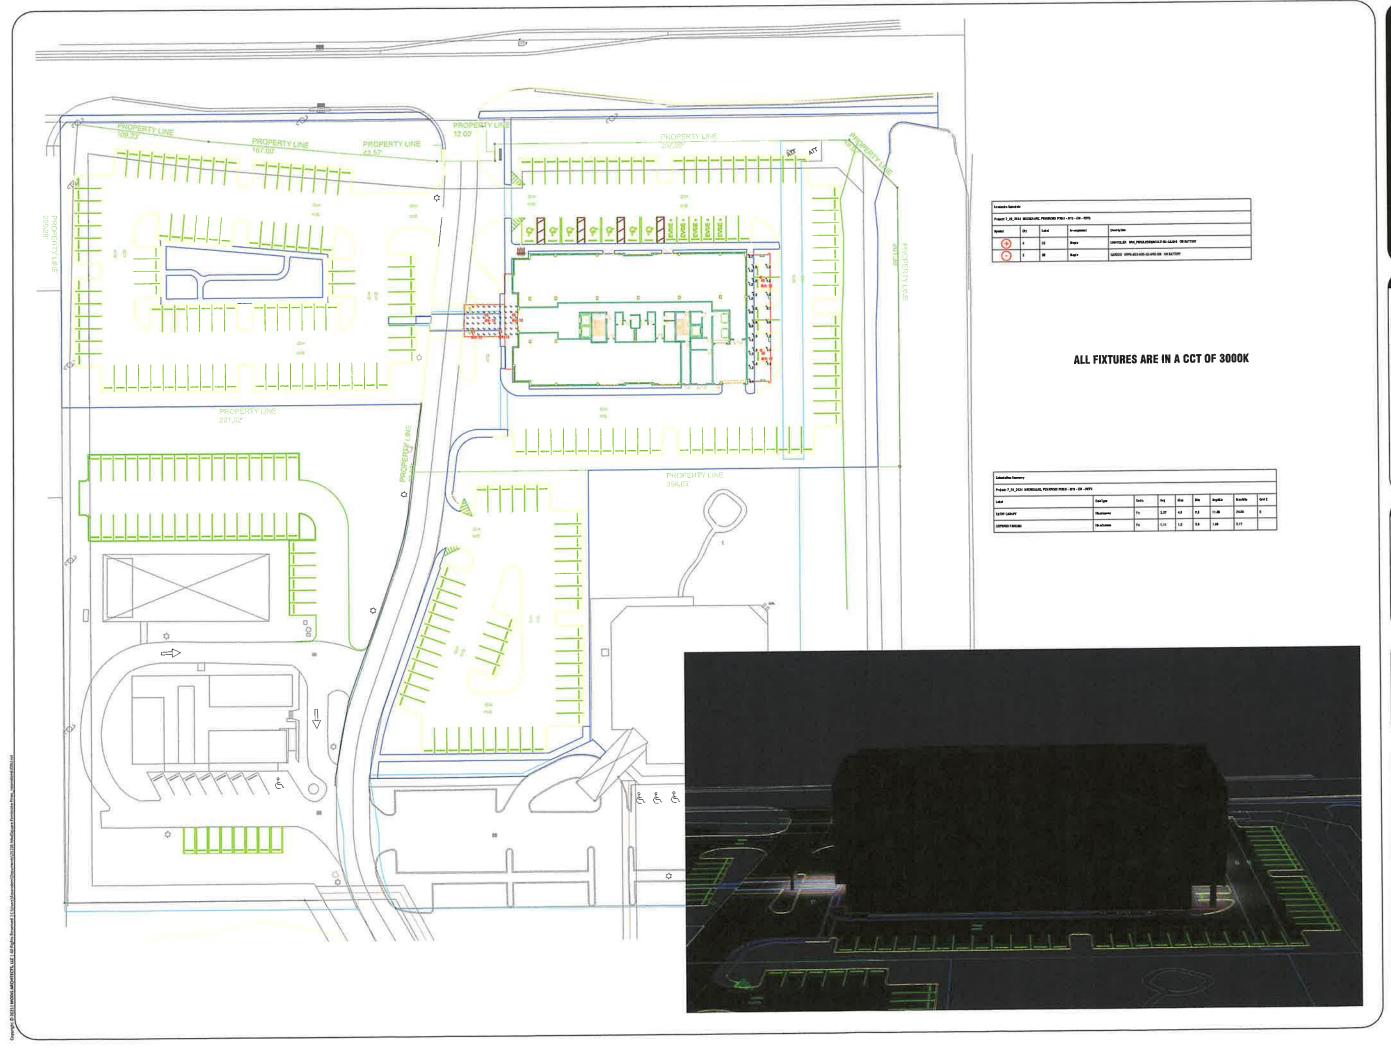



MAS AJP NEW CONSTRUCTION Pembroke Pines, Florida **Pembroke Pines** MedSquare

seal:

Digitally signed by Robert K Morisette Date: 2024.09.19 13:32:59-04'00'

| revi | sions : | |
|------|-----------------------|----------|
| W. # | Description | Date |
| | Site Plan Review | 11/01/20 |
| | Site Plan Resubmittal | 03/15/20 |

drawing data:

Site EM Photometrics


#2123

1/32" = 1'-0

06/14/202

Site Plan Resubmittal

A501.1

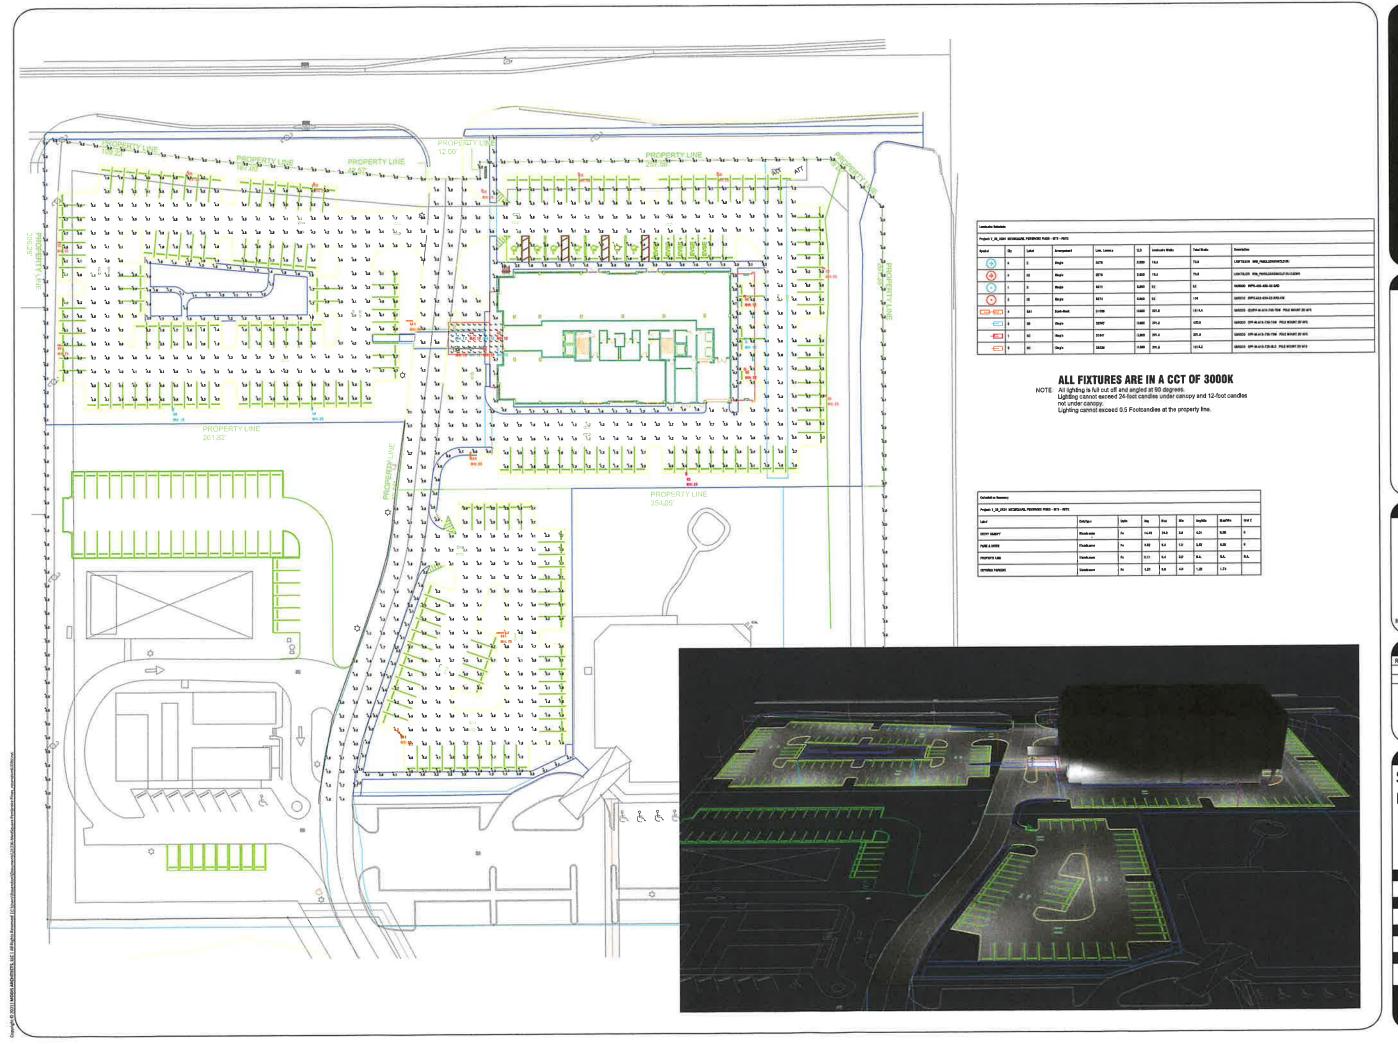



MedSquare
Pembroke Pines
MAS AJP
NEW CONSTRUCTION
Pembroke Pines, Florida

seal :

Digitally signed by Robert K Morisette Date: 2024.09.19 13:32:59-04'00'

ROBERT K. MORISETTE, AM, NCARII, LEED AP BD+C, C FLORUDA REGISTERED ARCHITECT # AR 93259

| revisions: | | |
|------------|-----------------------|----------|
| v.# | Description | Date |
| | Site Plan Review | 11/01/20 |
| \neg | Site Plan Resubmittal | 03/15/20 |

drawing data:

Site Photometrics


ject number : #2123

drawing scale:

1/32" = 1'-0 awing date :

06/14/202

Site Plan Resubmittal

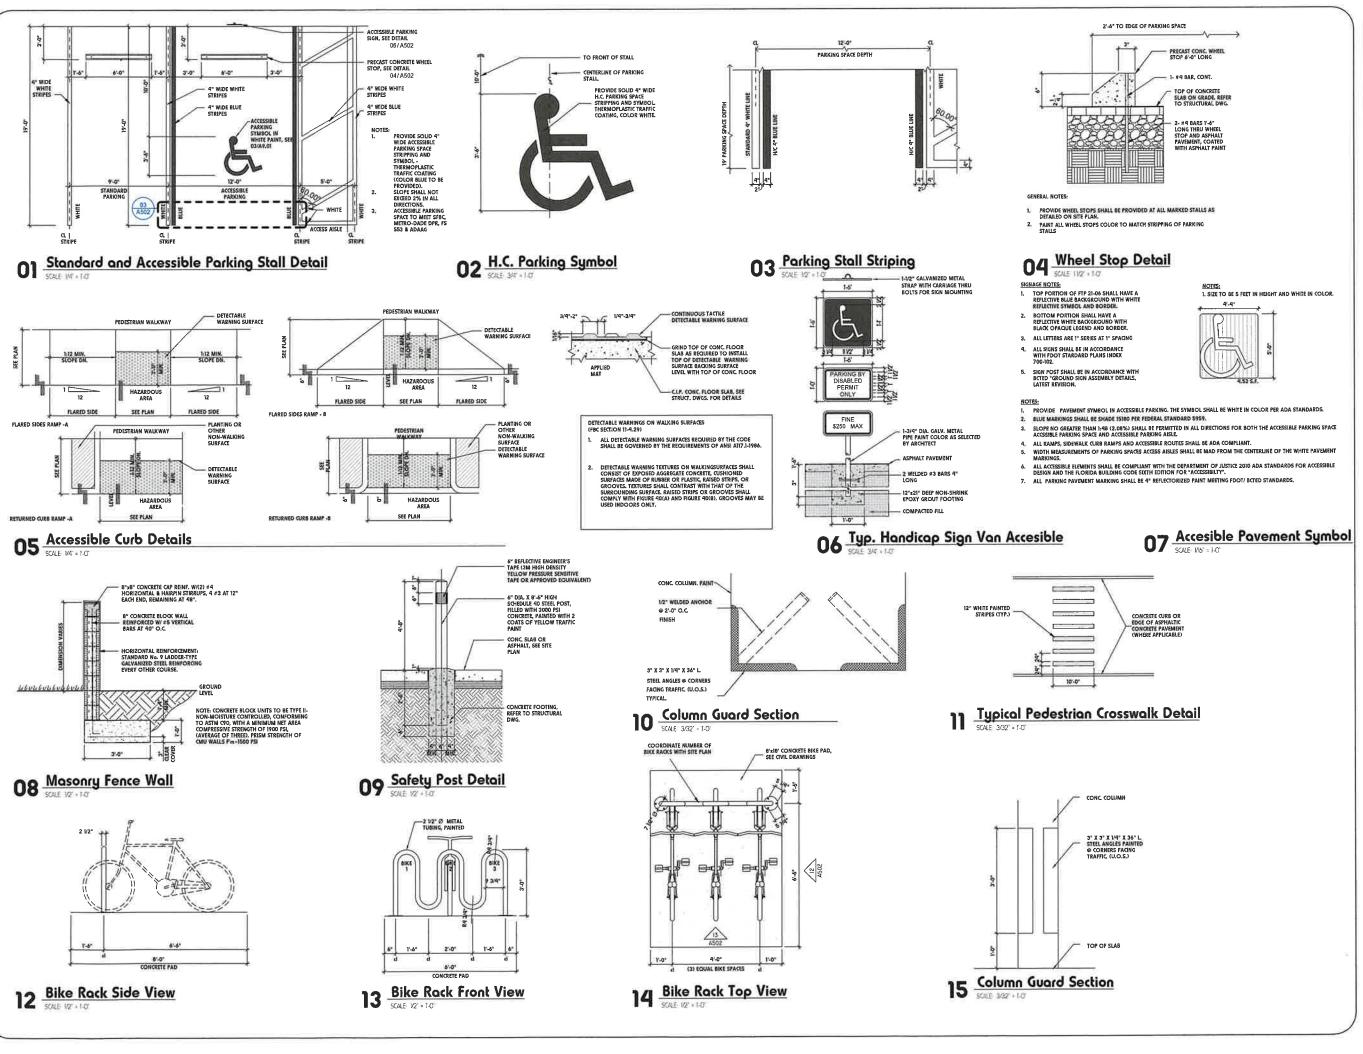

Orchitects 55th Avenue t. 786.879.88 orida 33155 f. 786.350.15

project info :

0

MedSquare
Pembroke Pines
MAS AJP
NEW CONSTRUCTION
Pembroke Pines, Florida

coal

Digitally signed by Robert K Morisette Date: 2024.09.19 13:33:00-04'00'

ROBERT K. MORISETTE, AIA, NCARB, LEED AP BD+C, CO FLORIDA REGISTERED ARCHITECT: # AR 93259

> Sions : Description Date

Site Plan Resubmittal 03/15/20

drawing data:
Site Details

roject number : #2123

As indicated

awing date :

ise t

seas


Site Plan Resubmittal

06/14/202

reet number :



Rendering - Main Entry SCALE 12' = 1-0'

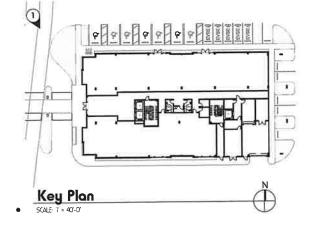



project info :

MedSquare
Pembroke Pines
MAS AJP
NEW CONSTRUCTION
Pembroke Pines, Florida

coal

Digitally signed by Robert K Morisette Cate: 2024.09.19 13:33:01-04'00'

ERT K. MORISETTE, AIA, NCARB, LEED AP BD+C,

DRIDA REGISTERED ARCHITECT # AR 93259

Rev. # Description Date Site Plan Review 11/01
Site Plan Resubmittal 03/15

drawing data :

Rendering

roject number:

drawing scale:

rawing date

awing date :

nase :


Site Plan Resubmitta

et number :



Rendering - View From Johnson Street

SCAE 12" = 1-0"

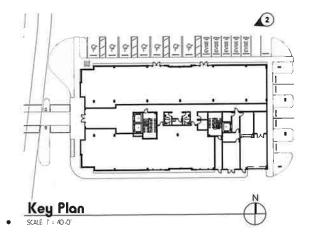



MAS AJP new construction Pembroke Pines, Florida **Pembroke Pines** MedSquare

Digitally signed by Robert K Robert K Morisette Date: 2024.09.19 13:33:01-04'00'

ROBERT K. MORISETTE, AIA, NCARB, LEED AP BD+C, CI FLORIDA REGISTERED ARCHITECT # AR 93259

| revi | sions : | | |
|-------|-----------------------|----------|--|
| Rev.# | Description | Date | |
| | Site Plan Review | 11/01/20 | |
| | Site Plan Resubmittal | 03/15/20 | |

drawing data:

Rendering

As indicate

06/14/202

Site Plan Resubmittal

MEDSQUARE PEMBROKE PINES



SEC OF JOHNSON STREET & NW 101ST AVENUE

CITY OF PEMBROKE PINES, FLORIDA

FOR

AJP VENTURES, CORP.

SHEET INDEX: SHEET NO. SHEET TITLE

| CS-1 | COVER SHEET |
|---------|--|
| DM-1 | DEMOLITION PLAN |
| SPM-1 | SIGNAGE AND PAVEMENT MARKINGS PLAN |
| SPM-2 | SIGNAGE AND PAVEMENT MARKINGS DETAILS |
| SPM-3 | BCTED DETAILS |
| PD-1 | PAVING AND DRAINAGE PLAN |
| PD-2 | PAVING AND DRAINAGE PLAN |
| PD-3 | PAVING AND DRAINAGE DETAILS |
| PD-4 | PAVING AND DRAINAGE DETAILS |
| PD-5 | CROSS-SECTIONS AND DETAILS |
| PD-6 | SBDD DETAILS |
| SWPPP-1 | STORMWATER POLLUTION PREVENTION PLAN |
| SWPPP-2 | STORMWATER POLLUTION PREVENTION PLAN DETAILS |
| SWPPP-3 | STORMWATER POLLUTION PREVENTION PLAN NOTES |
| WS-1 | WATER AND SEWER PLAN |
| WS-2 | WATER AND SEWER PLAN |
| WS-3 | WATER AND SEWER DETAILS |
| WS-4 | WATER AND SEWER DETAILS |
| WS-5 | WATER AND SEWER DETAILS |
| WS-6 | SEWER MAIIN PROFILES |
| FT-1 | FIRE CIRCULATION PLAN |
| FT-2 | FIRE PATH PLAN |
| FT-3 | FIRE ACCESS NOTES AND DETAILS |
| 100.0.4 | MARTE MANAGEMENT DI ANI |



LOCATION MAP SCALE: 1" = 300'

SECTION 18 / TOWNSHIP 51 / RANGE 41E

BROWARD COUNTY TAX FOLIO NUMBERS: 5141-18-10-0011 & 5141-18-10-0010

SITE DEVELOPMENT **PLANS**



HSQ GROUP, LLC.

Engineers · Planners · Surveyors 4577 N Nob Hill Road, Suite 205 Sunrise, Florida 33351 - 954.440.6990 C26258 - LB7924

ALL OF PARCEL "A" OF PROMENADE SQUARE", AS RECORDED IN PLAT BOOK 134, PAGE 30, OF THE PUBLIC RECORDS OF BROWARD COUNTY, FLORIDA, LESS THE FOLLOWING DESCRIBED PROPERTY:

BEGINNING AT THE SOUTHEAST CORNER OF SAID PARCEL "A", RUN ALONG THE SOUTHERLY LINE OF PARCEL A THE FOLLOWING TWO COURSES: (1) S 87°51'18" WEST 73.00 FEET; (2) N 70°08'42" WEST 105.79 FEET; THENCE NORTH 19°51'18" EAST 49.00 FEET: THENCE NORTH 70°08'42" WEST 125.92 FEET TO A POINT OF CURVATURE; THENCE NORTHWESTERLY ALONG THE ARC OF A CURVE TO THE RIGHT, HAVING A RADIUS OF 100.00 FEET AND A CENTRAL ANGLE OF 38°12'25", AN ARC DISTANCE OF 66.68 FEET TO A POINT OF TANGENCY; THENCE NORTH 31°56'17" WEST 102.49 FEET; THENCE NORTH 87°51'58" EAST 315.77 FEET; THENCE SOUTH 02°08'02" EAST 10.00 FEET; THENCE NORTH 87°51'58" EAST 54.01 FEET TO A POINT ON THE EAST LINE OF SAID PARCEL A; THENCE SOUTH 02°08'02" EAST ALONG SAID EAST LINE 254.14 FEET TO THE POINT OF BEGINNING.

TOGETHER WITH:

ALL EASEMENT RIGHTS UNDER THAT CERTAIN EASEMENT, CROSS PARKING, ACCESS AND MAINTENANCE AGREEMENT RECORDED IN OFFICIAL RECORDS BOOK 18258, PAGE 585 AND AS RE-RECORDED IN OFFICIAL RECORDS BOOK 18497, PAGE 55, PUBLIC RECORDS OF BROWARD COUNTY, FLORIDA.

ENGINEER'S CERTIFICATION THIS PLAN WAS PREPARED UNDER MY DIRECTION AND TO THE BEST OF MY KNOWLEDGE AND BELIEF COMPLIES WITH THE INTENT OF THE MANUAL OF UNIFORM MINIMUM STANDARDS FOR DESIGN, CONSTRUCTION AND MAINTENANCE FOR STREET AND HIGHWAYS, AS ADOPTED BY THE STATE OF FLORIDA LEGISLATURE, CHAPTER 72-328 F.S.





MEDSQUARE PEMBROKE I SEC OF JOHNSON ST & NW 101ST PEMBROKE PINES, FL

DESIGNED BY: DRAWN BY:



PROJECT:

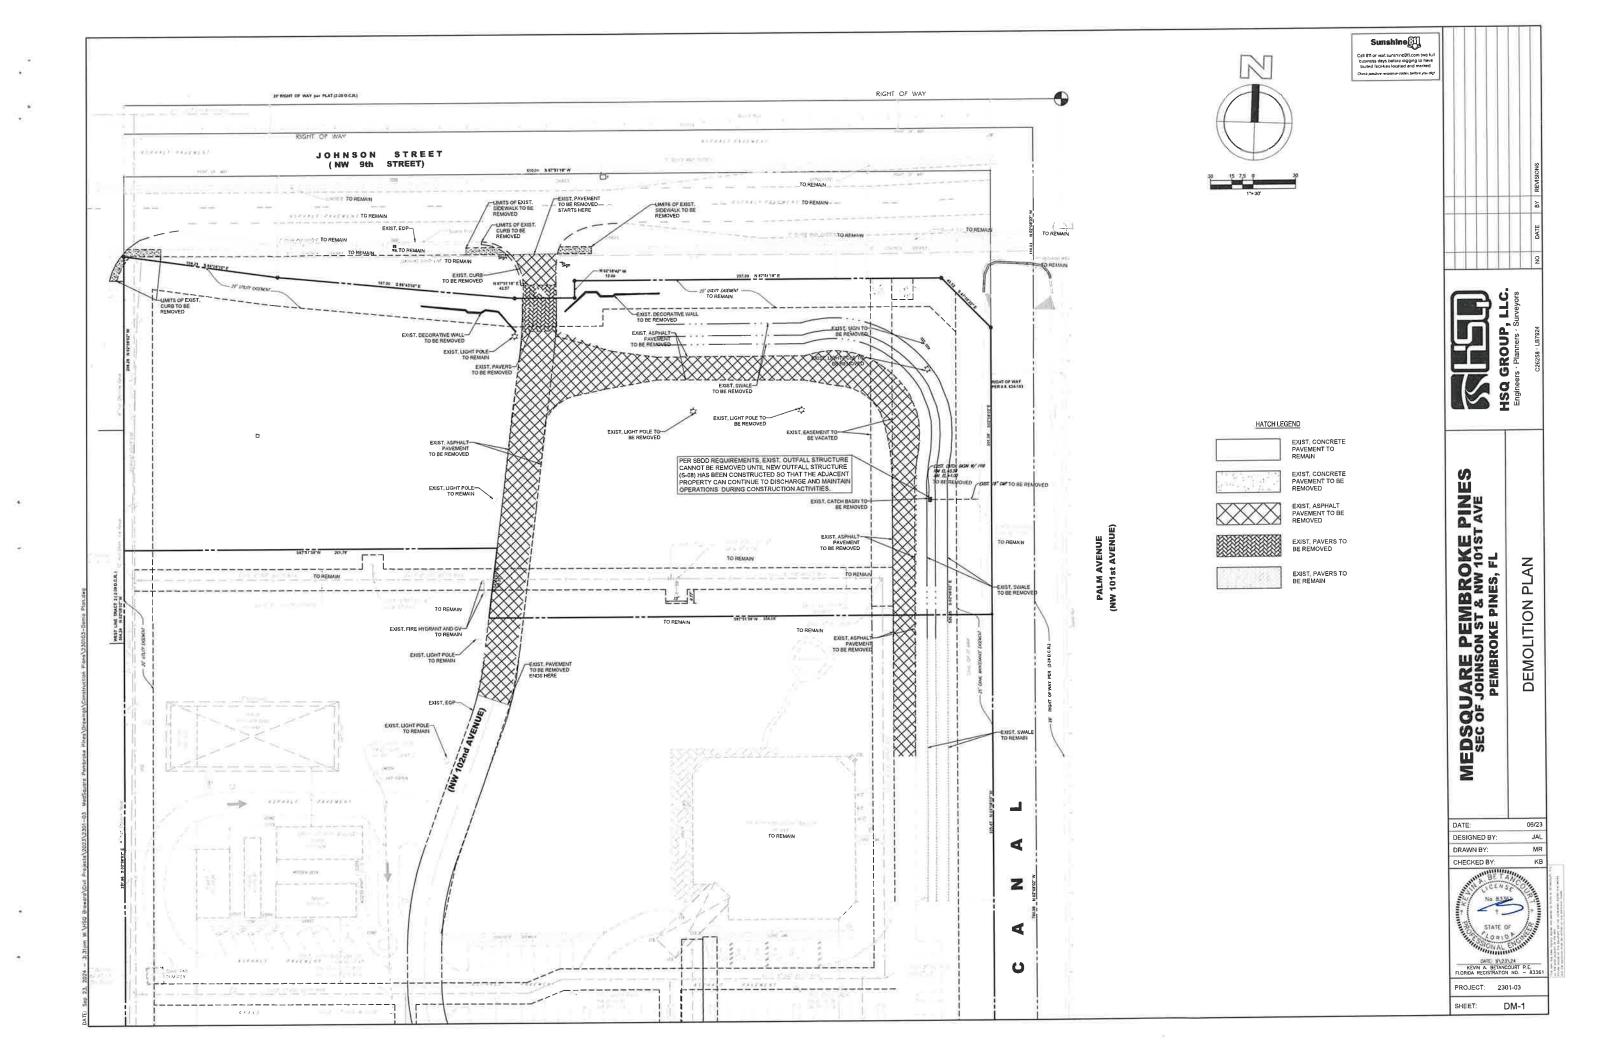

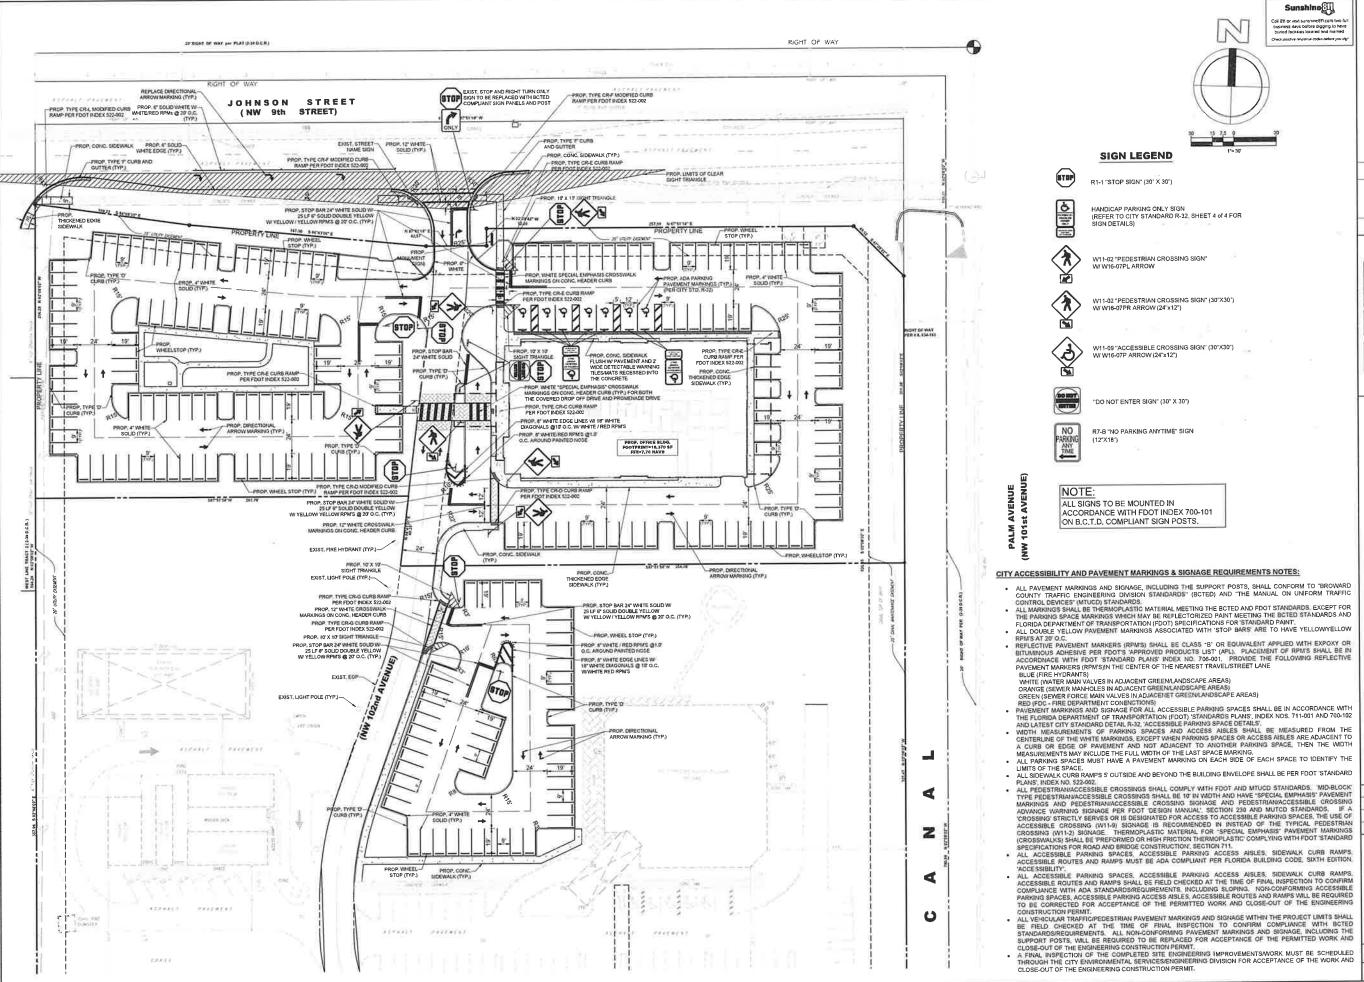

COUP, I Ō

S

QUARE OF JOHNSO

DS


PLAN ARE PEMBROKE PIN JOHNSON ST & NW 101ST AVE PEMBROKE PINES, FL S MARKING **PAVEMENT** AND SIGNAGE


DATE: 06/23 DESIGNED BY: JAL DRAWN BY MR CHECKED BY No 8336

STATE OF KEVIN A. BETANCOURT P.E. ORIDA REGISTRATION


PROJECT: 2301-03

HEET:

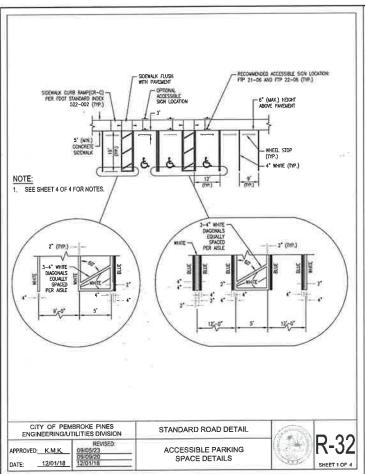

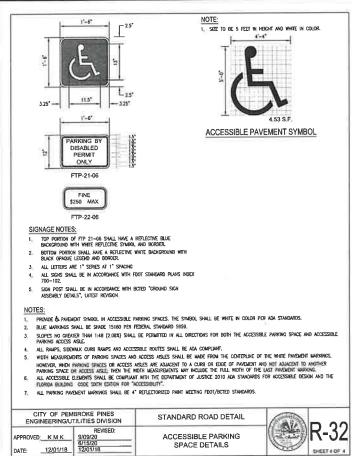

SHEET 4 OF 4

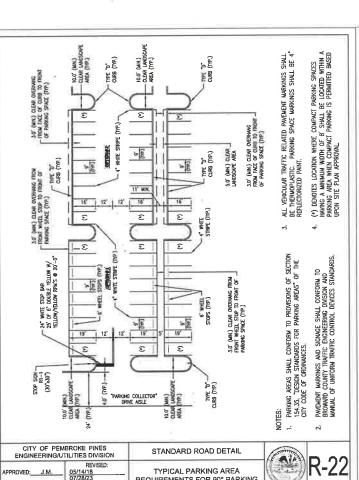


TYPICAL PARKING AREA

REQUIREMENTS FOR 90° PARKING

05/14/18 07/28/23

11/05/99

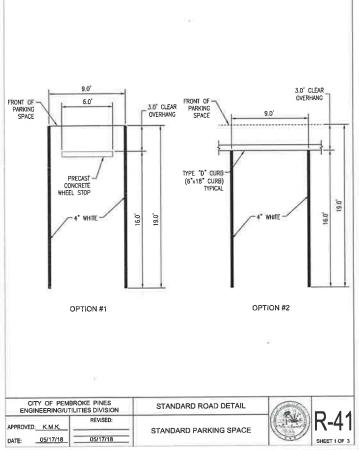

GENERAL TRAFFIC NOTES AND CONDITIONS:

- 1, ALL STOP BARS ARE TO BE INSTALLED 4" MIN, BEHIND ADJACENT TRAVEL LANES OR PEDSTRIAN CROSS WALKS,
- 2 ALL STOP SIGNS AND DO NOT ENTER SIGNS ARE TO BE COLUMN MOUNTED AT A HEIGHT OF 7'-0" MINIMUM.
- ${\tt 3}_{\scriptscriptstyle \parallel}{}^{\scriptscriptstyle \perp}$ Contractor shall be responsible for the installation of all pavement markings and signs as SHOWN IN THE PLANS PER APPLICABLE TRAFFIC DESIGN STANDARDS
- 4. CONTRACTOR SHALL BE RESPONSIBLE FOR REPLACING AND MATCHING EXISTING PAVEMENT MARKINGS AND REFLECTIVE PAVEMENT MARKERS WHERE REQUIRED.
- ANY SIGNING MATERIAL, INCLUDING SUPPORTS TO BE REMOVED, SHALL BE DELIVERED BY THE CONTRACTOR TO DADE COUNTY'S TRAFFIC SIGNALS AND SIGNS MAINTENANCE FACILITY LOCATED AT 7100 NORTHWEST 36th STREET, MIAMI, FLORIDA
- $6_{\scriptscriptstyle \parallel}$ SIGN ASSEMBLY LOCATIONS SHOWN IN THE PLANS WHICH ARE IN CONFLICT WITH STREET LIGHTING UTILITIES, DRIVEWAYS, PEDESTRIAN RAMPS, ETC, MAY BE ADJUSTED AS DIRECTED BY THE ENGINEER AND/OR INSPECTOR
- 7. CONTRACTOR SHALL REMOVE ALL EXISTING PAVEMENT MARKINGS THAT ARE IN CONFLICT WITH PROPOSED RECONFIGURATION BY WATER JETTING METHOD OR APPROVED EQUAL







DETAILS

PAVEMENT MARKINGS


AND


SIGNAGE


DATE: 06/23 DESIGNED BY JAL DRAWN BY: CHECKED BY: KB

PROJECT: 2301-03 SPM-2 SHEET:

MEDSQUARE PEMBROKE PINES SEC OF JOHNSON ST & NW 101ST AVE PEMBROKE PINES, FL

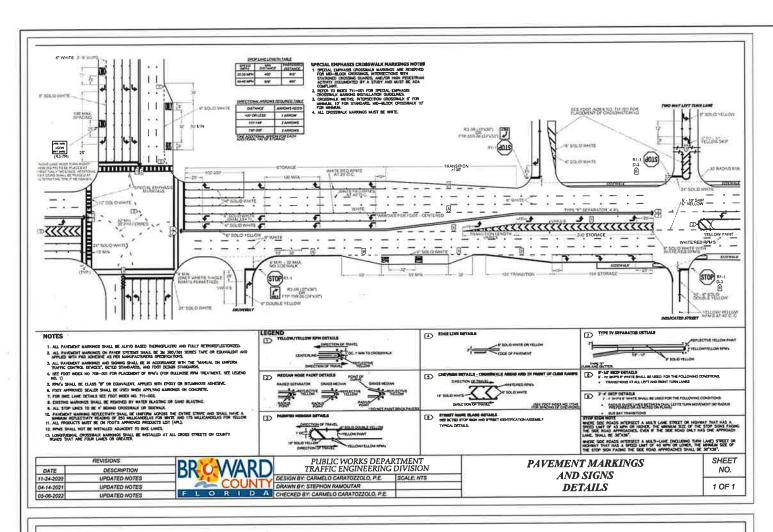

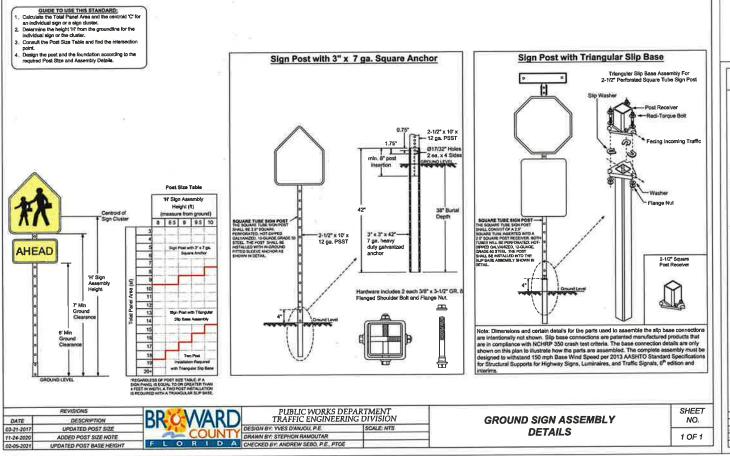

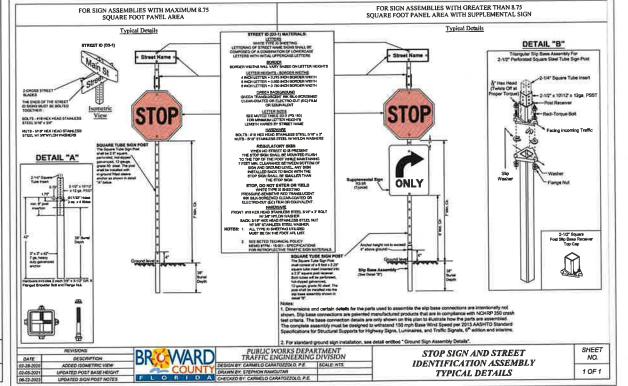







DETAIL

PAVEMENT MARKINGS

య


SIGNAGE


PINES QUARE PEMBROKE
OF JOHNSON ST & NW 101ST
PEMBROKE PINES, FL MEDS


DATE: JAL DESIGNED BY: MR DRAWN BY: CHECKED BY: KB





PROJECT: 2301-03 SHEET: SPM-3

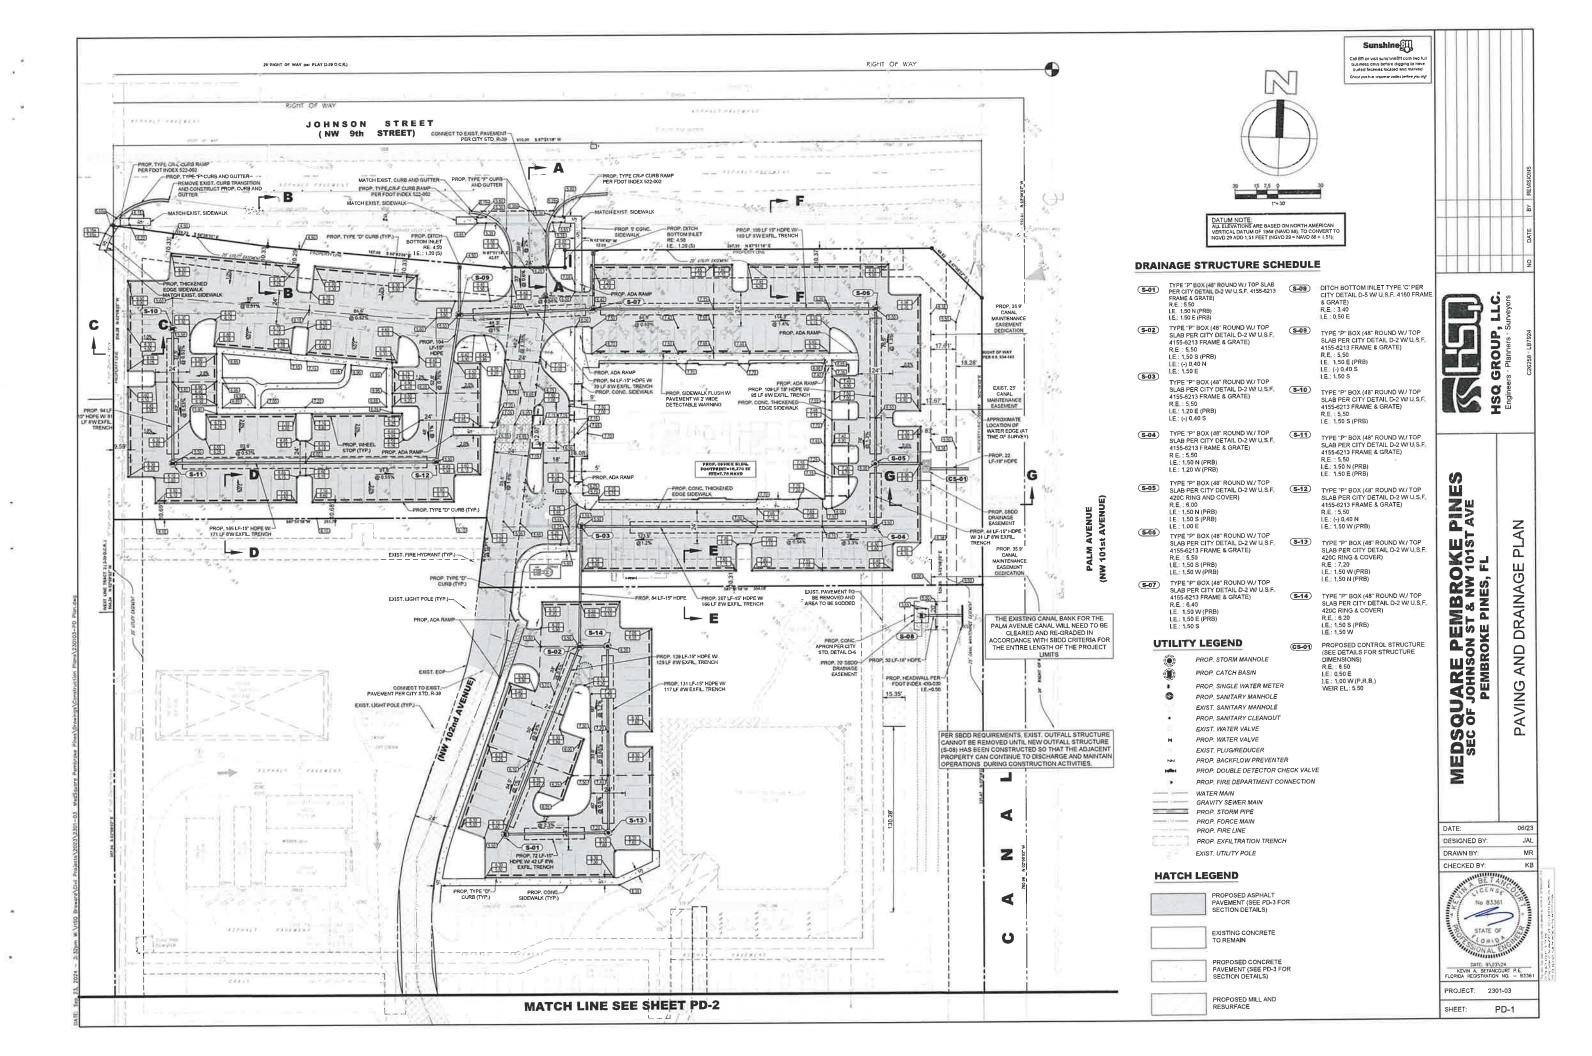


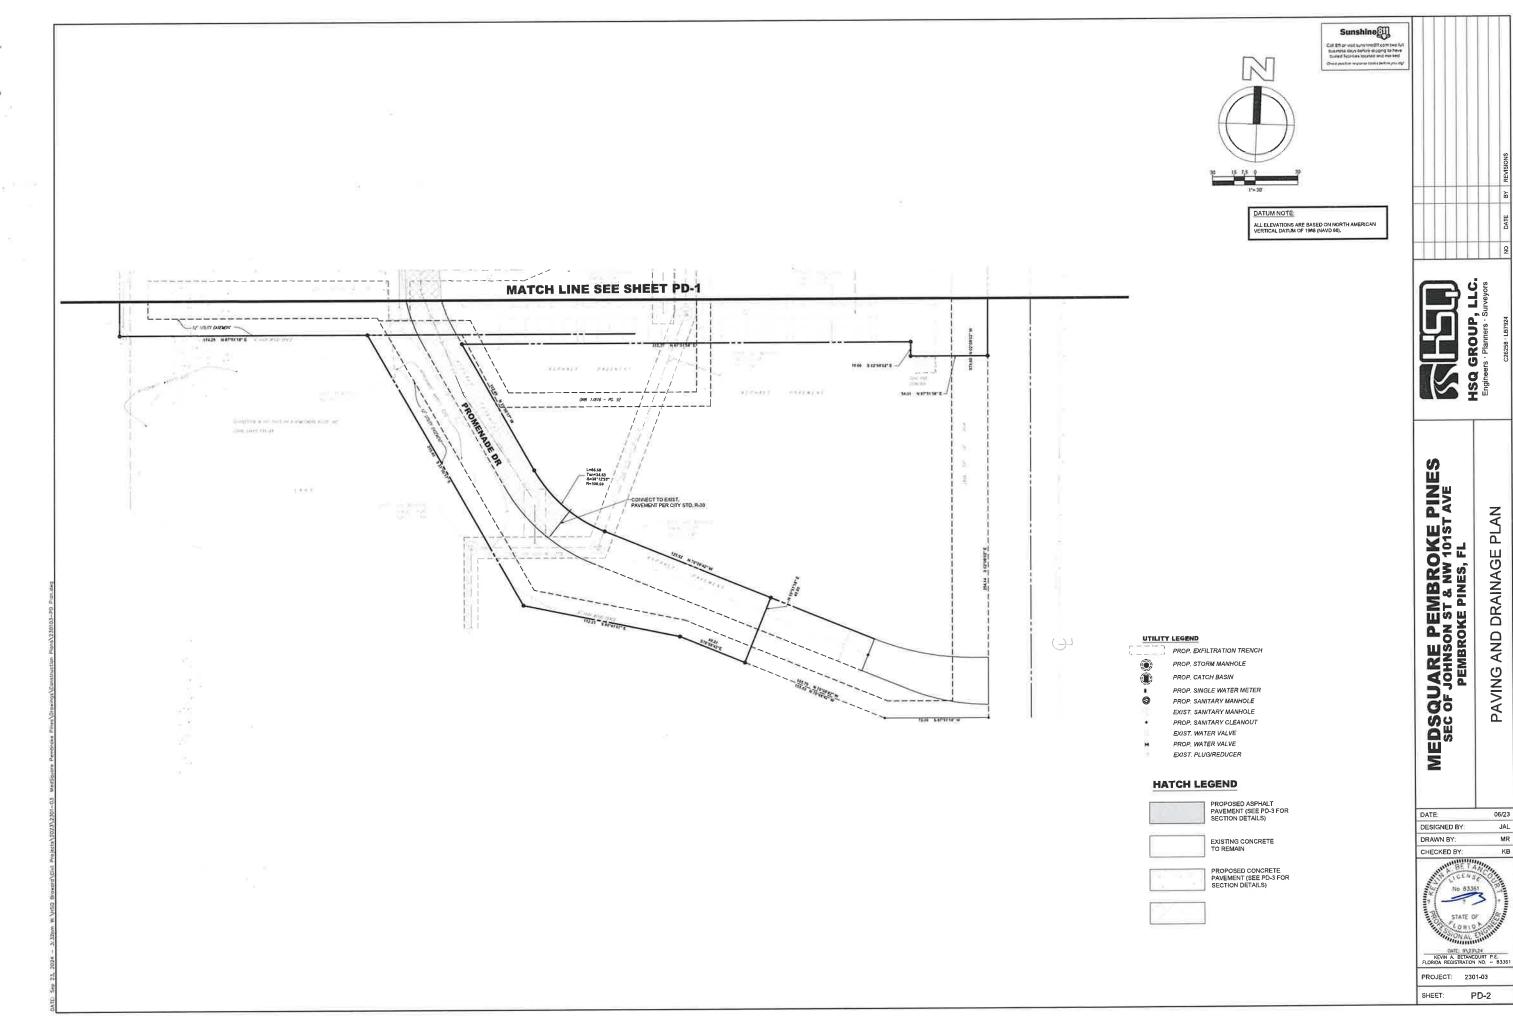


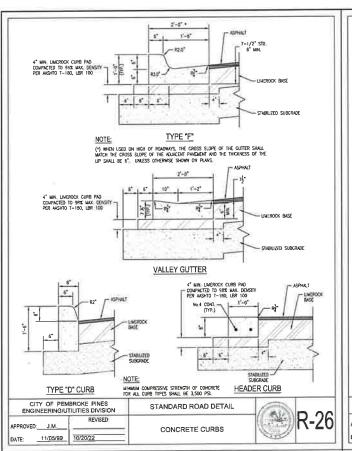

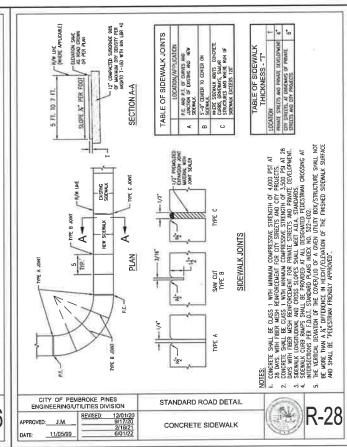

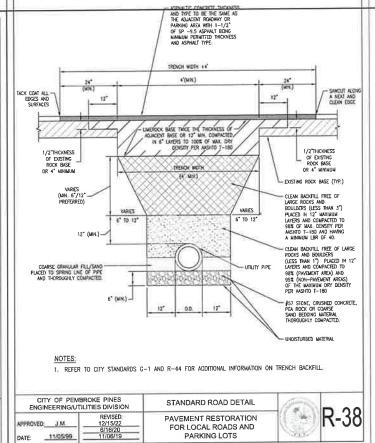

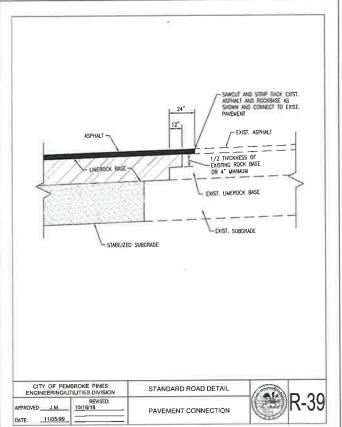


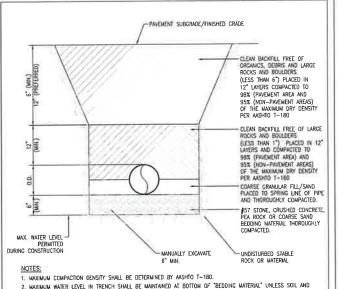

1. MAXIMUM COMPACION DENSITY STANDLE DE CERCINATE DE ACEMINE DE TEODO DE TEODO MATERIAL." UNLESS SOIL AND WATER TABLE CONDITIONS DICTATE OTHERWISE, THEM AN ALTERNATE METHOD OF CONTROLLING THE WATER LEVEL IN THE TERNOH AND/OF AN ALTERNATE WHOOD OF INSTALLATION IN "YET CONCRIDINGS" SHALL BE PROPOSED BY CONTRACTOR AND ENGINEER AND APPROVED BY THE CITY'S FIELD REPRESENTATIVE FOR FIELD USE. WHERE SOIL CONDITIONS CANNOT BE MAINTAINED PER TRENCH SECTION SHOWN ABOVE, PROVIDE APPROVED MEANS OF CONSTRUCTION.

4. WHERE REQUIRED SHEETING AND SHORING SHALL BE IN ACCORDANCE WITH THE LOCAL GOVERNMENTAL AGENCY.
5. MUCK OR OTHER UNSUITABLE MATERIAL SHALL BE COMPLETELY REMOVED WITHIN TRENCH SECTION. 6. WHEN THE PIPE IS LAID IN THE PREPARED TRENCH, TRUE TO LINE AND GRADE, THE PIPE BARREL SHALL RECENT CONTINUOUS UNIFORM SUPPORT, JS7 STONE, 3/4* WASHED ROCK, CRUSHED STONE, PEA ROCK OR COARSE SAND SHALL BE USED TO PROWDE UNIFORM BEDDONG.
7. JOINTS ARE REQUIRED TO BE WRAPPED WITH FILTER FABRIC.

| CITY OF PEMBE ENGINEERING/UTIL | | STANDARD ROAD DETAIL | - A |
|-----------------------------------|--|-------------------------|-----|
| APPROVED K.M.K. | REVISED: 12/15/22 01/14/21 02/05/20 | TYPICAL TRENCH BACKFILL | R-4 |

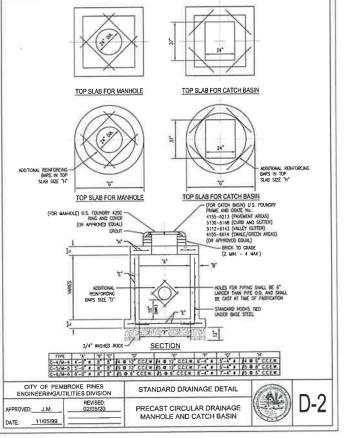







DETAILS

DRAINAGE


AND

PAVING


MEDSQUARE PEMBROKE PINI SEC OF JOHNSON ST & NW 101ST AVE PEMBROKE PINES, FL

DATE: 0208023 DESIGNED BY: JAI MR CHECKED BY:

PROJECT: 2301-03 SHEET: PD-3

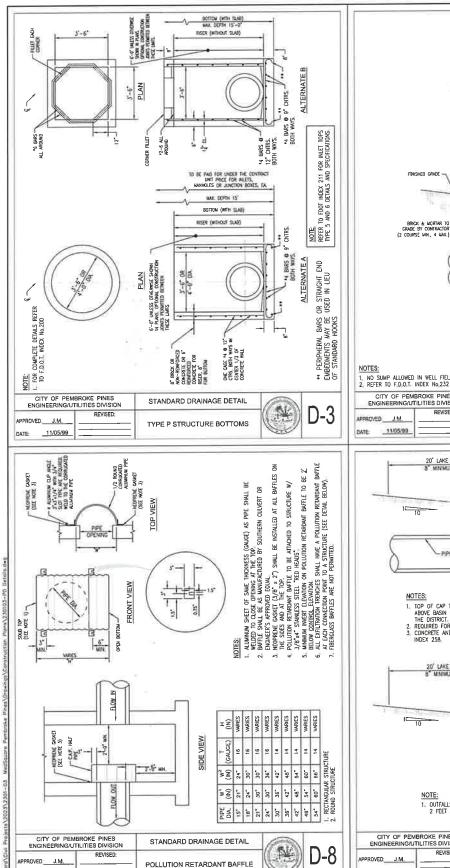


DATE: __11/05/99

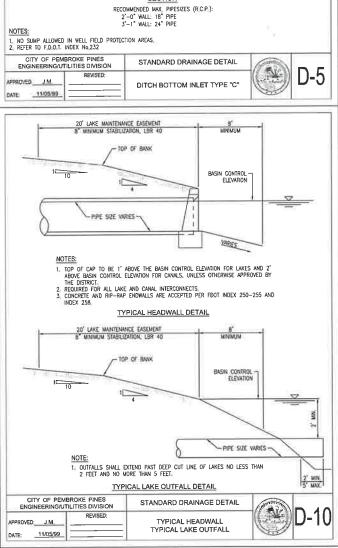



3-4

8" ON PUBLIC R/W PLAN

SECTION

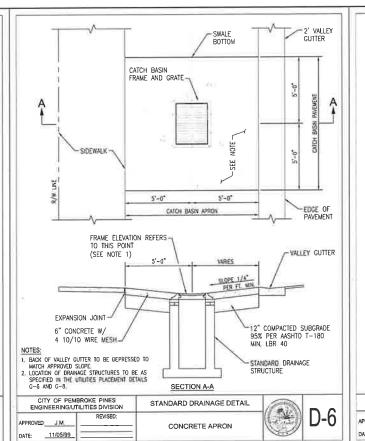

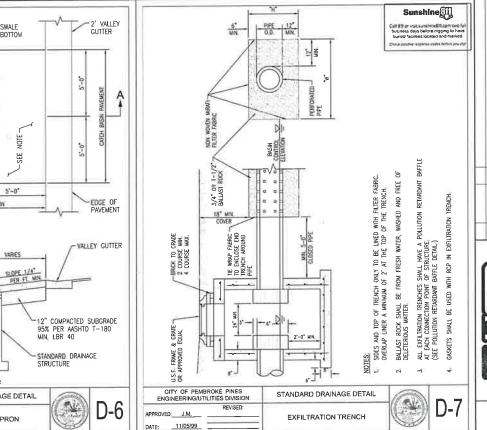

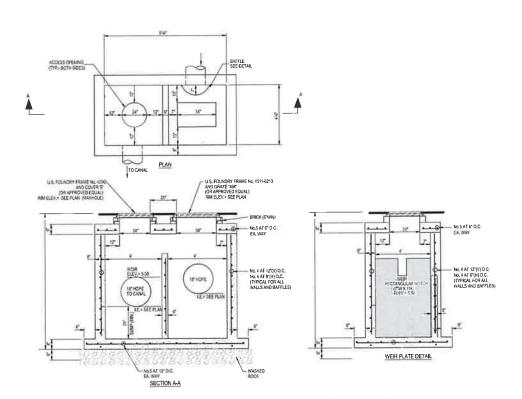

CONTROL STRUCTURE DETAIL - CS-01



GROUP, LLC. ers · Planners · Surveyors

HSQ Engineer

DETAILS

DRAINAGE


PAVING AND


DATE: 0208723
DESIGNED BY: JAL
DRAWN BY: MR
CHECKED BY: KB

KEVIN A BETANCOURT P.E. FLORIDA REGISTRATION NO. – 8.

PROJECT: 2301-03

SHEET: PD-4

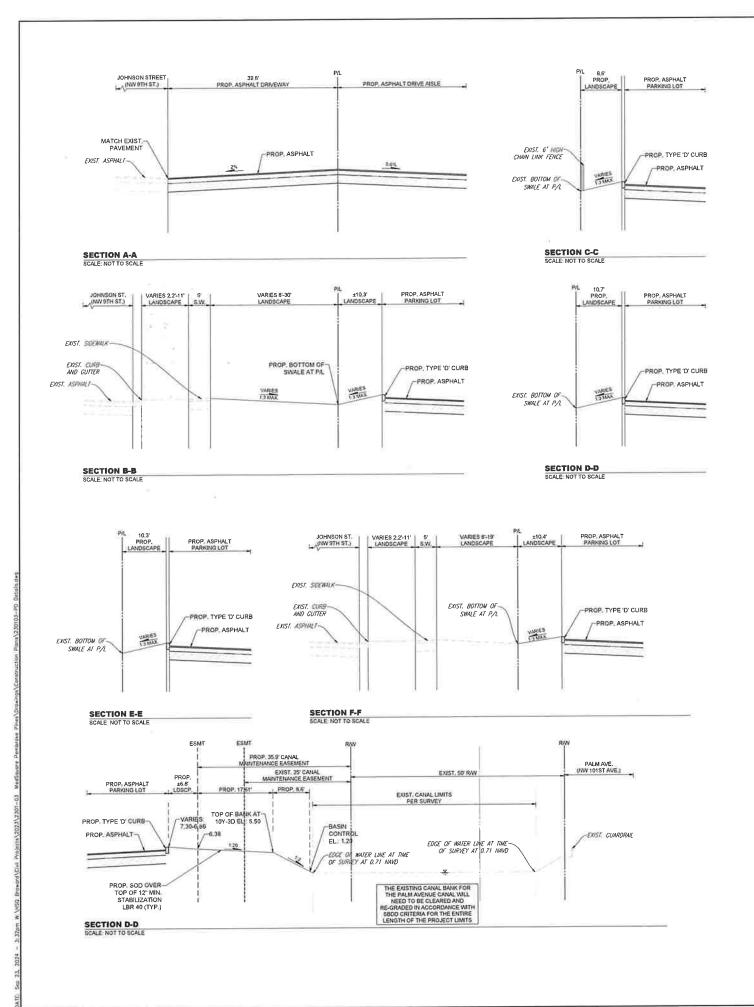


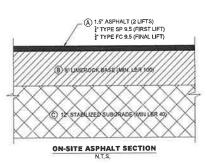



4000 PSI CONCRETE

(C) 12" STABILIZED SUB-BASE

© 3" ASPHALT (2 LIFTS)
1.5" TYPE SP 9.5 (FIRST LIFT) (TRAFFIC LEVEL B)
1.5" TYPE FC 9.5 (FINAL LIFT) (TRAFFIC LEVEL B, PG 76-22)

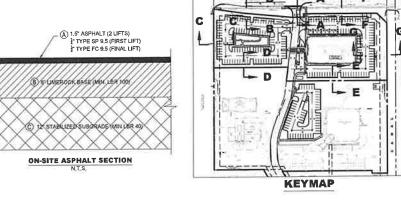

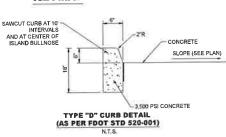

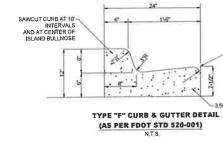

CONSTRUCTION NOTES

CONCRETE PAVEMENT DETAIL

(IN VEHICULAR USE AREAS)

C) 12 STABILIZED SUBGRADE WIN LER 402

PUBLIC RIGHT OF WAY

OFF-SITE ASPHALT SECTION

- 1. THESE PAVING AND DRAINAGE PLANS WERE PREPARED BASED ON TOPOGRAPHIC INFORMATION TAKEN FROM A TOPOGRAPHIC SURVEY PREPARED BY OTHERS.
 2. CONTRACTOR SHALL VERIEY HORIZONTAL AND VERTICAL LOCATION OF ALL EXISTING STORM SEWER STRUCTURES, PIPES, AND ALL UTILITIES PRIOR TO CONSTRUCTION.

 3. THE CONTRACTOR IS SPECIFICALLY CAUTIONED THAT THE LOCATION AND FOR ELEVATION OF ALL EXISTING UTILITIES (ABOVE AND BELLOW GROUND) AS SHOWN ON THESE PLANS ARE BASED ON EITHER VISUAL OBSERVATIONS AT THE SITE, EXISTING SPEVEYS, ANDIOR FROM UTILITY OWNERS AND DOSS NOT GUARANTEE THAT EXISTING UTILITY LOCATIONS ARE EXACT. IT SHALL BE THE RESPONSIBILITY OF THE CONTRACTOR TO DETERMINE THE EXACT LOCATIONS OF EXISTING UTILITIES (ABOVE AND BELOW GROUND) BEFORE BEGINNING ANY CONSTRUCTION. THE CONTRACTOR SHALL CALL APPROPRIATE UTILITY COMPANIES AND THE UTILITIES (ABOVE AND BELOW GROUND) BEFORE BEGINNING ANY CONSTRUCTION. THE CONTRACTOR SHALL CALL APPROPRIATE UTILITY COMPANIES AND THE UTILITIES PROTECTION.

 CENTER AT LEAST 72 HOURS BEFORE ANY EXCAVATION TO REQUEST EXACT FIELD LOCATIONS OF UTILITIES.

 IT SHALL BE THE RESPONSIBILITY OF THE CONTRACTOR TO NOTIFY OWNER AND / OR ENGINEER OF ANY UTILITY CONFLICTS WITH THE PROPOSED IMPROVEMENTS SHOWN ON THE PLAMS.
- ON THE PLANS
- ON THE PLANS. ALL CUT OR FILL SLOPES SHALL BE 3.1 OR FLATTER UNLESS OTHERWISE NOTED
- 5. ALL CUT OR FILL SLOPES SHALL BE 3.1 OR FLATTER VINLESS OTHERWISE NOTED.
 6. EXISTING DRAINAGE STRUCTURES TO DE INSPECTED AND REPAIRED AS NEEDED, AND RISTING PIPES TO BE CLEANED OUT TO REMOVE ALL SILTS AND DEBRIS.
 7. IF ANY EXISTING STRUCTURES TO REMAIN ARE DAMAGED DURING CONSTRUCTION, IT SHALL BE THE CONTRACTORS RESPONSIBILITY TO REPAIR ANDIOR REPLACE THE EXISTING STRUCTURE AS NECESSARY TO RETURN IT TO EXISTING CONDITIONS OR RETTER

- EXISTING STRUCTURE AS NECESSARY TO RETURN IT TO EXISTING CONDITIONS OR BETTER.

 8. ALL STORM PIPE ENTERING STRUCTURES SHALL BE GROUTED TO ASSURE CONNECTION AT STRUCTURE IS WATERTIGHT.

 9. ALL STORM SEWER MANHOLES IN PAVED AREAS SHALL BE FLUSH WITH PAVEMENT, AND SHALL HAVE TRAFFIC BEARING RING AND COVERS.

 10. THE CONTRACTOR SHALL ADHERE TO ALL TERMS AND CONDITIONS AS OUTLINES IN THE GENERAL IN P.D.E.S. PERMIF FOR STORM WATER DISCHARGE ASSOCIATED WITH CONSTRUCTIONS ACTIVITIES.

 11. CONTRACTOR SHALL ASSURE POSITIVE DRAINAGE AWAY FROM BUILDING AND FOR ALL NATURAL AND PAVED AREAS.

 12. ALL UN-SURFACED AREAS DISTURBED BY GRADING OPERATION SHALL RECEIVE 4 INCHES OF TOPSOIL CONTRACTOR SHALL GRASS DISTURBED AREAS IN ACCORDANCE WITH CITY / COUNTY SPECIFICATIONS UNTIL HEALTHY STAND OF GRASS IS OBTAINED.

 13. PROPOSED SPOT ELEVATIONS REPRESENT FINISHED PAVEMENT OR GROUND SURFACE GRADE UNLESS OTHERWISE NOTED ON DRAWMOS.
- GRADE UNLESS OTHERWISE NOTED ON DRAWINGS.

 14. CONTRACTOR SHALL TRIM, TACK, AND MATCH EXISTING PAVEMENT AT LOCATIONS
- WHERE NEW PAVEMENT MEETS EXISTING PAVEMENT

 15. EXISTING MANHOLES AND VALVE BOXES TO REMAIN IN PLACE SHALL BE ADJUSTED TO

- 15. EXISTING MANHOLES AND VALUE BOXES TO REMAIN IN PLACE SHALL BE ADJUSTED TO FINAL GRADES.

 16. CONTRACTOR TO SAW-CUT AT ALL LOCATIONS OF REMOVAL OF EXISTING CONC. SIDEWALK, CONC. CURB AND ASPHALT UNLESS OTHERWISE NOTED. ALL BASE AND SUBASE MATERIAL SHALL BE REMOVED WITHIN THE PROPOSED LANDSCAPED AREA.

 17. CONTRACTOR TO MATCH EXIST. GRADES AND TO CONSTRUCT A SMOOTH TRANSITION FROM EXISTING FACILITIES TO PROPOSED.

 18. CONTRACTOR TO REMOVE ALL CONSTRUCTION DEBRIS FROM CONSTRUCTION SITE AND DISPOSE PER LOCAL ORDINANCES.

 19. CONTRACTOR TO SOD ALL DISTURBED AREAS, SODDING INCLUDES MAINTAINING SLOPE AND SOD UNTIL COMPLETION AND ACCEPTANCE OF THE TOTAL PROJECT OR GROWTH IS ESTABLISHED WHICHEVER COMES LAST.
- 20. ALL EXISTING TRAFFIC SIGNS DISTURBED DURING CONSTRUCTION SHALL BE REINSTALLED WHERE APPLICABLE BY THE CONTRACTOR
- REINOJALLEU VYTEKE APPLICABLE BY THE CONTRACTOR. 21. 20% MAXIMUM SLOPE ON HANDICAP SPACES AND ADA ACCESS WAYS. 22. ALL SIDEWALKS SHOULD HAVE A MAXIMUM CROSS SLOPE OF 2.0%

ON-SITE PAVEMENT NOTES

- THE PAVEMENT SURFACE SHALL BE ASPHALTIC CONCRETE. A TACK COAT SHALL BE APPLIED BETWEEN BOTH PAVEMENT COURSES. REFER TO SECTIONS FOR ASPHALT TYPE AND THICKNESS.
- 2. THE LIMEROCK BASE SHALL HAVE A MINIMUM LIMEROCK BEARING RATIO (L.B.R.) VALUE OF 100. THE LIMEROCK MATERIAL SHALL BE COMPACTED TO A DENSITY EQUAL TO OR GREATER THAN 98% OF THE MAXIMUM DRY DENSITY PER A.A.S.H.T.O.T-180 SPECIFICATIONS, REFER TO SECTIONS FOR PAVEMENT TYPE AND THICKNESS.
- 3. THE SUBGRADE SHALL BE A MINIMUM OF 12 INCHES THICK. THE SUBGRADE I'ME SUBJEKAUE STALL BLE A MINIMUM LIMEROCK BEARING RATIO (L.B.R.) VALUE OF 40.
 THE SUBGRADE MATERIAL SHALL BE COMPACTED TO A DENSITY EQUAL TO OR
 GREATER THAN 88% OF THE MAXIMUM DRY DENSITY PER A.A.S.H.T.O. T-180
- THE LIMEROCK AND SUBGRADE COURSES SHALL NOT BE CONSTRUCTED UNTIL ALL UTILITY INSTALLATIONS UNDER PAVEMENT AREAS HAVE BEEN COMPLETED, TESTED AND ACCEPTED. ANY PAVEMENT CONSTRUCTION PRIOR TO THIS REQUIREMENT SHALL BE CONDUCTED AT THE CONTRACTOR'S OWN RISK AND ANY REQUIRED REPAIRS WILL BE THE CONTRACTOR'S SOLE RESPONSIBILITY AND EVPENSE.
- THE PRIME AND TACK COATS SHALL CONFORM TO THE FLORIDA DEPARTMENT OF TRANSPORTATION (SECTIONS 300-1 THRU 300-7) SPECIFICATIONS. THE PRIME COAT SHALL BE APPLIED AT A RATE OF 0.25 GALLONS PER SQUARE YARD OF
- PERIODIC DENSITY TESTING SHALL BE CONDUCTED AFTER BOTH SUBGRADE AND LIMEROCK BASE COURSES HAVE BEEN COMPLETED, THE TOTAL NUMBER AND EXACT LOCATIONS OF THE TESTS SHALL BE DETERMINED BY EITHER THE ENGINEER-OF- RECORD OR GOVERNMENT INSPECTOR. THE MINIMUM AN TESTING SHALL BE BASED ON ONE (1) DENSITY TEST PER 5,000 SQUARE FEET OF
- THE SECOND (FINAL) LIFT SHALL EXTEND 1/4 INCH ABOVE THE LIP OF CURB. THE FINAL LIFT OF ASPHALT SHALL NOT BE APPLIED UNTIL EITHER THE CLIENT, ENGINEER-OF-RECORD AND/OR GOVERNMENT AGENCY DETERMINES THAT STANTIAL PROJECT CONSTRUCTION HAS BEEN COMPLETED
- ALL EXISTING ORGANIC AND DELETERIOUS MATERIALS WITHIN THE RIGHT-OF-WAY ALL EXISTING ORGANIC AND DUEL EIGHOUS MATERIALS WITHIN THE RIGHT-OF-WAT AND ON-SITE PAYEMENT AREAS ARE TO BE REMOVED TO THEIR FULL DEPTH AND REPLACED WITH APPROVED SUITABLE MATERIAL, UNLESS AN ALTERNATIVE METHOD IS RECOMMENDED BY A CERTIFIED GEOTECHNICAL ENGINEER. THE DETERMINATION OF ORGANIC AND UNSUITABLE MATERIALS SHALL BE BASED ON F.D.O.T. STANDARDS.
- ALL EXISTING PAVEMENT CONNECTIONS AND REPAIRS SHALL HAVE A STRAIGHT SAW-CUT EDGE PRIOR TO APPLYING NEW ASPHALT PAVEMENT.
- 10. ONCE FINAL LIFT OF ASPHALT HAS BEEN APPLIED, ALL PERMANENT CONTROL POINTS, REFERENCE MARKERS, VALVES, INLET AND MANHOLE RIMS SHALL BE FIELD ADJUSTED TO BE FLUSH WITH FINAL ASPHALT GRADES.



Sunshine

NAL LIFT OF ASPHALT BE # ABOVE UP OF CURB



PIN ETAIL! JARE PEMBROKE JOHNSON ST & NW 101ST PEMBROKE PINES, FL AND S CTIONS Ш Ś 40 က် OF. CROSS DS(


06/23 DATE: DESIGNED BY JAL DRAWN BY HECKED BY: KB

Σ



PROJECT: 2301-03

PD-5 SHEET

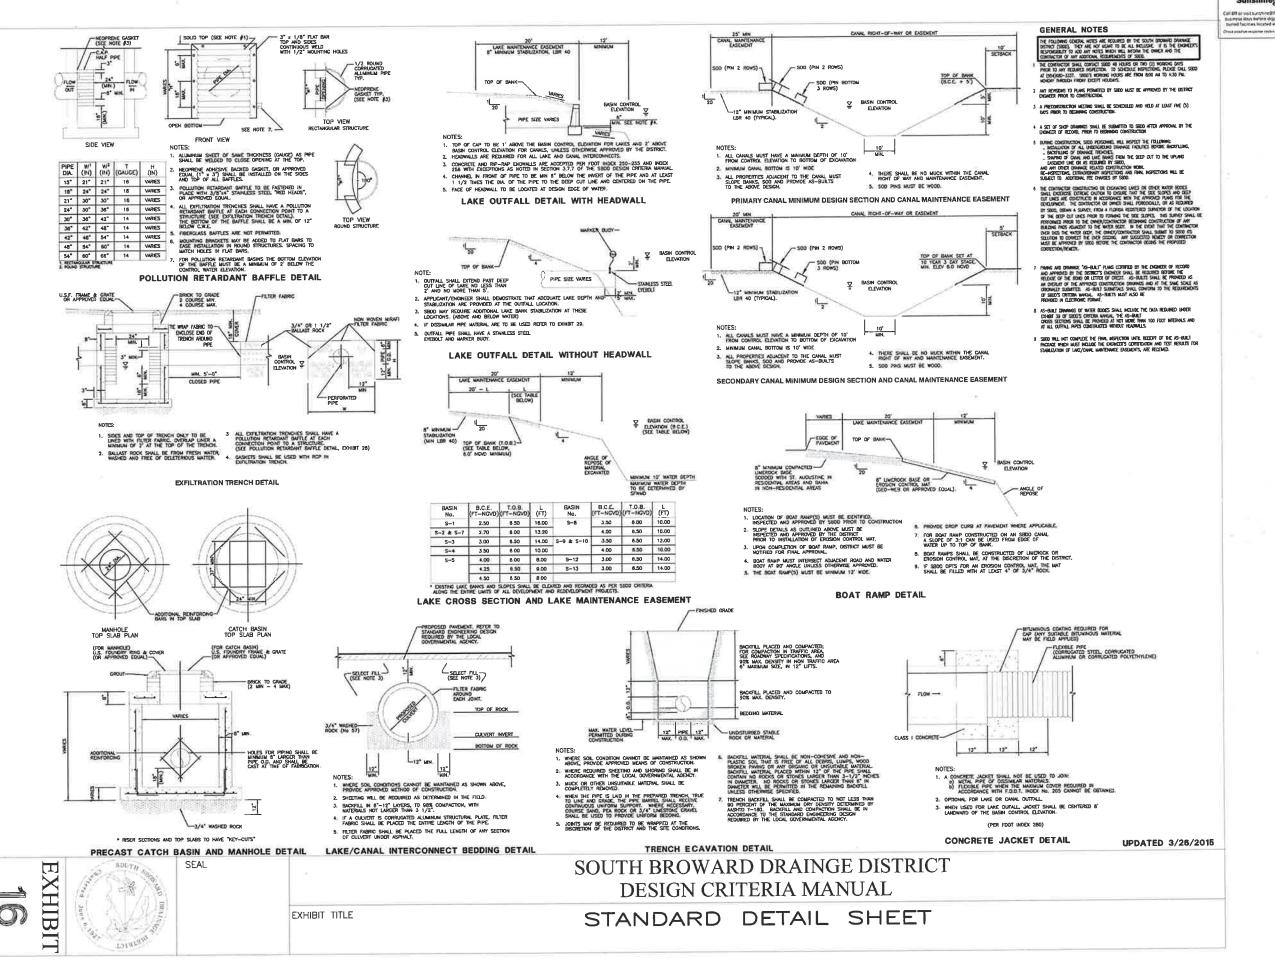

5

ES

BDD


MEDSQUARE PEMBROKE PINI SEC OF JOHNSON ST & NW 101ST AVE PEMBROKE PINES, FL

DATE: 0202023 JAL DESIGNED BY DRAWN BY: CHECKED BY



PROJECT: 2301-03

PD-6 SHEET:

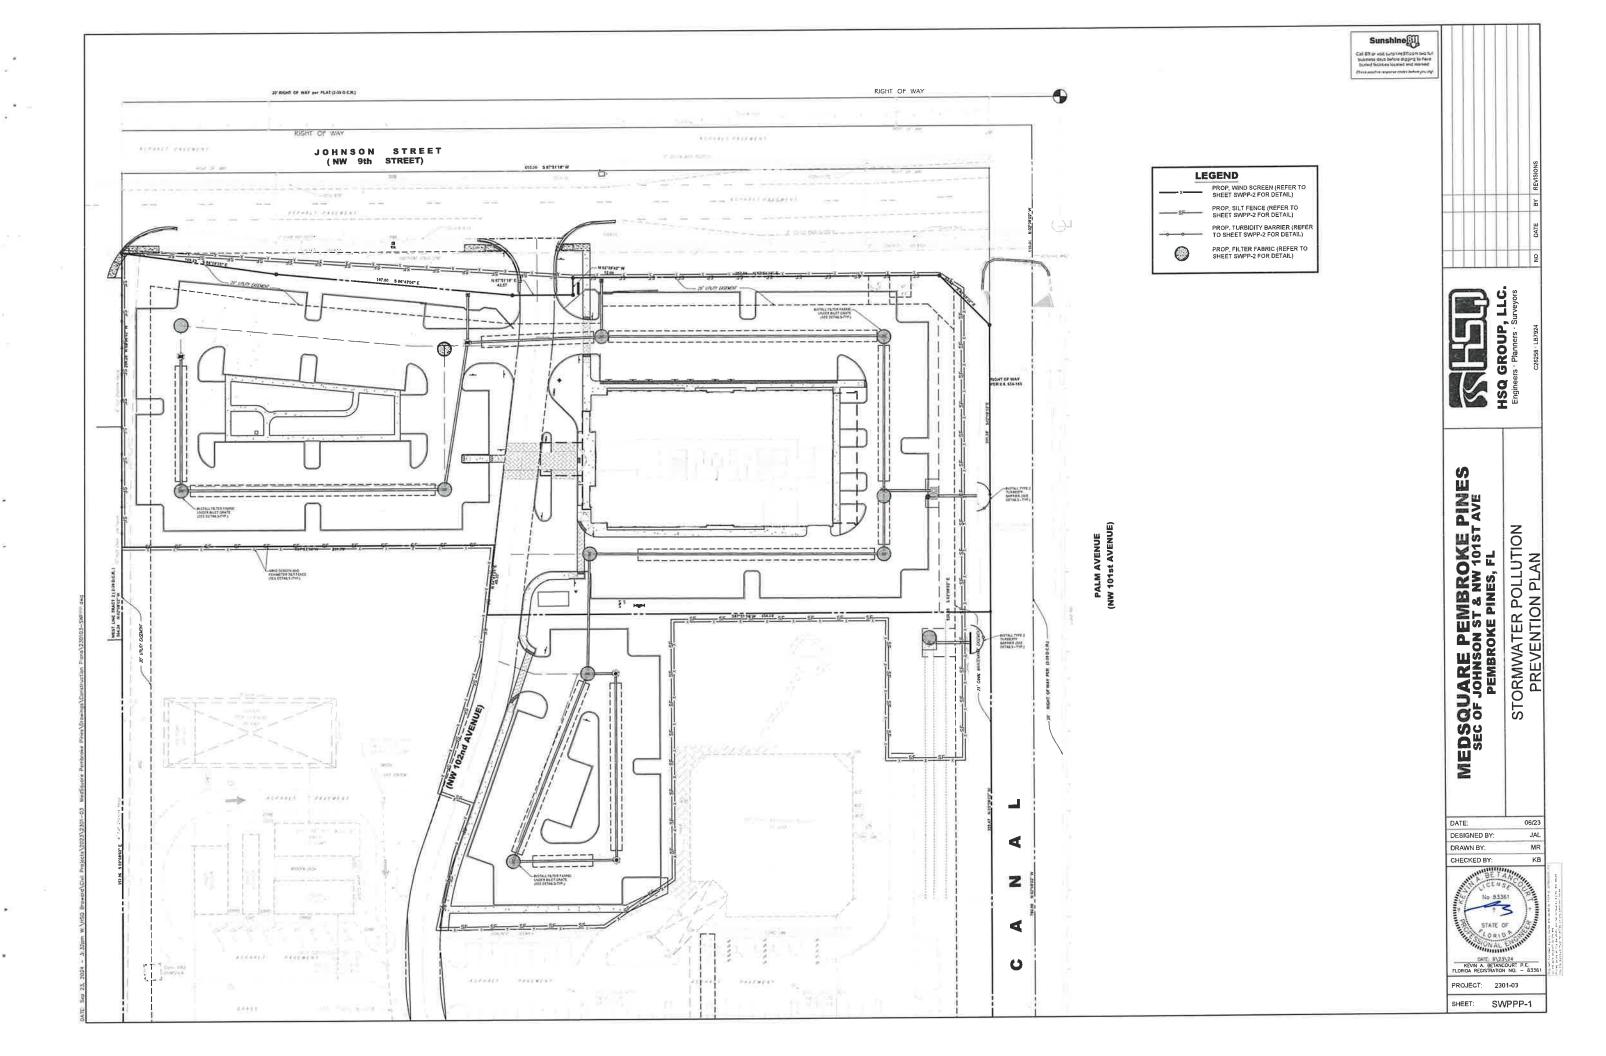

SILT FENCE INSTALLATION DETAIL

SILT FENCE & POST INSTALLATION NOTES

- THE HEIGHT OF THE SILT FENCE SHALL BE INSTALLED AT A MINIMUM OF 24 INCHES BUT SHALL
- 1. THE HEIGHT OF THE SILT FENCE SHALL BE INSTALLED AT A MINIMUM OF 24 INCHES BUT SHALL NOT EXCEED 36 INCHES.

 7. THE FILTER FABRIC MATERIAL SHALL BE PURCHASED IN A CONTINUOUS ROLL IN ORDER TO BE ABLE TO CUT THE ENTIRE REQUIRED LENGTH IN ONE PIECE AND AVOID THE USE OF JOINTS.

 7. WHEN STANDARD STRENGTH FILTER FABRIC MATERIAL IS USED. A WELDOD WIRE MESH SUPPORT SHALL BE FASTENED SECURELY TO THE UP SLOPE SIDE OF THE FENCE POSTS BY USING EITHER HEAVY DUTY WIRE STAPLES AT LEAST 1 INCH LONG. TE WIRES OR HOG RINGS, THE WIRE SHALL EXTEND INTO THE TRENCH A MINIMUM OF 2 INCHES AND SHALL NOT EXTEND MORE THAN 36 INCHES ABVE THE ORIGINAL GROUND SURFACE.

 7. THE FILTER FABRIC MATERIAL SHALL BE EITHER STAPLED OR WIRED TO THE FENCE POSTS AND 12 INCHES OF THE FABRIC SHALL NOT EXTEND MORE THAN 36 INCHES ABVE THE GROUND SURFACE.

 8. A 6"XS" TRENCH SHALL BE CONSTRUED ALONG THE BOTTOM INTO THE TRENCH. THE FABRIC SHALL NOT EXTEND MORE THAN 36 INCHES ABOVE THE GROUND SURFACE.

 9. OSTS AND UP SLOPE FROM THE BARRIER IN GODER TO BURY THE BOTTOM 12 INCHES OF THE FILTER FABRIC MATERIAL. THE TRENCH SHALL BE BACK FILLED AND THE SOIL COMPACTED OVER THE FILTER FABRIC.

 8. THE FILTER FABRIC.

 8. THE FILTER FABRIC.


 9. THE FILTER FABRIC.

 10. THE FENCE POSTS SHALL BE INSTALLED AT A MAXIMUM OF 10 FEET APART AND DRIVEN SEQUELY INTO THE GROUND FOR A MINIMUM OF 12 INCHES WHEN THE FILTER FABRIC IS USED WITHOUT WIRE MESH SUPPORT. IF WIRE SUPPORT IS USED THEN THE FENCE POSTS SHALL BE SPACED AT A MAXIMUM OF 6 FEET APART.


 10. WHEN INSTALLING TWO SILT FENCES AROUND THE PERIMETER. PLACE THE POSTS OF THE SECOND FENCE INSTALLED AT THE FIRE PLACE FLOOR STALLED AT A MAXIMUM ON THE SECOND FENCE INSTITUTION TO GROUND FOR A MINIMUM OF 12 INCHES WHEN THE FILTER FABRIC IS USED WITHOUT WINE MESH SUPPORT. IF WIRE SUPPORT IS USED THEN THE FENCE POSTS SHALL BE SPACED AT A MAXIMUM OF 6 FEET APART.

 10. WHEN INSTALLING TWO SILT FENCES AROUND THE PERIMETER. PLACE THE POSTS OF THE SECOND FENCE INSTALLED TO CREATE A TIGHT SEAL. FOLLOW ALL OTHER STANDARD INSTALLATION REQUI


- INSTALLATION REQUIREMENTS.

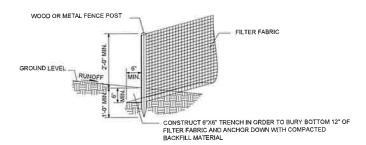

POST & FILTER FABRIC INSTALLATION DETAIL

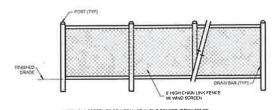

WIND SCREEN DETAIL

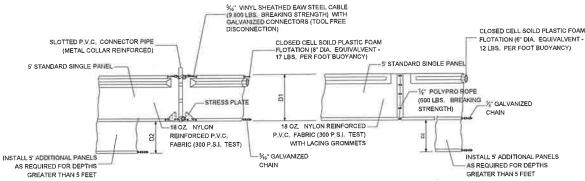

FLOATING TURBIDITY BARRIER INSTALLATION DETAIL

TYPE 1

FLOATING TURBIDITY BARRIER INSTALLATION NOTES

TYPE 2

- 1. FLOATING TURBIDITY BARRIERS SHALL BE INSTALLED WITHIN EXISTING LAKES AND/OR CANALS. REFER TO STORMWATER POLLUTION PREVENTION PLANS FOR
- ANDIOR CANALS. REPERTO STORMWATER POLICITION REVEYENDS TO RESEARCT LOCATIONS.
 CONTRACTOR MAY INSTALL A SUBSTITUTION FOR THE TYPE 1 AND TYPE 2 FLOATING TURBIDITY BARRIERS ONLY IF APPROVED BY BOTH THE ENGINEER-OF-RECORD AND THE APPLICABLE GOVERNMENTAL AGENCIES. THE TURBIDITY BARRIER CURTAIN BOTTOM SHALL REACH A MINIMUM DEPTH OF 10 FEET FROM THE EXISTING WATER ELEVATION. MULTIPLE PANELS OR SPECIAL DEPTH CURTAINS SHALL BE USED IF THE PLANS OR ENGINEER-OF-RECORD SPECIFY DEPTHS GREATER THAN 10 FEET.

GENERAL EROSION AND TURBIDITY CONTROL NOTES


- ALL EROSION AND TURBIDITY CONTROL DEVICES AND TEMPORARY BARRIERS SHALL BE INSTALLED WITHIN THE LIMITS OF THE CONSTRUCTION AREA PRIOR TO ANY CONSTRUCTION ACTIVITIES COMMENCING.
 A TEMPORARY BARRIER SHALL BE INSTALLED AROUND ALL WETLAND AND/OR NATURAL PRESERVATION AREAS PRIOR TO ANY CONSTRUCTION ACTIVITIES COMMENCING. NO CONSTRUCTION VEHICLES SHALL ENCROACH WITHIN THESE AREAS, CONTRACTOR SHALL HAVE ALL EXISTING UNDERGROUND UTILITIES LOCATED BY APPROPRIATE AGENCIES PRIOR TO INSTALLATION OF ANY EROSION AND TURBIDITY CONTROL DEVICES AND BARRIERS.
- BARRIERS,
 DURING CONSTRUCTION ACTIVITIES, EXISTING PERIMETER NATIVE VEGETATION SHALL
 REMAIN IN ORDER TO ACT AS A BUFFER BETWEEN ADJACEMT PROPERTIES, AND TO MINIMIZE
 NUISANCE DUST, NOISE, AND/OR AIR POLLUTION,
 PRACTICES SUCH AS SEEDING, MULCHING AND WETTING WHICH MINIMIZE AIRBORNE DUST
 AND PARTICULATE EMISSIONS GENERATED DURING CONSTRUCTION ACTIVITIES SHALL BE
 USED AS DIRECTED BY BOTH THE ENGINEER-OF-RECORD AND/OR APPLICABLE
 GOVERNMENTAL AGENCIES. GOVERNMENTAL AGENCIES.
- GUVERNMEN IAL AGENCIES.
 ALL AREAS DISTRIBUTED DURING CONSTRUCTION ACTIVITIES, WHICH ARE NOT GOING TO BE PAVED OR LANDSCAPED, SHALL BE SEEDED AND MULCHED.

BACKFILL AFTER INSTALLATION OF INLET FILTER FABRIC SECURE FILTER FABRIC TO FRAME & GRATE FILTER FARRIC INSTALLATION ON INSTALL WIRE SUPPORT MOULD


FILTER FABRIC INSTALLATION DETAIL

FILTER FABRIC INSTALLATION NOTES


- CONTRACTOR SHALL CLEAN OUT DRAINAGE INLET AND FILTER FABRIC AFTER EVERY STORM EVENT OR AS NEEDED.
 CONTRACTOR SHALL REPAIR AND/OR REPLACE ALL DAMAGED FILTER FABRIC WITHIN INLETS DURING CONSTRUCTION OPERATIONS.
- 3. CONTRACTOR SHALL REMOVE FILTER FABRIC FROM DRAINAGE INLETS PRIOR TO STARTING FINAL PAVING OPERATIONS

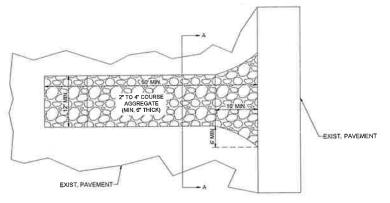

PLAN VIEW (N.T.S.)

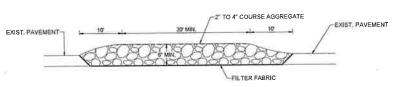


SIDE VIEW (N.T.S.)

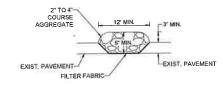

SECTION A-A (N.T.S.)

CONSTRUCTION ENTRANCE DETAIL

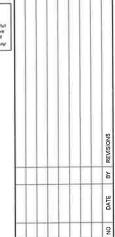

Sunshi



GROUP

PINES

STORMWATER POLLUTION PREVENTION PLAN DETAILS EDSQUARE PEMBROKE
SEC OF JOHNSON ST & NW 101ST
PEMBROKE PINES, FL

DATE: 06/23 JAL DESIGNED BY: DRAWN BY: MR

2



SHEET: SWPPP-2



| | A 7-STORY TOWER AND 4-STORY PARKING GARAGE INCLUDING 119 DWELLING UNITS AND 250 PARKING SPACES, 7-STORY TOWER A 120 DWELLING UNITS AND 26 AT GRADE PARKING SPACES, AND A 5,000 S.F. CLUBHOUSE BUILDING WITH COMMUNITY. |
|---|--|
| DESCRIBE THE INTENDED SEQUENCE OF MAJOR SOIL DISTURBING ACTIVITIES: | 1. CLEAR & GRUB EXISTING VEGETATION WITHIN THE SITE. 2. HAUL OFF SITE CLEARED MATERIAL 3. EXPORT FILL OFF SITE 4. START SITE EARTHWORK GRADING. |
| EXISTING DATA DESCRIBING THE SOIL OR QUALITY OF ANY STORMWATER DISCHARGE FROM THE SITE: | EXISTING SOILS ARE CLASSIFIED AS MEDIUM SAND (SP) WITH LIMESTONE UNDERNEATH, |
| ESTIMATE THE DRAINAGE AREA SIZE FOR EACH DISCHARGE POINT: | ALL DRAINAGE AND DEWATERING TO REMAIN ON SITE |
| LATTUDE AND LONGITUDE OF EACH DISCHARGE POINT AND IDENTIFY THE RECEIVING WATER OR MS4 FOR EACH DISCHARGE POINT: | DISCHARGE POINTS: N/A RECEIVING WATER BODY: N/A |
| THE PROPER APPLICATION RATES OF ALL FERTILIZERS, HERBICIDES AND PESTICIDES USED AT THE CONSTRUCTION SITE: | NO FERTILIZERS, HERBICIDES, AND/OR PESTICIDES TO BE USED DURING THE CONSTRUCTION OPERATOINS. |
| THE STORAGE, APPLICATION, GENERATION AND MIGRATION OF ALL TOXIC SUBSTANCES: | NO TOXIC SUBSTANCES WILL BE STORED ON THE PROJECT SITE DURING THE CONSTRUCTION OPERATIONS. |
| WASTE DISPOSAL, THIS MAY INCLUDE CONSTRUCTION DEBRIS, CHEMICALS, LITTER, AND SANITARY WASTES: | TEMPORARY WASTE DISPOSAL SERVICES, INCLUDING SANITARY WASTES, WILL BE PROVIDED BY LOCAL SERVICE COMPANY, |
| OFFSITE VEHICLE TRACKING FROM CONSTRUCTION ENTRANCES (EXITS: | CONSTRUCT TEMPORARY GRAVEL ENTRANCE (REFER TO EROSION CONTROL DETAILS ON SHEET #######) |
| OTHER: | N/A |

800 NW 5TH AVENUE, CITY OF MIAMI, FLORIDA, 33136

13,86 ACRES

3,70 ACRES

CONSTRUCTION OF

PROJECT LOCATION:

TOTAL AREA OF THE SITE

TOTAL AREA OF THE SITE TO BE DISTURBED

DESCRIBE THE NATURE OF THE CONSTRUCTION ACTIVITY

GIVE A DETAILED DESCRIPTION OF ALL CONTROLS, BEST MANAGEMENT PRACTICES (BMPS) AND MEASURES THAT WILL BE IMPLEMENTED AT THE CONSTRUCTION SITE FOR EACH ACTIVITY IDENTIFIED IN THE INTENDED SEQUENCE OF MAJOR SOIL DISTURBING ACTIVITIES SECTION, PROVIDE TIME FRAMES IN WHICH THE CONTROLS WILL BE IMPLEMENTED, NOTE. ALL CONTROLS SHALL BE CONSISTENT WITH PERFORMANCE STANDARDS FOR EROSION AND SEDIMENT CONTROL AND STORMWATER TREATMENT SET FORTH IN S. 62-40.432, F.A.C., THE APPLICABLE STORMWATER OR ENVIRONMENTAL RESOURCE PERMITTING REQUIREMENTS OF THE DEPARTMENT OR A WATER MANAGEMENT DISTRICT, AND THE GUIDELINES CONTAINED IN THE FLORIDA DEVELOPMENT MANUAL: A GUIDE TO SOUND LAND AND WATER MANAGEMENT (DEP, 1988) AND ANY SUBSEQUENT AMENDMENTS.

- 1. A SILT FENCE SHALL BE INSTALLED AROUND THE ENTIRE PERIMETER OF THE CONSTRUCTION SITE.
- 2, ROCK BAGS SHALL BE INSTALLED ON ALL OPEN GRATE DRAINAGE INLETS,

DESCRIBE ALL TEMPORARY AND PERMANENT STABILIZATION PRACTICES, STABILIZATION PRACTICES INCLUDE TEMPORARY SEEDING, MULCHING, PERMANENT SEEDING, GEOTEXTILES, SOD STABILIZATION, VEGETATIVE BUFFER STRIPS, PROTECTION OF TREES, VEGETATIVE PRESERVATIONS, ETC.

THE PERIMETER SILT FENCE AND WIND SCREEN SHALL BE MAINTAINED AROUND THE ENTIRE CONSTRUCTION SITE UNTIL THE PERMANENT PERIMETER BERM HAS BEEN CONSTRUCTED AND STABILIZED.

DESCRIBE ALL STRUCTURAL CONTROLS TO BE IMPLEMENTED TO DIVERT STORMWATER FLOW FROM EXPOSED SOILS AND STRUCTURAL PRACTICES TO STORE FLOWS, RETAIN SEDIMENT ON-SITE OR IN ANY OTHER WAY LIMIT STORMWATER RUNOFF. THESE CONTROLS INCLUDE SILT FENCES, EARTH DIKES, DIVERSIONS, SWALES, SEDIMENT TRAPS, CHECK DAMS, SUBSURFACE DRAINS, PIPE SLOPE DRAINS, LEVEL SPREADERS, STORM DRAIN INLET PROTECTION, ROCK OUTLET PROTECTION, REINFORCED SOIL RETAINING SYSTEMS, GABIONS, COAGULATING AGENTS AND TEMPORARY OR PERMANENT SEDIMENT BASINS,

- 1. SILT FENCES
- 2. ROCK BAGS
- 3. TURBIDITY BARRIERS

INSPECTIONS: DESCRIBE THE INSPECTION AND INSPECTION DOCUMENTATION PROCEDURES, AS REQUIRED BY PART V.D.A. OF THE PERMIT, INSPECTIONS MUST OCCUR AT LEAST ONCE A WEEK AND WITHIN 24 HOURS OF THE END OF A STORM EVENT THAT IS 0,50 INCHES OR GREATER (SEE ATTACHED FORM).

- 1. PROJECT/DEVELOPER SUPERINTENDENT WILL CONDUCT DAILY INSPECTIONS.
- 2. INSPECTION REPORTS WILL BE MAINTAINED ON-SITE BY PROJECT/DEVELOPER SUPERINTENDENT.

IDENTIFY AND DESCRIBE ALL SOURCES OF NON-STORMWATER DISCHARGES AS ALLOWED IN PART IV.A.3, OF PERMIT. FLOWS FROM FIGHTING ACTIVITIES DO NOT HAVE TO BE LISTED OR DESCRIBED.

NONE

DESCRIBE ALL SEDIMENT BASINS TO BE IMPLEMENTED FOR AREAS THAT WILL DISTURB 10 OR MORE ACRES AT ONE TIME. THE SEDIMENT BASINS (OR EQUIVALENT ALTERNATIVE) SHOULD BE ABLE TO PROVIDE 3,600 CUBIC FEET OF STORAGE FOR EACH ACRE DRAINED. TEMPORARY SEDIMENT BASINS (OR AN EQUIVALENT ALTERNATIVE) ARE RECOMMENDED FOR DRAINAGE AREAS UNDER 10 ACRES.

- 1. NO TEMPORARY SEDIMENT BASINS WILL BE USED DURING THE CONSTRUCTION OF THIS PROJECT.
- DEWATERING OPERATIONS WILL BE HANDLED THROUGH TWO (2) TEMPORARY ON-SITE DISCHARGE WELLS. ALL CONSTRUCTION EFFLUENT WILL BE DISCHARGED INTO AN APPROVED G-III AQUIFER PER FLORIDA ADMINISTRATIVE CODE (FAC) 62-520,410.

DESCRIBE ALL PERMANENT STORMWATER MANAGEMENT CONTROLS SUCH AS, BUT NOT LIMITED TO, DETENTION OR RETENTION SYSTEMS OR VEGETATED SWALES THAT WILL BE INSTALLED DURING THE CONSTRUCTION PROCESS.

 THE STORMWATER MANAGEMENT CONTROLS FOR THIS DEVELOPMENT WILL CONSIST OF THREE (3) PERMANENT ON-SITE STORMWATER DISCHARGE WELLS, THESE WELLS WILL DISCHARGE INTO AN APPPROVED G-III AQUIFER PER FLORIDA ADMINISTRATIVE CODE (FAC) 62-520.410. PROVIDE A DETAILED DESCRIPTION OF THE MAINTENANCE PLAN FOR ALL STRUCTURAL AND NON-STRUCTURAL CONTROLS TO ENSURE THAT THEY REMAIN IN GOOD AND EFFECTIVE OPERATING CONDITION.

- THE EROSION AND TURBIDITY CONTROL DEVICES WILL BE INSPECTED BY THE PROJECT/DEVELOPER SUPERINTENDENT ON A DAILY BASIS.
- ALL REQUIRED REPAIRS TO THE EROSION AND TURBIDITY CONTROL DEVICES SHALL BE MADE BY THE CONTRACTOR AND/OR DEVELOPER WITHIN A 24 HOUR PERIOD.

CONTRACTOR CERTIFICATION STATEMENT

"I CERTIFY UNDER PENALTY OF LAW THAT I UNDERSTAND, AND SHALL COMPLY WITH, THE TERMS AND CONDITIONS OF THE STATE OF FLORIDA GENERIC PERMIT FOR STORMWATER DISCHARGE FROM LARGE AND SMALL CONSTRUCTION ACTIVITIES AND THIS STORMWATER POLLUTION PREVENTION PLAN PREPARED THEREUNDER."

| NAME / TITLE | SIGNATURE | COMPANY NAME ADDRESS & PHONE NUMBER | DATE | |
|--------------|-----------|--|------|--|
| | | | | |
| | | | - | |
| | | | | |
| | | | | |
| | | | | |
| | | | | |

OPERATOR AND RESPONSIBLE AUTHORITY CERTIFICATION STATEMENT

"I CERTIFY UNDER PENALTY OF LAW THAT THIS DOCUMENT AND ALL ATTACHMENTS WERE PREPARED UNDER MY DIRECTION OR SUPERVISION IN ACCORDANCE WITH A SYSTEM DESIGNED TO ASSURE THAT QUALIFIED PERSONNEL PROPERLY GATHERED AND EVALUATED THE INFORMATION SUBMITTED. BASED ON MY INQUIRY OF THE PERSON OR PERSON WHO MANAGE THE SYSTEM, OR THOSE PERSONS DIRECTLY RESPONSIBLE FOR GATHERING THE INFORMATION, THE INFORMATION SUBMITTED IS, TO THE BEST OF MY KNOWLEDGE AND BELIEF, TRUE, ACCURATE AND COMPLETE. I AM AWARE THAT THERE SIGNIFICANT PENALTIES FOR SUBMITTING FALSE INFORMATION, INCLUDING THE POSSIBILITY OF FINE AND IMPRISONMENT FOR KNOWING VIOLATIONS."

| NAME / TITLE | SIGNATURE | COMPANY NAME ADDRESS & PHONE NUMBER | DATE |
|--------------|-----------|--|------|
| | | | |
| | | | |
| | | | |
| | | | |
| | | | |
| | | | |

NO DATE BY REVISIONS



E PINES ST AVE

EDSQUARE PEMBROKE PIN SEC OF JOHNSON ST & NW 101ST AVE PEMBROKE PINES, FL STORMWATER POLLUTION PREVENTION PLAN NOTES

DATE: 06/23
DESIGNED BY: JAL
DRAWN BY: MR


2




KEVIN A BETANCOURT P.E. RIDA REGISTRATION NO. - 8336

PROJECT: 2301-03

SHEET: SWPPP-3

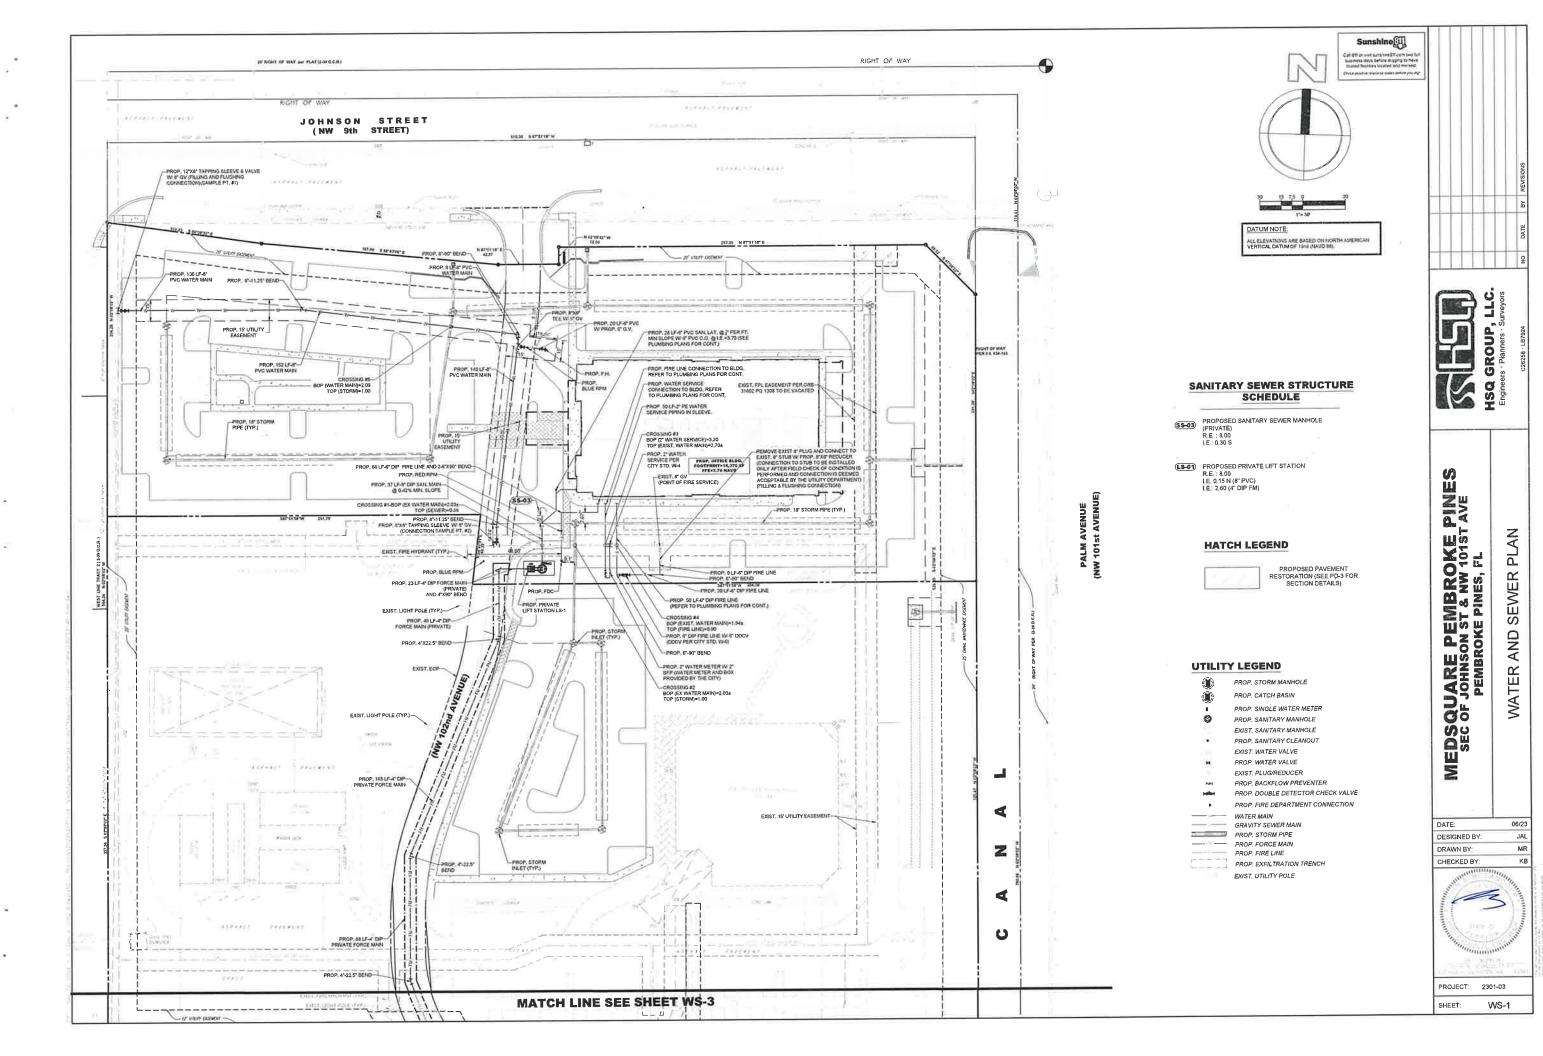

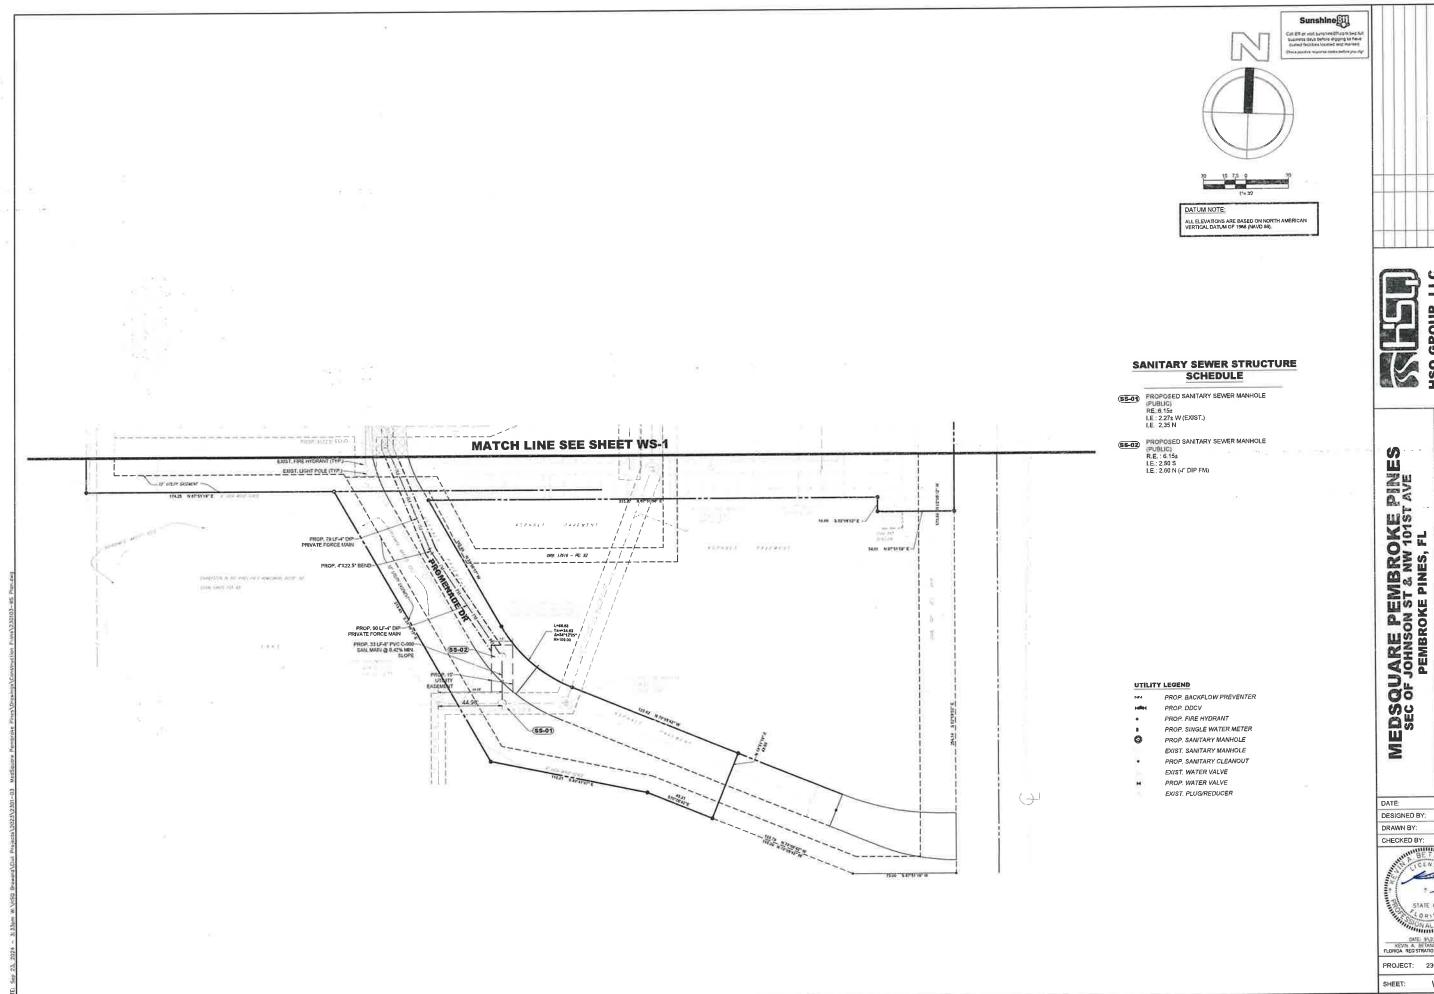






WATER AND SEWER PLAN

JAL DESIGNED BY:



PROJECT: 2301-03 WS-2

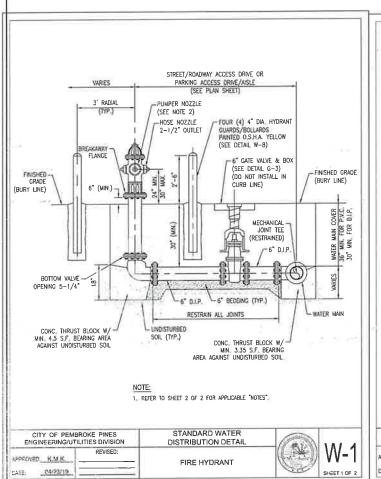





- FIRE HYDRANT SHALL BE "AMERICAN DARLING" OR "MUELLER" TYPE HAVING A MINIMUM 51/4" BOTTOM VALVE OPENING WITH A 41/2" PUMPER NOZZLE AND TWO (2) 21/2" HOSE NOZZLE OUTLETS, FIRE HYDRANT SHALL BE FACTORY PAINTED O.S.H.A. YELLOW.
- PUMPER NOZZLE OF THE FIRE HYDRANT TO FACE THE NEAREST ADJACENT STREET/ROADWAY, ACCESS DRIVE OR PARKING ACCESS BRINC/ASILE AND A BLUE REFLECTIVE PAYEMENT WARKER (RPM) SHALL BE INSTALLED IN THE CENTER OF THE TRAVEL LANE OF THE NEAREST ADJACENT STREET/ROADWAY, ACCESS DRIVE OR PARKING ACCESS DRIVE/ASILE.
- FIRE HYDRANT BURY UNE TO MATCH ADJACENT STREET/ROADWAY CROWN ELEVATION, AS MAY BE APPLICABLE, AND THE CLEARANCE BETWEEN THE BOTTOM OF THE BOLTS OF THE BREAKAWAY FLANGE AND GRADE SHALL BE 6" MINIOUM.
- FIRE HYDRAM'S SHALL BE LOCATED RELATIVE TO THE EDGE OF PAVEMENT FOR STREETS/ROJOWAYS BASED UPON "LATERAL OFFSET" REQUIREMENTS PER CHAPTER 4, "ROJOSIDE SAFETY", OF THE FLORIDA DEPARTMENT OF TRANSPORTATION (F.O.O.T.) "PLANS PREPARATION MANUAL", LATEST EDITION.
- FIRE HYDRANTS SHALL BE LOCATED A MINNUM OF 6' FROM THE EDGE OF THE PAVEMENT/FACE OF CURB OF AN ACCESS DRIVE OR PARKING ACCESS DRIVE/FAISE AND A MINNUM OF 5' FROM THE FACE OF CURB OF THE SIDE OF ANY TERMINAL OR INTERIOR PARKING LONGSCAPE (SLAVI).
- HYDRANT CHARGS / BOLLARDS SHALL BE PROVIDED AROUND THE FIRE HYDRANT AS SHOWN WHEN THE FIRE HORANT IS LOCATED WITH SIX (6) FEET OF THE EDGE OF PAREMENT OF A FUBLIC/PRIVATE STREET/ROADWAY, ACCESS DRIVE, PARKING ACCESS DRIVE/AISLE OR "TURNING RADIUS"
- 7. A SEVEN AND HALF (7.5') FOOT RADIUS AROUND THE FIRE HYDRANT CLEAR OF ALL IMPROVEMENTS SHALL BE
- 8. ALL WATER MAIN PIPING FITTINGS BACK TO THE 'SUPPLY MAIN' SHALL BE CLASS 52 DUCTILE IRON PIPE (D.L.P.) AND FITTINGS/SPOOL PIECES SHALL BE CLASS 350 DUCTILE IRON.
- ALL DIP, AND FITTINGS/SPOOL PIECES SHALL BE RESTRAINED WITH 'MEGALUGS' OR CITY APPROVED EQUAL
- 10. FIRE HYDRANT GATE VALVE SHALL BE INSTALLED AS CLOSE AS POSSIBLE TO THE "SUPPLY MAIN", SHOULD THE DISTANCE FROM THE "SUPPLY MAIN" TO THE FIRE HYDRANT LOCATION EXCEED TWENTY (20) FEET THEN A SECOND GATE VALVE IS REQUIRED TO BE INSTALLED AT THE HYDRANT.
- 11. DEPTH OF COVER TO THE TOP OF THE D.L.P. WATER MAIN SHALL BE 30" MINIMUM.
- 12. FIRE HYDRANTS SHALL HAVE THEIR TOP COLOR CODED TO INDICATE THE 'FLOW CAPACITY' IN GALLONS PER MINUTE (GPM) OF FLOW, AS FOLLOWS:

| FLOW | COLOR OF BONNET AND CA |
|----------------------|------------------------|
| 1,500 GPM OR GREATER | BLUE |
| 1,000 GPM OR GREATER | GREEN |
| 500 - 1,000 GPM | ORANGE |
| LESS THAN 500 GPM | RED |
| | |



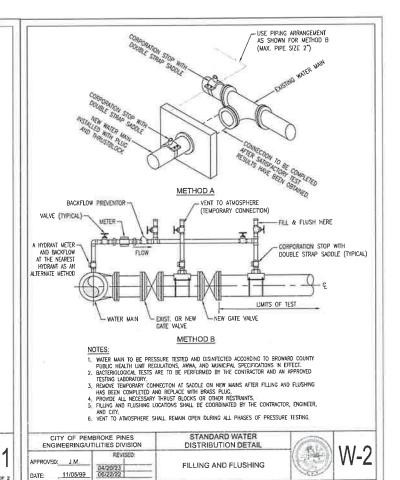

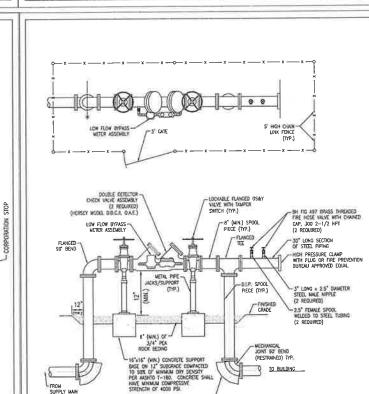







2

S

DETAIL

SEWER

AND


ER


MEDSQUARE PEMBROKE SEC OF JOHNSON ST & NW 101ST PEMBROKE PINES, FL





WS-3

SHEET:

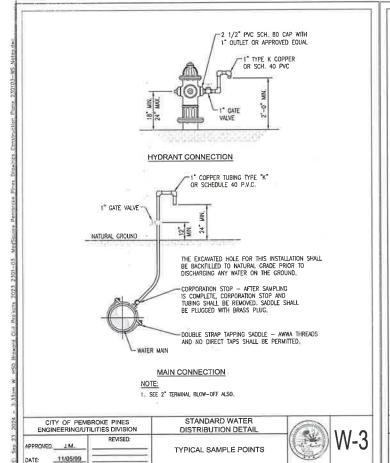

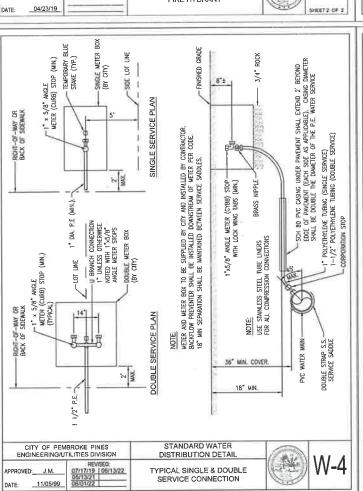

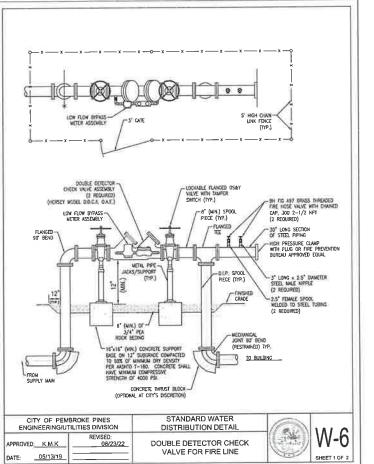

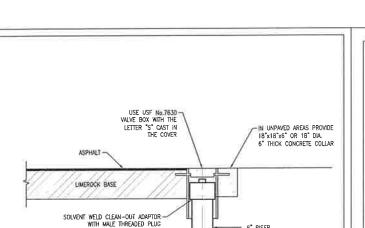

FLOW -


APPROVED: J.M.

11/05/99

1/23/23


- 1. ROUGH IN RISER TO 1 FOOT ABOVE FINISHED GRADE AND CAP, CUT BACK TO FINISHED GRADE DURING PAVING AND/OR PROJECT CLOSE-OUT
- 2. CONCRETE SHALL BE CLASS I PORTLAND CEMENT WITH A MINIMUM COMPRESSIVE STRENGTH OF 3,500 PSI AT 28 DAYS.

| | IBROKE PINES TILITIES DIVISION | STANDARD SANITARY SEWER DETAIL | |
|----------------|-----------------------------------|-----------------------------------|-----|
| APPROVED: J.M. | REVISED | CLEAN OUT | S-1 |

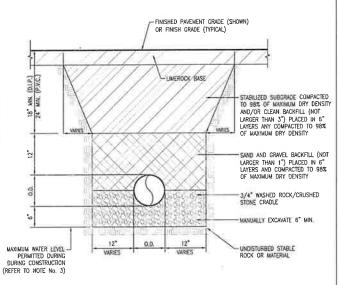

- 1. MAXIMUM DENSITY SHALL BE DETERMINED BY AASHTO T-180.
 2. MAXIMUM DEPIH TO BOTTOM OF PRESSURE MAINS SHALL NOT EXCEED SIX (6) FEET UNLESS OTHERWISE APPROVED BY THE CITY OF PEUBROKE PHES UTILITY DEPARTMENT.
 3. MAXIMUM WATER LEVEL IN TRENCH SHALL BE MAINTAINED AT BOTTOM OF "BEDDING MATERIAL" UNLESS SOI LAND WATER TABLE CONDITIONS DICKTE OTHERWISE. THEM AN ALTERNATE METHOD OF CONTROLLING THE WATER LEVEL IN THE TRENCH AND/OR ALTERNATE METHOD OF INSTALLATION IN "WET CONDITIONS" SHALL BE PROPOSED BY CONTRACTOR AND ENGINEER AND APPROVED BY CITY'S FIELD REPRESENTATIVE FOR FIELD USE.

| | IBROKE PINES | STANDARD GENERAL DETAIL | | ~ 4 |
|--------------|--------------|-------------------------|-----|------------|
| APPROVEDJ.M. | REVISED | WATER AND SEWER | 134 | G-1 |
| DATE: | 6/15/20 | TRENCH BACKFILL | | |

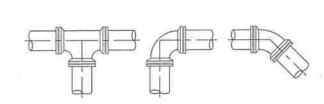

| TEE | æ | WYF |
|-----|---|-----|

45' & 22 1/2' BEND

| | RESTRA | INED PIPE | LENGTH | (LINEAL FEET) | |
|-----------|-----------|-----------|---------|---------------|-------------|
| PIPE SIZE | TEE & WYE | 30,BEND | 45°BEND | 22 1/2'BEND | 11 1/4'BEND |
| 6" | 27 | 27 | 16 | 9 | 5 |
| 8* | 34 | 34 | 20 | 11 | - 6 |
| 10" | 41 | 41 | 24 | 14 | 7 |
| 12" | 48 | 48 | 28 | 16 | 8 |
| 14 | 55 | 55 | 32 | 18 | 10 |
| 16" | 62 | 62 | 35 | 20 | 11 |
| 18" | 69 | 69 | 39 | 22 | 12 |
| 20" | 75 | 75 | 42 | 24 | 13 |
| 24" | 87 | 87 | 49 | 27 | 14 |
| 30" | 104 | 104 | 57 | 31 | 17 |
| 36" | 120 | 120 | 65 | 35 | 19 |
| 42" | 134 | 134 | 72 | 39 | 21 |
| 48" | 147 | 147 | 79 | 42 | 22 |
| 54" | 160 | 160 | 85 | 45 | 24 |

NOTE:

DATE:


G-4

THE FIGURES IN THIS TABLE ARE BASED ON 150 PSI TEST PRESSURE WITH 2.5 FEET OF COVER AND 2000 POUNDS PER SQUARE FOOT SOIL BEARING AGAINST UNDISTURBED TRENCH. A 20% SAFETY FACTOR HAS BEEN ADDED.


| CITY OF PEMB ENGINEERING/UTI | | STANDARD GENERAL DETAIL |
|---------------------------------|----------|-------------------------|
| APPROVED J.M. | REVISED: | RESTRAINED JOINTS |
| 11/05/00 | | RESTRAINED JOINTS |



G-2

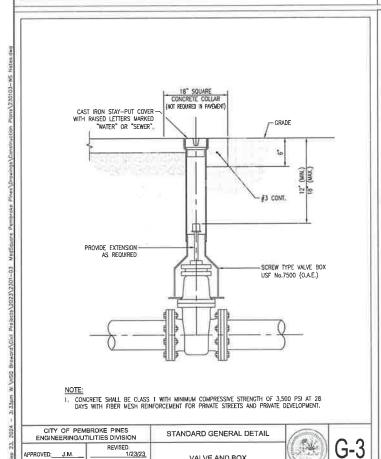


VALVE AND BOX

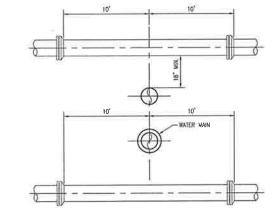

- A WATER MAIN SHOULD CROSS OVER PIPES WHEREVER POSSIBLE MAINTAINING A 36 INCH
 COVER FOR PVC, 30 INCH COVER FOR D.I.P. AND 18 INCH SEPARATION AS MINIMUMS.
- WHEREVER A WATER MAIN CROSSES UNDER A SEWER MAIN, OR CROSSES OVER WITH LESS
 THAN 18 INCHES VERTICAL SEPARATION, THEN D.I.P., SHALL BE USED FOR BOTH PIPES FOR A
 DISTANCE OF 20 FEET CENTERED ON CROSSING WITH NO JOINTS WITHIN 10 FEET OF THE
 ADDITIONAL OF THE CONTROL OF THE CONTROL
- 18 INCH SEPARATION SHOULD BE MAINTAINED BETWEEN ALL PIPES (STORM, SEWER, WATER)
 WHENEVER POSSIBLE, 12 INCHES IS THE ABSOLUTE MINIMUM SEPARATION WITH D.I.P. REQUIRED
 FOR ANY SEPARATION LESS THAN 18 INCHES,
- 4. MAINTAIN 10 FEET HORIZONTAL SEPARATION BETWEEN WATER AND SEWER AS A MINIMUM.
- 5. 3 FOOT HORIZONTAL CLEARANCE SHALL BE PROVIDED BETWEEN UTILITIES AND ANY OBSTRUCTIONS (CATCH BASINS, CONCRETE POLES, ETC.)
- 6. 5 FOOT HORIZONTAL CLEARANCE SHALL BE PROVIDED BETWEEN UTILITIES AND TREES.

| CITY OF PEMBROKE PIN ENGINEERING/UTILITIES DIVI | | |
|--|---------------------------------------|--|
| APPROVED: J.M. DATE: 11/05/99 | UTILITY CROSSING GENERAL REQUIREMENTS | |

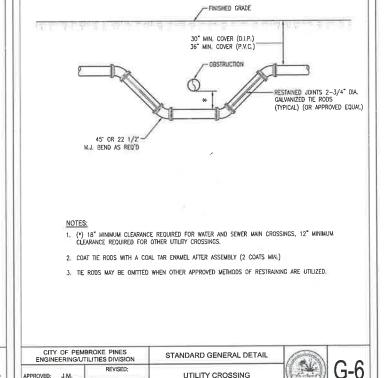



GROUP,

HSQ

DETAILS

WATER

06/23

JAL

кв


KEVIN A. BETANCOURT P.E. FLORIDA REGISTRATION NO. — 833


WS-4


PROJECT: 2301-03


SHEET:

Sunshine

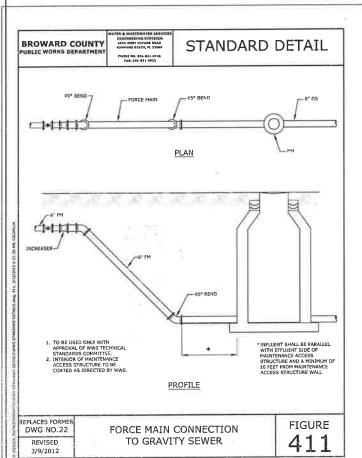


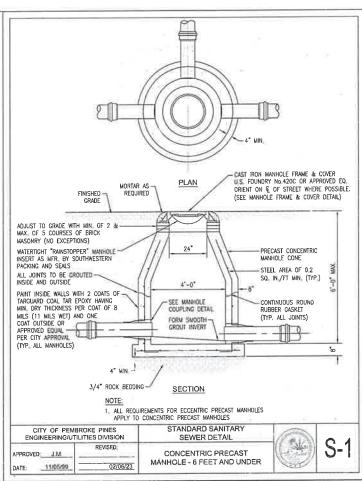


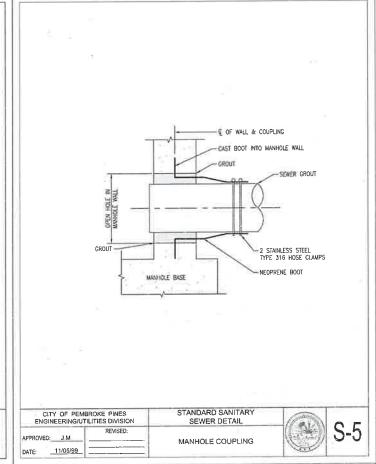

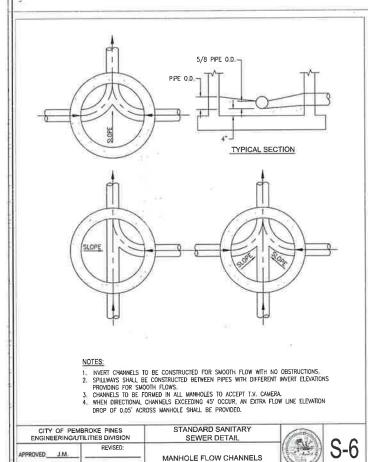

DATE: 11/05/99

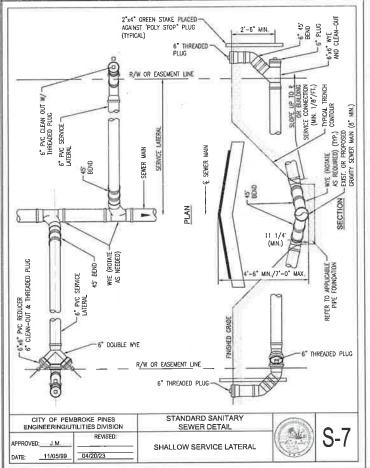

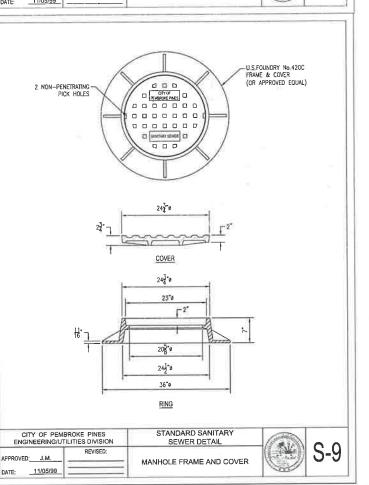







MEDSQUARE PEMBROKE PUNES SEC OF JOHNSON ST & NW 101ST AVE PEMBROKE PINES, FL

DETAILS

SEWER


AND


WATER,


| DATE: | 06/23 |
|---|-------|
| DESIGNED BY: | JAL |
| DRAWN BY: | MR |
| CHECKED BY: | КВ |
| .,,,,,,,,,,,,,,,,,,,,,,,,,,,,,,,,,,,,,, | |



PROJECT: 2301-03
SHEET: WS-5

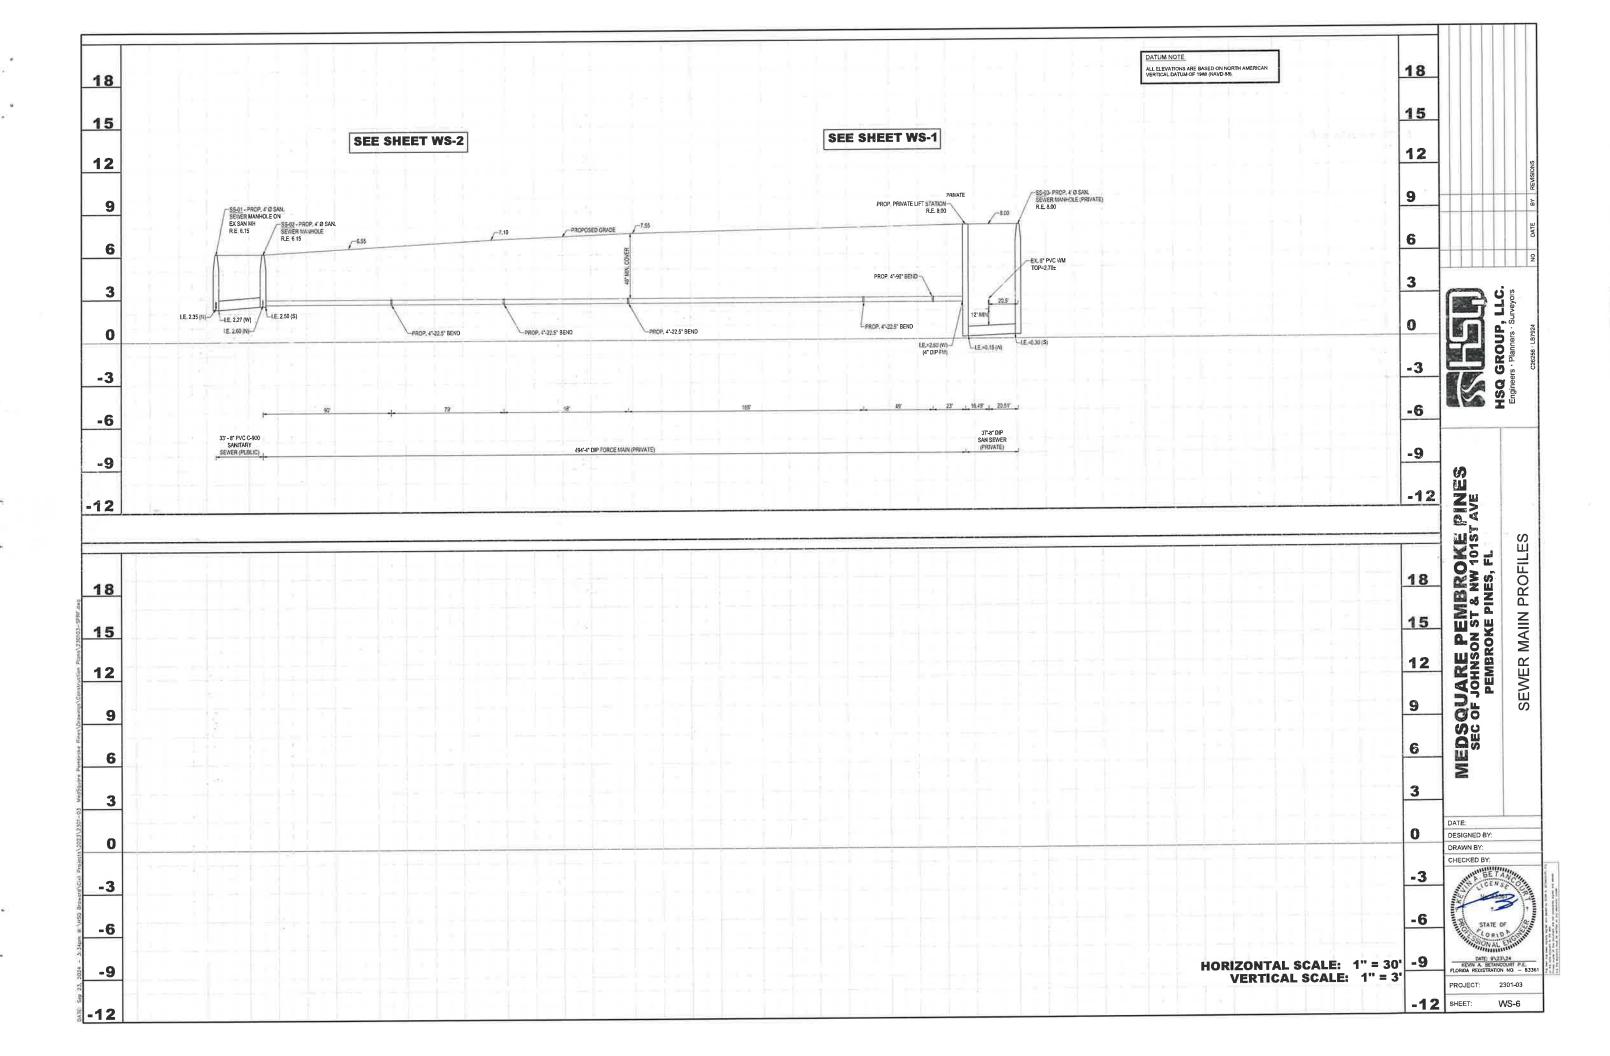

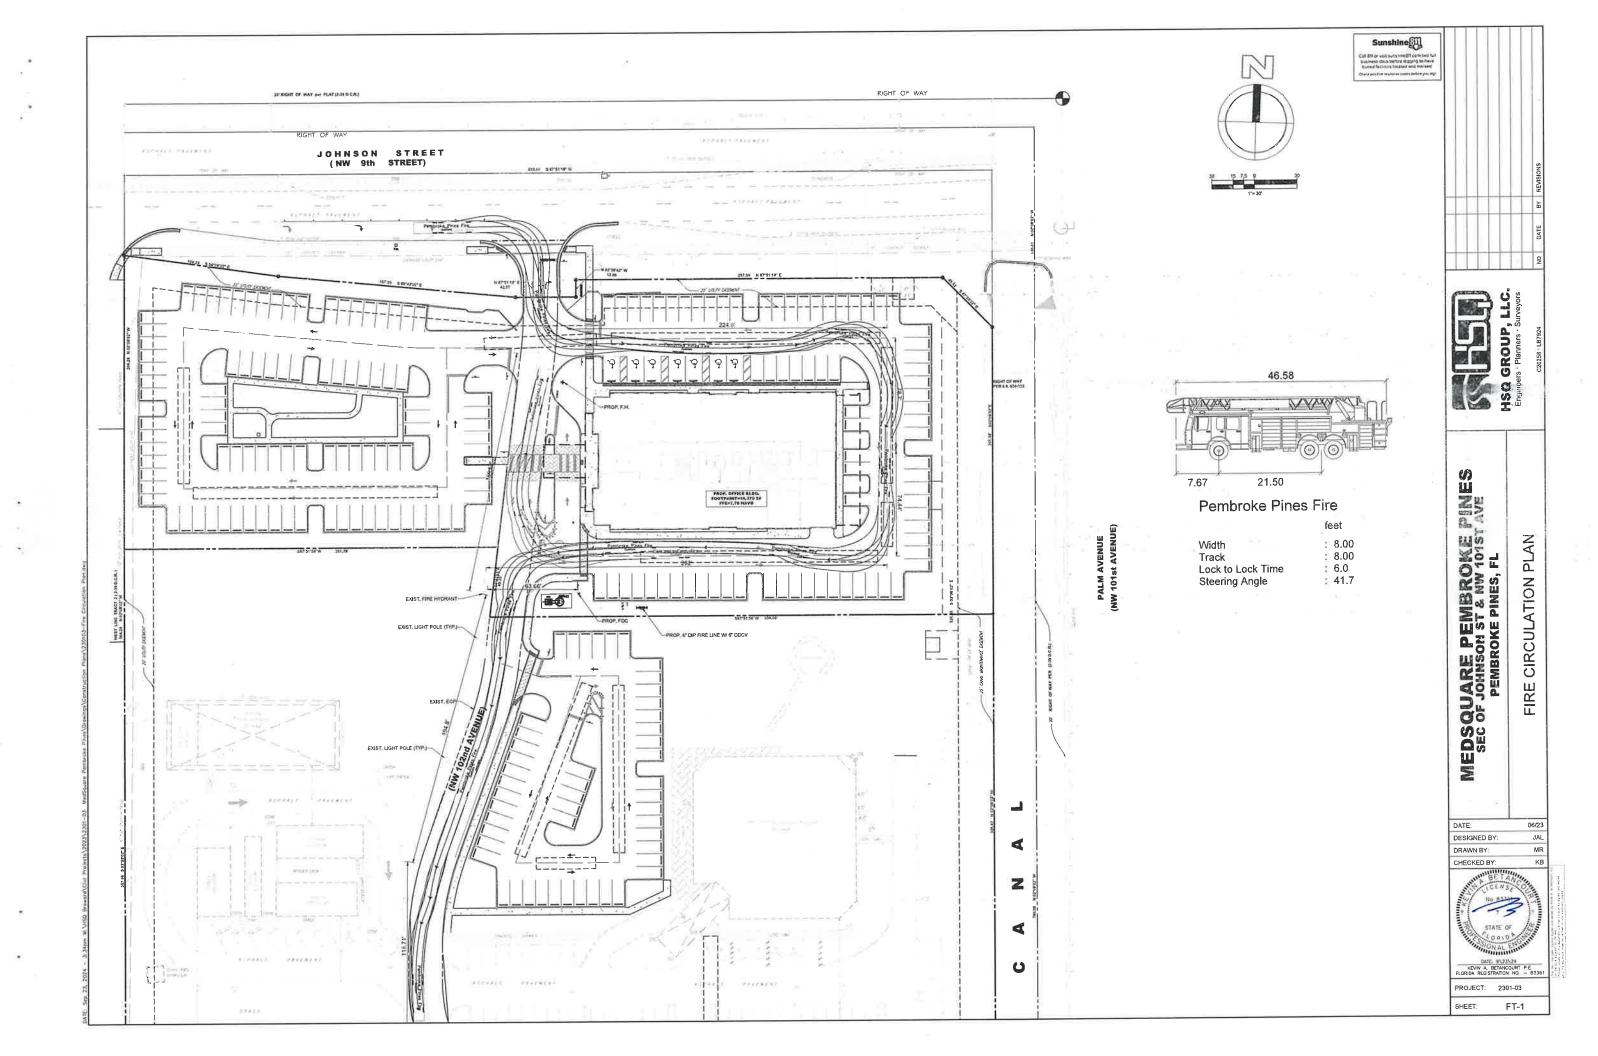

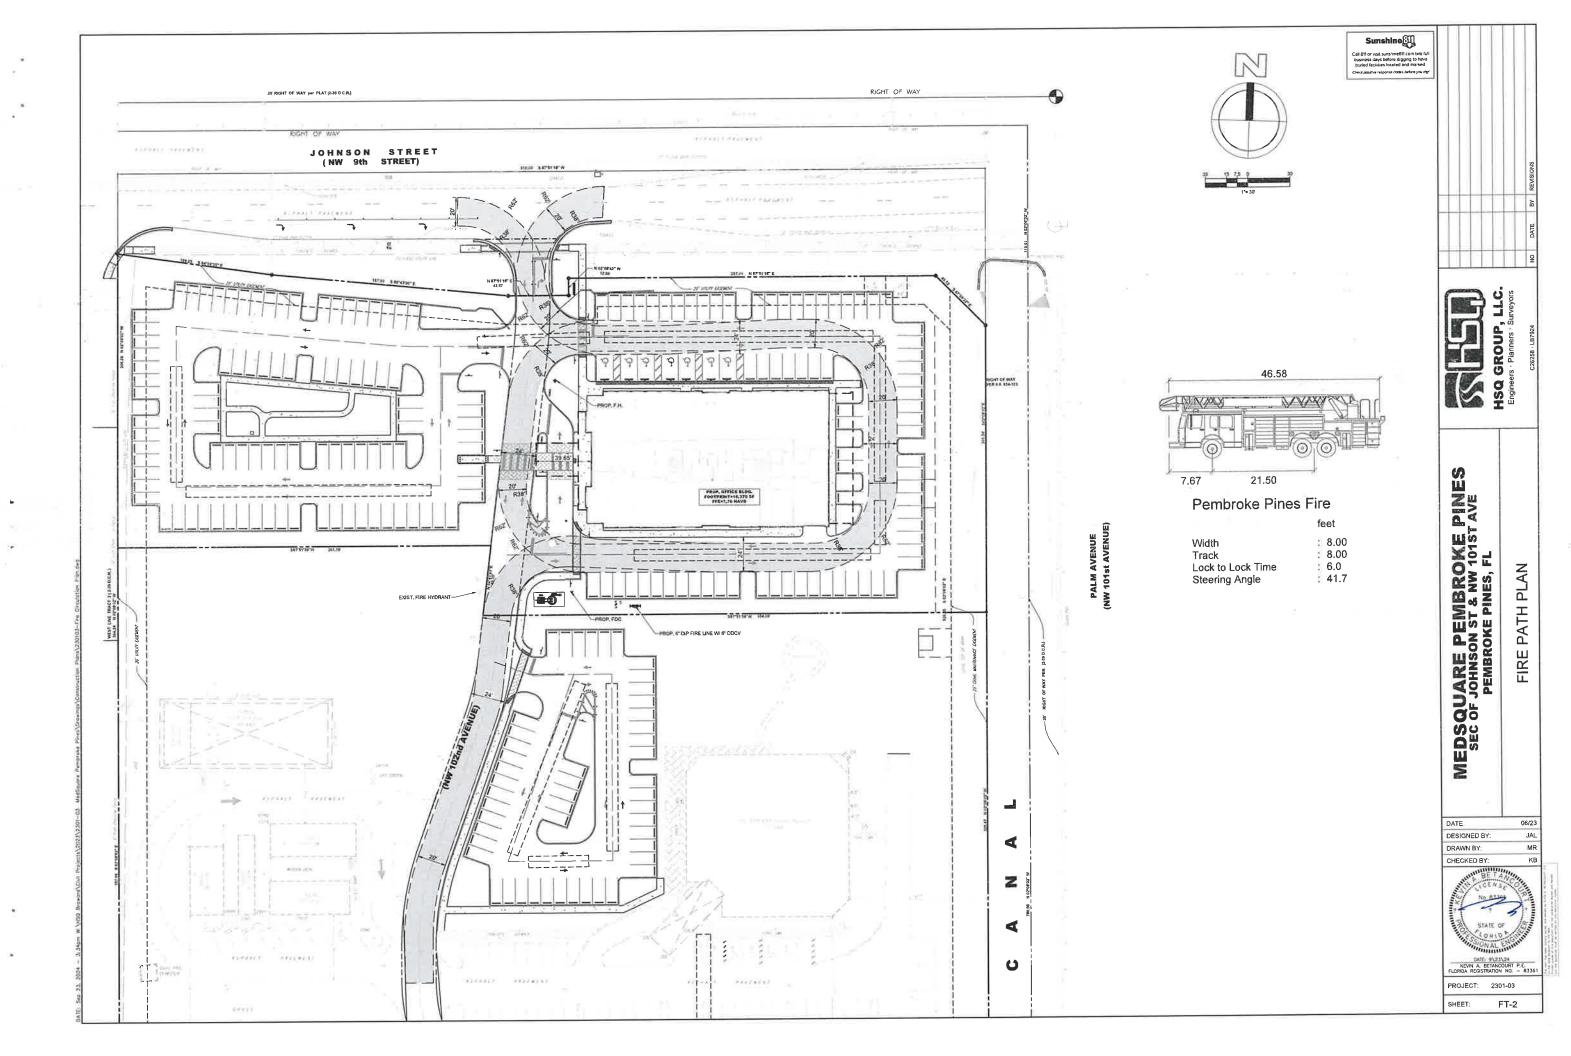

- 2. FIRE CODES IN EFFECT: FLORIDA FIRE PREVENTION CODE (FFPC) 6TH EDITION, EFFECTIVE DECEMBER 31, 2021 WITH BROWARD COUNTY AMENDMENTS, WHICH INCLUDES NFPA 101, 2021 EDITION, NFPA 1, 2021 EDITION, & STATE STATUTES, 2019 EDITION (ADOPTED REFERENCED PUBLICATIONS FOUND HEREIN.)
- 3, THE AHJ SHALL HAVE THE AUTHORITY TO REQUIRE AN ACCESS BOX(ES) TO BE INSTALLED IN AN ACCESSIBLE LOCATION WHERE ACCESS TO OR WITHIN A STRUCTURE OR AREA IS DIFFICULT BECAUSE OF SECURITY. THE ACCESS BOX(ES) SHALL BE OF AN APPROVED TYPE LISTED IN ACCORDANCE WITH UL 1037, A KNOX BOX SHALL BE PROVIDED ON ALL BUILDINGS THAT HAVE REQUIRED SPRINKLER SYSTEMS. STANDPIPES SYSTEMS OR FIRE ALARM SYSTEMS, PLEASE ORDER ON-LINE AT WWW.KNOXBOX.COM
- 4, APPROVED FIRE DEPARTMENT ACCESS ROADS SHALL BE PROVIDED FOR EVERY FACILITY, BUILDING, OR PORTION OF A BUILDING HEREAFTER CONSTRUCTION OR RELOCATED, NFPA-1:18.2.3,1.1
- A FIRE DEPARTMENT ACCESS ROADS SHALL CONSIST OF ROADWAY, FIRE LANES, PARKING LOT LANES, OR A COMBINATION THEREOF, NFPA-1:18,2,3,1,2
- B, FIRE LANES SHALL BE PROVIDED FOR ALL BUILDINGS WHICH ARE A SETBACK OF MORE THAN 150' FROM A PUBLIC ROADWAY, OR WHICH EXCEED 30' IN HEIGHT AND ARE SETBACK OVER 50' FROM A PUBLIC ROAD, FIRE LANES SHALL BE AT LEAST 20 FEET IN WIDTH WITH ROAD EDGE CLOSEST TO THE BUILDING AT LEAST TEN FEET FROM THE BUILDING, COPP CO 93,11 (B)
- 5. A FIRE DEPARTMENT ACCESS ROAD SHALL EXTEND TO WITHIN 50 FT. OF A SINGLE EXTERIOR DOOR THAT CAN BE OPENED FROM THE OUTSIDE AND THAT PROVIDES ACCESS TO THE INTERIOR OF THE
- FOR THE PURPOSES OF THIS SECTION, A SINGLE EXTERIOR DOOR SHALL BE IN COMPLIANCE WITH BCLCA F-101.2.2(J).
- A WHEN REQUIRED BY THE AHJ, ROADS(S) OR PARKING LOTS PROVIDING ACCESS TO MAIN ENTRANCE DOOR(S) SHALL BE CONSIDERED ACCESS ROADS AND SHALL COMPLY WITH THE REQUIREMENTS OF NFPA 1-18.2.3.4.1.1 AND NFPA 1-18.2.3.4.1.2 NFPA-1:18.2.3.2.1.2
- S. FIRE DEPARTMENT ACCESS ROADS SHALL BE PROVIDED SUCH THAT ANY PORTION OF THE FACILITY OR ANY PORTION OF AN EXTERIOR WALL OF THE FIRST STORY OF THE BUILDING IS LOCATED NOT MORE S, FIRE DEFAIT MENT ACCESS RUADS STALL BE PROVIDED SUCH THAT ANY PORTION OF THE PAULITY OR ANY PORTION OF AN EXTERIOR WALL OF THE HIRST STORY OF THE BUILDING IS LOCALED.
 THAN 150 FT. (450 FT. FOR SPRINKLERED BUILDINGS) FROM FIRE DEPARTMENT ACCESS ROADS AS MEASURED BY AN APPROVED ROUTE AROUND THE EXTERIOR OR THE BUILDING OR FACILITY.
 NFPA-1:182.32.2 AND NFPA-1:182.32.21
- A MORE THAN ONE FIRE DEPARTMENT ACCESS ROAD SHALL BE PROVIDED WHEN IT IS DETERMINED BY THE AHJ THAT ACCESS BY A SINGLE ROAD COULD BE IMPAIRED BY VEHICLE CONGESTION.
 CONDITION OF TERRAIN, CLIMATIC CONDITIONS, OR OTHER FACTORS THAT COULD LIMIT ACCESS, NFPA-1:18.2.3.3
- B, FIRE DEPARTMENT ACCESS ROADS FOR FIRE DEPARTMENT USE ONLY SHALL HAVE AN UNOBSTRUCTED WIDTH OF NOT LESS THAN 20FT, NFPA-1:18,2,3,4,1,1
- C.DRIVING LANES SHALL HAVE A MINIMUM CLEAR WIDTH OF 24 FEET FOR TWO-WAY TRAFFIC, 15 FEET FOR ONE-WAY TRAFFIC, COPP CO 154, 35 (5)
- FIRE DEPARTMENT ACCESS ROADS SHALL HAVE AN UNORSTRUCTED WIDTH ON NOT LESS THAN 20FT, NFPA-1:18.2.3.4.1.1
- 7. FIRE ACCESS ROADS SHALL BE A MINIMUM CENTERLINE TURNING RADIUS OF 50°, SHOW MIN, 38° INSIDE RADIUS AND MIN 62° OUTSIDE RADIUS THROUGHOUT AREA, SHOW A SHADED TRUCK ROUTE INCLUDING ENTERING AND LEAVING THE SITE WITH THE ABOVE TURNING RADIUS NUMERALS ON PLANS SHOWN THROUGHOUT.
- 8. THE REQUIRED WIDTH OF A FIRE DEPARTMENT ACCESS ROAD SHALL NOT BE OBSTRUCTED IN ANY MANNER, INCLUDING BY THE PARKING OF VEHICLES,
- 9, FIRE DEPARTMENT ACCESS ROADS SHALL HAVE AN UNOBSTRUCTED VERTICAL CLEARANCE OF NOT LESS THAN 13FT, 6IN, NFPA-1:18,2,3,4,1,2
- A THERE SHALL BE A 14' MINIMUM WIDTH AT LEVEL 6' TO 8' FROM ROADWAY TO ACCOMMODATE VEHICLE MIRRORS WHERE APPLICABLE,
- B. MINIMUM REQUIRED WIDTHS AND CLEARANCES ESTABLISHED UNDER 18.2.3.4 SHALL BE MAINTAINED AT ALL TIMES, NFPA 1-18.2.4.1.2
- 10, FIRE DEPARTMENT ACCESS ROADS SHALL BE DESIGNED AND MAINTAINED TO SUPPORT THE IMPOSED LOADS OF FIRE APPARATUS (WEIGHTING A MINIMUM OF 32 TONS) AND SHALL BE PROVIDED WITH AN ALL-WEATHER DRIVING SURFACE. NFPA-1:18.2.3.4.2
- 11, THE ANGLE OF APPROACH AND DEPARTURE FOR ANY MEANS OF THE FIRE DEPARTMENT ACCESS ROAD SHALL NOT EXCEED 1 FT DROP IN 20 FT OR DESIGN LIMITATIONS OF THE FIRE APPARATUS OF THE FIRE DEPARTMENT, AND SHALL BE SUBJECT TO APPROVAL BY THE AHJ, NFPA-1:18.2.3.4.6.2
- 12. FIRE DEPARTMENT ACCESS ROADS CONNECTING TO ROADWAYS SHALL BE PROVIDED WITH CURB CUTS EXTENDING AT LEAST 2 FT BEYOND EACH OF THE FIRE LANE, NFPA-1:18.2,3,4.6,3
- 13. THE DESIGN AND USE IF TRAFFIC CALMING DEVICES SHALL REQUIRE APPROVAL BY THE AHJ AND COPP ENGINEERING DEPARTMENT, NFPA-1:18.2.3.4.7
- 14. WHERE REQUIRED BY THE AHJ, APPROVED SIGNS, APPROVED ROADWAY SURFACE MARKING, OR OTHER APPROVED NOTICES SHALL BE PROVIDED AND PROHIBIT THE OBSTRUCTION THEREOF OR BOTH.
- A THE DESIGNATION OF FIRE LANES OR FIRE ZONES ON PRIVATE PROPERTY SHALL BE ACCOMPLISHED AS SPECIFIED BY THE CITY FIRE CHIEF OR A SUBORDINATE APPOINTED BY HIM TO PERFORM THIS DUTY, SIGNS SHALL BE POSTED DESIGNATING SUCH FIRE LANES OR ZONES, COPP CO 93,12
- B, FIRE LANES SHALL BE DESIGNATED BY YELLOW THERMOPLASTIC PAINT, STRIPING, OR MARKING OF CURBS AND ROADWAY BETWEEN EACH FIRE LANE; SIGN(S) SHALL BE PROVIDED.
- C.FIRE LANE SIGN(S) SHALL BE 18° BY 24°, SHALL BE MARKED WITH FREESTANDING SIGNS WITH THE WORDING 'NO PARKING FIRE LANE BY ORDER OF THE FIRE DEPARTMENT' OR SIMILAR WORDING.
 SUCH SIGNS SHALL BE 12 IN BY 18 IN WITH WHITE BACKGROUND AND RED LETTERS AND SHALL BE A MAXIMUM OF SEVEN FEET IN HEIGHT FROM THE ROADWAY TO BE THE BOTTOM PART OF THE SIGN.
 THE SIGNS SHALL BE WITHIN SIGHT OF THE TRAFFIC FLOW AND BE A MAXIMUM OF 60 FEET APART. NFPA-1:18.2.3,5,3
- 15, A WATER SUPPLY FOR FIRE PROTECTION, EITHER TEMPORARY OR PERMANENT, SHALL BE MADE AVAILABLE AS SOON AS COMBUSTIBLES MATERIAL ACCUMULATES, NFPA-1:16,4,3,1.1
- A, WHERE UNDERGROUND WATER MAINS AND HYDRANTS ARE TO BE PROVIDED, THEY SHALL BE INSTALLED, COMPLETED, AND IN SERVICE PRIOR TO COMMENCING CONSTRUCTION WORK ON ANY
- 6. AN APPROVED WATER SUPPLY CAPABLE OF SUPPLYING THE REQUIRED FIRE FLOW FOR FIRE PROTECTION SHALL BE PROVIDED TO ALL PREMISES UPON WHICH FACILITIES, BUILDINGS, OR PORTIONS OF 10. AN APPROVED WALER SUPPLY CAPABLE OF SOPPLITION THE REQUIRED FIRE FLOW FOR FIRE PROJECTION STRAIL BE INCOMED TO A WHITE PROBLEM SO, SOLD FOR THOSE OF BUILDINGS, B
- 17. THE NUMBER AND TYPE OF FIRE HYDRANT AND CONNECTIONS TO OTHER APPROVED WATER SUPPLIES SHALL BE CAPABLE OF DELIVERING THE REQUIRED FIRE FLOW AND SHALL BE PROVIDED AT APPROVED LOCATIONS, NFPA-1:18 5.1
- A FIRE HYDRANTS AND CONNECTION TO APPROVED WATER SUPPLIES MUST BE INSTALLED AND MAINTAINED IN A MANNER THAT ALLOWS THE FIRE DEPARTMENT TO ACCESS THE WATER SUPPLY POINT
- WITHOUT BEING DELAYED BY FENCES, SIGNS, AND OTHER OBSTRUCTIONS, NFPA-1:18 5.2 B. FIRE HYDRANTS SHALL BE LOCATED NOT MORE THAN 12 FT. FROM THE FIRE DEPARTMENT ACCESS ROAD, NFPA-1:18.5.1.6

BUILDING, NFPA-14 6.4.5.1 (2019 ED.)


- C. WHERE REQUIRED BY THE AHJ, FIRE HYDRANTS SUBJECT TO VEHICULAR DAMAGE SHALL BE PROTECTED UNLESS LOCATED WITHIN A PUBLIC RIGHT OF WAY. NFPA-1:18,5.8
- D.FIRE HYDRANTS SHALL BE MARKED WITH AN APPROVED REFLECTOR AFFIXED TO OR PROXIMATE TO THE FIRE HYDRANT WHERE REQUIRED BY THE AHJ, NFPA-1:18.5.10.1
- E, FIRE HYDRANTS IN ZONING CLASSIFICATIONS WITH LOWER RESIDENTIAL ZONING THAN R-3 SHALL BE INSTALLED ON A MINIMUM OF A SIX-INCH LOOPED WATER LINE IN CITY RIGHTS-OF-WAY OR EASEMENTS WITHIN 400 FEET OF THE ENTRANCE OF ANY FUTURE BUILDING AS MEASURED ALONG STREETS OR ALLEYS, COPP CO 93 (25 (A)
- F. FIRE HYDRANTS IN ZONING CLASSIFICATIONS R-3 AND ALL RESIDENTIAL CLASSIFICATIONS WITH GREATER DENSITY THAN R-3 SHALL BE INSTALLED ON A MINIMUM OF AN EIGHT- INCH LOOPED WATER LINE IN CITY RIGHTS-OF-WAY OR EASEMENTS AND WITHIN 300 FEET OF THE ENTRANCE OF ANY FUTURE BUILDING AS MEASURED ALONG STREETS OR ALLEYS. COPP CO 93.25 (8)
- G.FIRE HYDRANTS IN ALL COMMERCIALLY AND BUSINESS ZONED AREAS SHALL BE INSTALLED ON A MINIMUM OF AN EIGHT INCH LOOPED WATER LINE IN CITY RIGHTS-OF-WAY OR EASEMENTS AND SHALL NOT BE SPACED NOT FURTHER THAN 500 FEET APART AS MEASURED ALONG STREET OR ALLEYS, COPP CO 93.25 (C)
- H,NO TREE, BUSH, HEDGE, OR SHRUB, SHALL BE PLANTED WITHIN 15 FEET DIAMETER OF A HYDRANT AND LOCATED SUCH THAT THE HYDRANT SHALL BE FULLY VISIBLE FROM THE STREET, COPP CO 93.25
- I. NO TREE, BUSH, HEDGE, OR SHRUB, SHALL BE PLANTED WITHIN 15 FEET DIAMETER OF A HYDRANT AND LOCATED SUCH THAT THE HYDRANT SHALL BE FULLY VISIBLE FROM THE STREET, COPP CO 93.25
- J, IN EVERY CASE, AT LEAST TWO FIRE HYDRANTS SHALL BE WITHIN 400 FEET OF THE ENTRANCE OF ANY FUTURE BUILDING, AND BE SPACED 500 FEET APART THROUGHOUT.
- K, BUILDINGS WITH STANDPIPES/SPRINKLERS REQUIRE A FIRE HYDRANT WITHIN 100 FEET OF EACH STANDPIPE/SPRINKLER FIRE DEPARTMENT CONNECTION, COPP CO 93,25 (D) AND NFPA-14 6.4.5.4 (2016
- 18. FIRE DEPARTMENT CONNECTIONS SHOULD BE LOCATED AND ARRANGED SO THAT HOSE LINES CAN BE READILY AND CONVENIENTLY ATTACH WITHOUT INTERFERENCE FROM NEARBY OBJECTS, INCLUDING BUILDINGS, FENCES POSTS, OR OTHER DEPARTMENT CONNECTIONS, NFPA-14-6,4,5,1,1 (2019 ED.)
- A., FIRE DEPARTMENT CONNECTIONS SHALL BE VISIBLE AND RECOGNIZABLE FROM THE STREET OF NEAREST POINT OF FIRE DEPARTMENT APPARATUS ACCESSIBILITY OR ON THE STREET SIDE OF
- BLEACH FIRE DEPARTMENT CONNECTION TO SPRINKLER SYSTEMS SHALL BE DESIGNED BY A PERMANENT SIGN CONSTRUCTED OF WEATHER RESISTANT METAL OR RIGID PLASTIC MATERIALS WITH RED ADJACENT TO THE CONNECTION OF ON THE CONNECTION, SECURED WITH SUBSTANTIAL AND CORROSION RESISTANT FASTENERS. FOR EXAMPLE, AUTOSPKR, OPEN SPRINKLER, AND WHITE LETTERS, HAVING RAISED OR ENGRAVED LETTERS A LEAST 1 IN, IN HEIGHT ON PLATE OF FITTED READING SERVICE SIGN THAT SHALL BE ATTACHED TO THE EXTERIOR OF THE BUILDING ADJACENT TO THE CONNECTION OR ON THE CONNECTION, SECURED WITH SUBSTANTIAL AND CORROSION RESISTANT FASTENERS- FOR EXAMPLE, AUTOSPKR, OPEN SPRINKLER, AND STANDPIPE AS APPLICABLE, NFPA-14 6.4.5.2.1 (2019 ED.)
- C. THE FIRE DEPARTMENT CONNECTION SHOULD BE LOCATED NOT LESS THAN 18 IN, NOR MORE THAN 48 IN, ABOVE THE LEVEL OF THE ADJOINING GROUND, SIDEWALK, OR GRADE SURFACE,
- 19, THE POINT OF SERVICE FOR THE FIRE LINE MUST BE SHOWN AND LABELED ON THE WATER CIVIL SHEETS (THIS IS THE TIE IN WHERE THE WATER IS BEING USED EXCLUSIVELY FOR THE
- A ANY UNDERGROUND WORK COMMENCING AT THE POINT OF SERVICE SHALL BE PERFORMED BY A LICENSED CONTRACTOR AS SPECIFIED IN FSS 633.102.
- 20, BACKFLOW PREVENTION VALVES, MEANS SHALL BE PROVIDED DOWNSTREAM OF ALL BACKFLOW PREVENTION VALVES FOR FLOW TESTS AT SYSTEM DEMAND, NFPA-13 8.17.4.6.1
- 21. THE FULL FLOW TEST OF THE BACKFLOW PREVENTION VALVE CAN BE PERFORMED WITH A TEST HEADER OR OTHER CONNECTION DOWNSTREAM OF THE VALVE A BYPASS AROUND THE CHECK VALVE IN 1. THE FIRE DEPARTMENT CONNECTOR LINE WITH A CONTROL VALUE ON DE PERFORMED WHICH A 1831 DEPORT OR OTHER CONNECTION DOWNSTREAM OF THE WALVE. A BYPASS AROUND THE CHECK VA.
 THE FIRE DEPARTMENT CONNECTOR LINE WITH A CONTROL VALVE IN THE NORMALLY CLOSED POSITION CAN BE AN ACCEPTABLE ARRANGEMENT, WHEN FLOW TO A VISIBLE DRAIN CANNOT NOT BE
 ACCOMPLISHED, CLOSED LOOP FLOW CAN BE ACCEPTABLE IF A FLOWMETER OR SITE GLASS IS INCORPORATED INTO THE SYSTEM TO ENSURE FLOW, NFPA-13:A,8.17.4.5.1
- 22, ALL SUPPORT/SIGN POSTS SHALL CONFORM TO CURRENT BROWARD COUNTY TRAFFIC ENGINEERING DIVISION (BCTED) STANDARDS FOR SQUARE TUBE SIGN POSTS WITH EITHER A SQUARE ANCHOR OR TRIANGULAR SLIP BASE PER BOTED 'GROUND SIGN ASSEMBLY DETAILS'.
- 23. IN ALL NEW AND EXISTING BUILDINGS, MINIMUM RADIO SIGNAL STRENGTH FOR FIRE DEPARTMENT COMMUNICATIONS SHALL BE MAINTAINED AT A LEVEL DETERMINED BY THE AHJ. NFPA-1111.10.1
- THE OWNER'S REP OR GC SHALL CONDUCT A PRELIMINARY INITIAL ASSESSMENT TO DETERMINE IF THE MINIMUM RADIO SIGNALS STRENGTH FOR FIRE DEPARTMENT COMMUNICATION IS IN COMPLIANCE


PRIOR TO ANY TESTING, THE OCCUPANCY SHALL BE STRUCTURALLY COMPLETED WITH ALL INTERIOR PARTITIONS, WINDOWS AND DOORS INSTALLED. IT IS RECOMMENDED THAT THE STRUCTURE IS EQUIPPED WITH AN INFRASTRUCTURE TO ALLOW FOR INSTALLATION IF IT IS LATER DETERMINED THAT A BOA IS REQUIRED.

AN ASSESSMENT WILL BE CONDUCTED BY THE OWNER'S REP OR GC TO DETERMINE IF THE MINIMUM RADIO SIGNALS STRENGTH FOR FIRE DEPARTMENT COMMUNICATION IN THE OCCUPANCY IS IN COMPULANCE. IN ACCORDANCE WITH NFPA-1;11-10-1 AND NFPA-72:24-5-22-1 THROUGH NFPA-72:24-5-22-1 THROUGH NFPA-72:24-5-22-1 THROUGH NFPA-72:24-5-22-1 THROUGH NFPA-72:24-5-22-1 THROUGH NFPA-72-24-5-22-1 THROUGH NFPA-72-24-

RADIO COVERAGE SHALL BE PROVIDED THROUGHOUT THE BUILDING AS A PERCENTAGE OF FLOOR AREA AS SPECIFIED BELOW IN ACCORDANCE WITH NFPA-72:14.4.12.1.2 THROUGH NFPA-72:14.4.12.1.4 AND



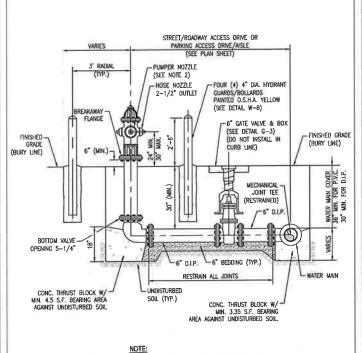

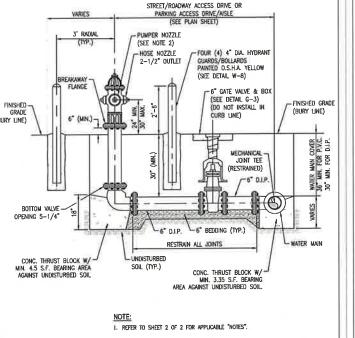

| CITY OF PEME ENGINEERING | | STANDARD WATER DISTRIBUTION DETAIL | | 141.4 |
|-----------------------------|----------|------------------------------------|---|--------------|
| ROVED: K.M.K. | REVISED: | FIRE HYDRANT | | 77-1 |
| 04/23/19 | | | - | SHEET 1 OF 2 |

- 1. FIRE HYDRANT SHALL BE 'AMERICAN DARLING' OR 'MUELLER' TYPE HAVING A MINIMUM 51/4" BOTTOM VALVE OPENING WITH A 41/2" PUMPER NOZZLE AND TWO (2) 21/2" HOSE NOZZLE OUTLETS. FIRE HYDRANT SHALL BE FACTORY PAINTED 0.S.H.A. YELLOW.
- 2. PUMPER NOZZLE OF THE FIRE HYDRANT TO FACE THE NEAREST ADJACENT STREET/ROADWAY, ACCESS DRIVE OR PARKING ACCESS DRIVE/AISLE AND A SQUE REFLECTIVE PAYEMENT MARKER (RPM) SHALL BE INSTALLED IN THE CENTER OF THE TRAVEL LANE OF THE NEAREST ADJACENT STREET/ROADHAY, ACCESS DRIVE OR PARKING
- FIRE HYDRANT BURY LINE TO MATCH ADJACENT STREET/ROADWAY CROWN ELEVATION, AS MAY BE APPLICABLE, AND THE CLEARANCE BETWEEN THE BOTTOM OF THE BOLTS OF THE BREAKAWAY FLANCE AND GRADE SHALL BE
- FIRE HYDRANTS SMALL BE LDCATED RELATIVE TO THE EDGE OF PAVEMENT FOR STREETS/ROADWAYS BASED UPON "LATERAL OFFSET" REQUIREMENTS PER CHAPTER 4, "ROADSIDE SAFETY", OF THE FLORIDA DEPARTMENT OF TRANSPORTATION ("F.D.C.T.") "PLANS PREPARATION MANALL", LIVEST EDITION.
- FIRE HYDRANTS SHALL BE LOCATED A MINIMUM OF 6' FROM THE EDGE OF THE PAYEMENT/FACE OF CURB OF AN ACCESS DRIVE OR PARKING ACCESS DRIVE/ASJEE AND A MINIMUM OF 5' FROM THE FACE OF CURB OF THE SIDE OF ANY TERMINAL OR INTERIOR PARKING LANDSCAPE ISLAND.
- HYDRANT GUARDS/BOLLARDS SHALL BE PROVIDED AROUND THE FIRE HYDRANT AS SHOWN WHEN THE FIRE HYDRANT IS LOCATED WITH SIX (6') FEET OF THE EDGE OF PAVEMENT OF A PUBLIC/PRIVATE STREET/ROADWAY ACCESS DRIVE, PARKING ACCESS DRIVE/AISLE OR TURNING RADIUS
- 7. A SEVEN AND HALF (7.5') FOOT RADIUS AROUND THE FIRE HYDRANT CLEAR OF ALL IMPROVEMENTS SHALL BE
- 8. ALL WATER MAIN PIPING FITTINGS BACK TO THE 'SUPPLY MAIN' SHALL BE CLASS 52 DUCTILE IRON PIPE (D.I.P.) AND FITTINGS/SPOOL PIECES SHALL BE CLASS 350 DUCTILE IRON
- 9. ALL D.I.P. AND FITTINGS/SPOOL PIECES SHALL BE RESTRAINED WITH 'MEGALUGS' OR CITY APPROVED EQUAL
- FIRE HYDRANT GATE VALVE SHALL BE INSTALLED AS CLOSE AS POSSIBLE TO THE "SUPPLY MAIN". SHOULD THE DISTANCE FROM THE "SUPPLY MAIN" TO THE FIRE HYDRANT LOCATION EXCEED TWENTY (20") FEET THEM A SECOND GATE VALVE IS REQUIRED TO BE INSTALLED AT THE HYDRANT.
- 11. DEPTH OF COVER TO THE TOP OF THE D.LP. WATER MAIN SHALL BE 30" MINIMUM.
- 12. FIRE HYDRANTS SHALL HAVE THEIR TOP COLOR CODED TO INDICATE THE 'FLOW CAPACITY' IN GALLONS PER MINUTE (CPM) OF FLOW, AS FOLLOWS

COLOR OF BONNET AND CAP 1,500 GPM OR GREATER 1.000 GPM OR GREATER GREEN

500 - 1.000 GPM ORANGI RED LESS THAN 500 GPM

STANDARD WATER CITY OF PEMBROKE PINES DISTRIBUTION DETAIL


REVISED


04/23/19








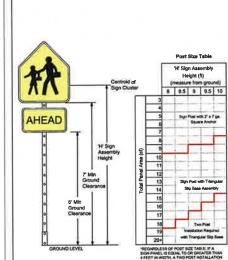

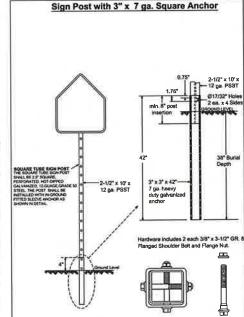

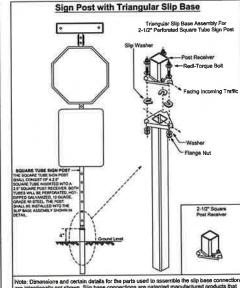

ot shown. Slip base connections are patented manufactured products that with NCHRP 350 crash test criteria. The base connection details are only or this plan to illustrate how the parts are assembled. The complete as d to withstand 150 mph Base Wind Speed per 2013 AASHTO Standar coural Supports for Highway Signs, Luminaires, and Traffic Signals, 6th

| | REVISIONS | - | 7 | 100 | A | JA | n | | PUBLIC WORKS DEP. | | |
|------------|--------------------------|-----|---|-----|----|----|-----|--------------|-------------------------------------|------------|--|
| DATE | DESCRIPTION | _ K | К | 0 | V١ | V/ | ١ĸ | D | TRAFFIC ENGINEERIN | G DIVISION | |
| 03-21-2017 | UPDATED POST SIZE | | | 17 | | ×. | 10 | - | DESIGN BY: YVES D'ANJOU, P.E. | SCALE: NTS | |
| 11-24-2020 | ADDED POST SIZE NOTE | | 0 | | C | U | JIN | \mathbf{H} | DRAWN BY: STEPHON RAMOUTAR | | |
| 02-05-2021 | UPDATED POST BASE HEIGHT | F | L | 0 | R | 1 | D | Ą | CHECKED BY: ANDREW SEBO, P.E., PTOE | | |

GROUND SIGN ASSEMBLY **DETAILS**

NO. 1 OF 1

SHEET






GROUP,


S $\overline{\Box}$ OCTOPIES OF JOHNSON ST & N
PEMBROKE PINE NOTES ACCESS

Ô,

EDS SEC

DATE: 06/23 DESIGNED BY JAL DRAWN BY CHECKED BY STATE OF PROJECT: 2301-03

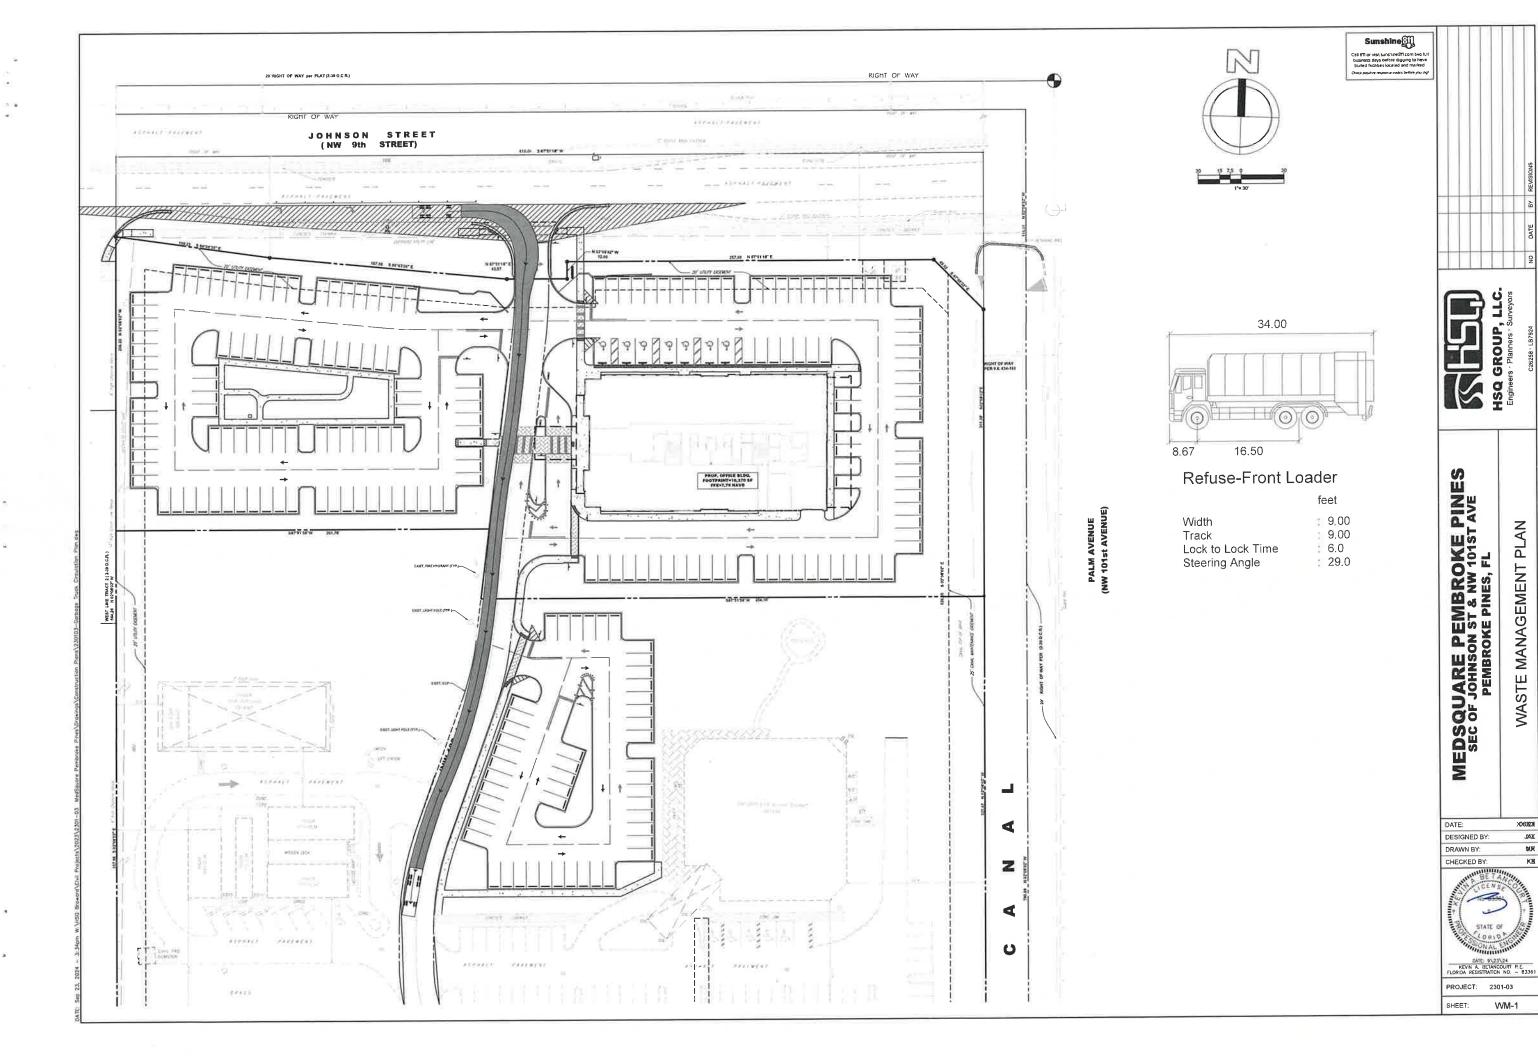

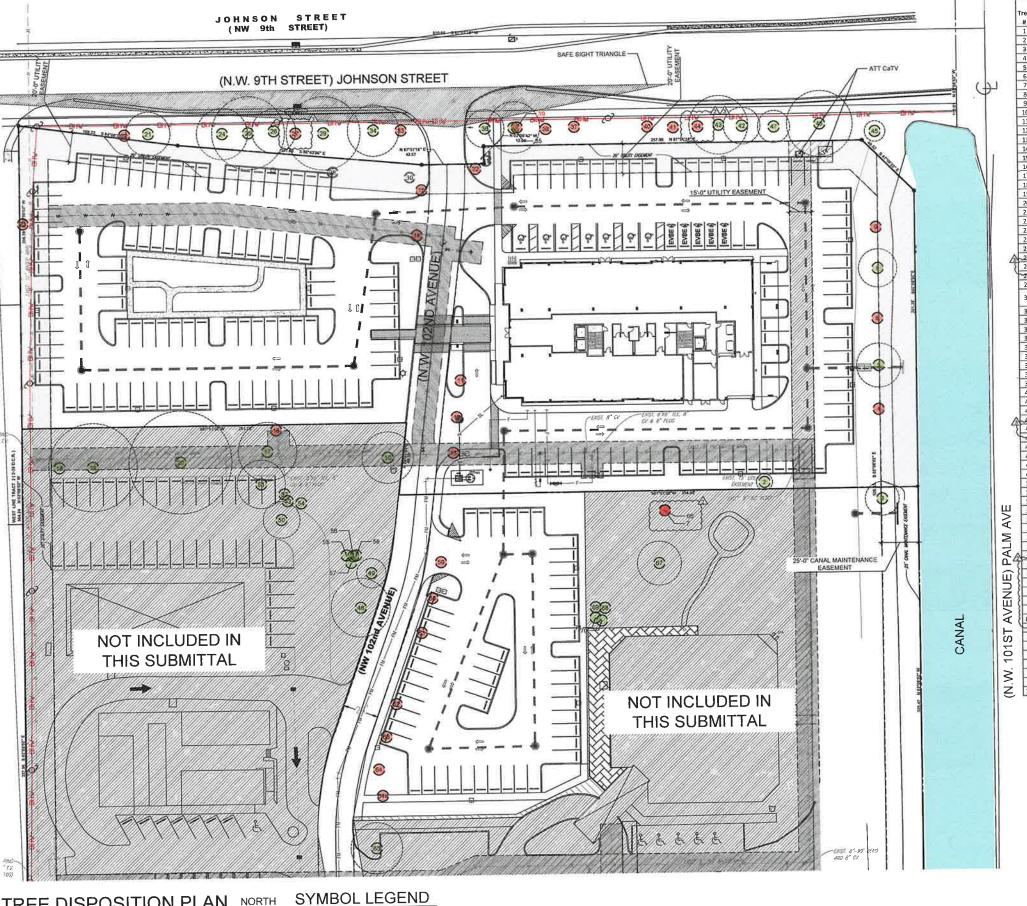

Canopy ((feet) Vodyetia bifurcata 3 Live Oak Ouercus virginiana Remain 5 Live Oak 6 Live Oak Quercus virginiana Live Oak Quercus virginiana Mahogany Remove Mahogany Swietenia mahago Mahogany Remove 15 missing Remain Outside Property Line 7 Australian Pine Casuarina equisetifolic Remain Outside Property Line 21 Mahogany wietenia mahagoni 22 Mahogany 24 Mahogany In Conflict witth Good 37CT 450A Relocate Swietenia mahagani Remain Outside Property Line
Remain Outside Property Line Poor Mahogany 39 Missing Swietenia mahagon 41 Mahogany 42 Mahogany 46 Mahogany Quercus virginiana Outside Property Line Quercus virginiano 51 Live Oak Casuarina equisetifol 53 Australian Pine Australian Pine Moderate Remain Outside Property Line 60 Mahogany Remove Remove 62 Mahogany Swietenia mahagan 63 Mahogany 64 Mahogany 64A Mahogany 45 Poor Outside Property Lin Ficus rubiginosi 66 Rusty Fig. Poor 23CT 30OA 12 Good Remain Outside Property L 68 Sabal Palm Sabal palmetto | 12 | 23C1 30OA | 12 | Good | Remain | Outside Property Line | 15 | 23C1 30OA | 12 | Good | Remain | Outside Property Line | 15 | 23C1 30OA | 12 | Good | Remain | Outside Property Line | 15 | 23C1 27OA | 12 | Good | Remain | Outside Property Line | 14 | 23C1 27OA | 12 | Good | Remain | Not Shown 69 Sabal Palm 70 Sabal Palm Sobal palmetto 71 Sabal Palm

800 NW 102nd Ave, Pembroke Pine

TREE DISPOSITION PLAN NORTH

Scale: 1" = 30'-0"



Tree to Relocate

Tree to Remove

Tree to Remain



03 14 2024 HAV 04 30 2024 MAY 08 23 2024 MAY

WITKIN HULTS

+ PARTNERS

307 south 21st averner hollywood, funda
phone; 954 223 5891 storainlie; 954 923 9899


www.wikindesign.com

Contemporary

+ The

MedSquare

PEMBROKE PINES, FLORIDA

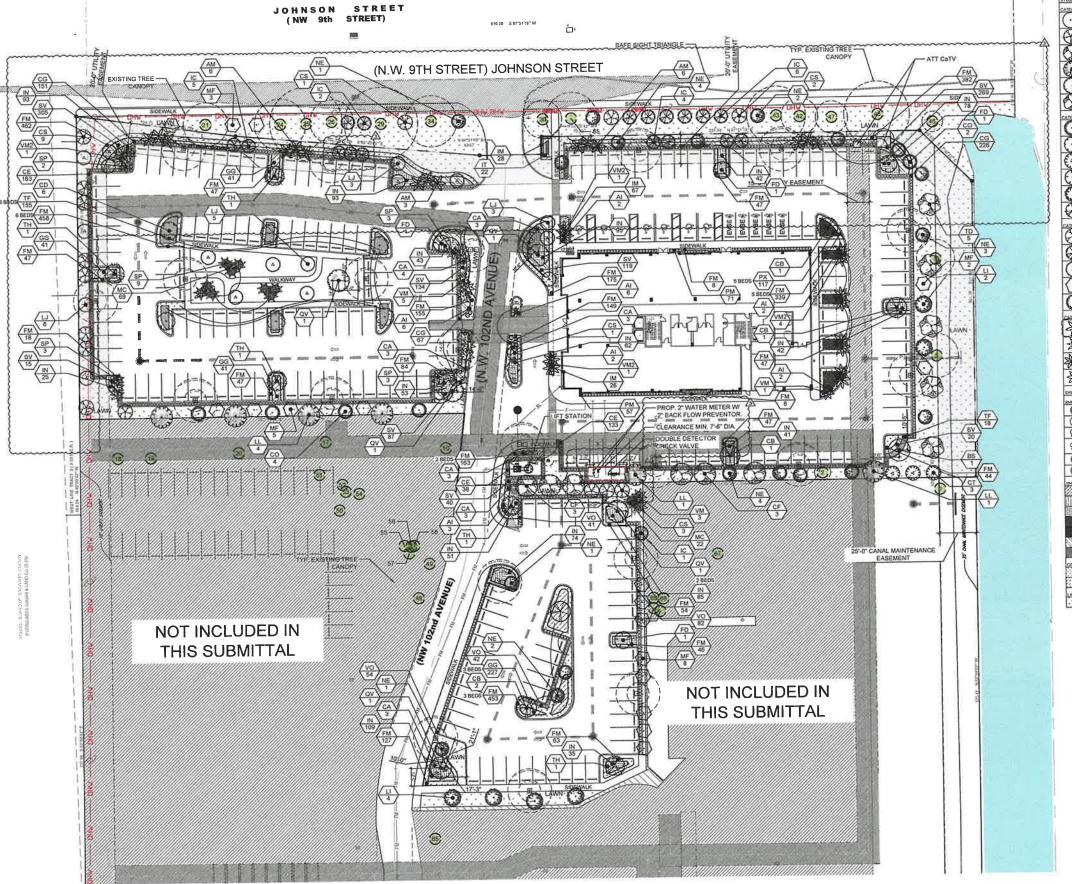

| | _ | | MEDSQUARE | 13.7E | MATINE | NOTES: | DROUGHT TOLERANCE | CT |
|--------------|-----------|-----------|---|------------------------------|-------------|---------------|-------------------|--------|
| | 2005 | | | | (| | | |
| | | HARDWOO | O TREES. Bursera simeruba | | YES | | HIGH | SCT |
| \cdot | BS | 1 | Gurrezo Limito | SE-SEPE 3" DBH | YES | | | |
| 3 | СВ | 5 | Calophyllum brasile rise Drazilen Beautyleid | HIND YE SPR 31 DOM | 100 | | MEDIUM | SCT |
| | CF | 4 | Cassia fishila Golden Shower Tree | и-16 нг х € SPR. Э* ОВН | YES | | MEDIUM | €CT. |
| | u. | G | Lysitiona fatoringus West Tamarind | 14'-16' HT, X 6' SPR 3" DBH. | YES | 4 | н сн | IFCT |
| $\hat{}$ | ωv | 5 | Quercus virginiana Livis Oak | 14-15 HT X 5 SPR 3" DBH. | YES | - | MEDIUM | SCT |
| B | ro | | Taxodum dir bihum Bud Cypress | INICHT XCERS FOR | YES | | MEDIUM/LOW | Ø C T. |
| ONLS. | - mark | | - AND ADDRESS OF THE | | (| | | |
| 4 | 000 | SA HAROME | Chrysophyllum olydforme | 12-14 HT X 4 SPR 25 DBH | YES | | MEDIUM | SCT |
| X | CD | 6 | Saturieari Coccolistas diversifolas | 12-14" HT X 4" SPR 2.5" OBH | YES | 4 | HIGHAMEDIUM | ест |
| | - | | Projects Plain Conductors subscribing County Congres Tree | 12-14 HT, X 4 SPR 25' 00H | YES | | HIGH | #CT |
| 1 | СТ | - | | T II | } | ls: | HIGHMEDIUM | FCT |
| ان | FO. | * | Figure decipients Japanissa Fern Trise | 12-14 HT X 4' SPR 2.5" DBH. | 110 | - | | FCT |
| 0 | u | 6 | Lágenstraemsa indica Crass Myrtie | 12-14" HT X 4" SPR 2.5" DBH | {\no | - | HIGH | - |
| (| TH | 5 | Tabebuia hebirophylla Pink Tabebuili | 12-14" HT X 4" SPR 2.5" DBH | 140 | ĸ. | MEDIUM | FCT |
| Attions | Y 2 - SMA | LHAROWO | OO TREES | | { | | | 1 |
| (4) | ÇS | 16 | Compositive erecture senorus (Sher Burtonwood) | 107-12 HT X 4 SPR 1 5" DBH | YES | ÷ | MEDIUM | ec. |
| X | ic. | 18 | Two continue Customs Helly | 10-12-16 X FEPR 15'00H | YES | | ндн | €C1 |
| $\dot{\cap}$ | u | 17 | Ligustrum japonicum Japanose Privet | 10-12 HT X 4 SPR 15" DBH | § NO | MULTI TRUNK | HIGH | 100 |
| ă | MF | 130 | Mycumbes fragrans Simpson's Stopper | 10-12 HT X 4' SPR. 1 5" DBH | YES | | нсн | 15 C T |
| | NE. | 18 | Nuronha emarghasa Madagancar Olive | 10-12 HT. X 4' SPR. 1 5" D6H | 140 | | HIGH | (FC1 |
| V | - | | Musiganca: Unive | | -1 | 1 | | |
| AUG | 400 | 128H5 | _ | | 4- | - | | ~ |
| * | AM | 15 | Agonatia mentilii Christmas Palm | 14 OA HT | 31" | | MEDIUM | B.C. |
| 验 | SP | 20 | Şabal palmetto Sabal Palm | 20 OA HT 6 GW | YES | | MEDIUM/LOW | 6.C. |
| WK. | VM2 | 7. | Visiona mongore ryzna 'Divisir' Mongomery Palm | 70" OA HT MIN | 140 | STAGGERED HTS | MEDIUM | g C |
| 24.3 | - VM | 9. | Ventrus montgomeryanta | 20 OAHT | NO | + | MEDIUM | G.C. |
| SW. | CODE | gry | Murcomery Palm BOTANICAL / COMMON NAME | 9/75 | Sharing | NOTES | DROUGHT TOLERANC | |
| cho lac | | | | | } | | | _ |
| 0 | N | 23 | According enperal 6 inpend Districted | 16" HT X 36" SPR | {\no | 6 | MEDIUM | + |
| 0 | 120 | 444 | Clusta guitatera | 24" HT X 24" SPR / 24" O C. | YES | | нівн | _ |
| 3 | CE | 354 | Constraints electus | 36" HT. X 24" SPR / 24" O.C. | YES | 4 | HIGH | |
| 88 | CA | 72 | Critum augustum 'Queen Emma' Queen Emma Critum Lify | 36" HT, X 36" SPR. | 110 | | MEDIUM/LOW | |
| 0 | PIA | 128 | Podocepus merriphytus Max Mais Yew Podocepus | 5 HT X 30" SPR / 24" O.C. | { 140 | | MEDIUM | |
| Ŏ | vo | 219 | Voturnum obsentum Water's Vibertum | 24" HT X 24" SPR / 24" O C. | YES | 1 | MEDIUM | |
| 13-10(10 | ADEAG | 1 | Gelprima gracio | 18" HT X 16" SPR / 16" O.C. | 1110 | L | MEDIUM | |
| | GG | 350 | Thryalts Ixora tahvanensis | TENT X TE SPE / NOC | 3 100 | 1 | HIGH | _ |
| ШШ | 117 | 22 | Dwarf brora | THE CONTRACT OF STREET | (NO | | HIGH | + |
| | iii in | 1,021 | Nora Grani Izora | TENT X IF SPR / IF GC | | | HIGH | - |
| 711 | WC. | 31 | Park Multip Circus | 24" HT X 24" SPR / 24" OC | YES | + | MEDIUM | - |
| The state of | Þχ | er. | Yanadu (*13dmilina Scrience a Sumare Torrette | INTERNITATION | | | | +- |
| 1111 | SV | ties | Variegasist factorities Variegasist factorities Espeacum fondana | UPHT X 1F SPR / NF OC | | | HIGH | + |
| 188 | TF | 173 | Drightsourn Rondona Dright Foreshatzture Come | 24"HT, X 24"SPR /24"OC | YES | | HIGH | |
| GROUN | D COMPE | _ | View memories | 1001 W 401 AND 1471 A | NO. | _ | Індн | _ |
| | FM | 3,470 | Creen Island from Ipomosa a Maganta Marquenta Seed Post to Vine | 15" HT, X 15" SPR. / 15" O.C | 110 | FULL | MEDIUM | - |
| 333 | M . | 121 | Marquenta Sweet Post to Vine | 15°0 C. | 3/140 | J-u. | Justin 1 | _1_ |
| LAWN | | _ | T | - | -6- | T | IMEDIUM | |
| | LAWN | 2 411 \$ | therespectum second electric 52. Augustine Crisis | SOLID EVEN 500 | 1110 | | IMECUTIN | حات |

| City of Pembroke Pines Landscape Code Requirements | DIMENSIONS | REQUIRED | PROP |
|--|------------|----------|------------|
| SEC 155.631 Meet minimum bufferyard requirements. | 11/1/ | ///// | 177 |
| Zoning: Professional Office Land User Office Park | 11111 | 11111 | 17 |
| SEC 155.661 (G) Trees in excess of five shall have no more than 20% of a single species. | | 148 | 1 |
| (a) 20% of required trees most 14-16" H with 3" diameter at breast height. | 444 | 7777 | 1// |
| b) 20% of required trees meet 12-14" H with 2" diameter at breast height. b) 60% of required trees required meet 155 664 (M) | 7/// | 30 88 | 3 |
| SEC 155.661 (I) Landscape Adjacent to Public Right of Ways - All Properties. | 11/1/ | //// | Z |
| Johnson St + Falm Are [CI] + and East Buffer: One tree for each 50 lineal feet or fraction thereof, or one tree for every 250 square feet. | 1,097 If | 22 | |
| SEC 155-661 (I) Landscaping Adjacent to Abutting Properties - All Properties | 11/1/ | //// | X |
| West Buffer a South Buffer: The required number of trees shall be calculated as one tree provided for every 50 lineal feet or fractional part thereof. | 872 W | 18 | _ |
| SEC. 155.662 (C) Minimum Landscape Requirements for Non-Residential Properties. | | | 1// |
| 1. For non-residential properties the planting requirement shall be calculated on the | 11/1/ | 1//// | χ_{Z} |
| following basis; (a) One there every 5,000 square feet of gross area. (b) Ten should every 5,000 square feet of gross area. | 192.802 sf | 390 | 3 |
| SEC. 155.663 (F) Interior parking and paved area landscaping. | 1//// | 11111 | 17 |
| Parking lots shall comply with the following minimum requirements: | 1//// | 1//// | W |
| 1. One tree: (a) Every five parking spaces; and | 231 spaces | 46 | # |
| (a) Every 100 square feet of interior landscaping; 3. One hundred square feet of landscaping every ten parking spaces over 50 spaces; | 2 300 st | 1777 | 1 |
| 4. One square foot of tandicaping: (a) (very 100 square feet of paved areas up to 50,000 square feet; and 10) Every 200 square feet of paved areas up to 50,000 square feet; and 10) Every 200 square feet of paved areas (a) | | | 1/2 |



MedSquare + The Contemporary Pembroke PINES, FLORIDA






symbol to show on landscape plan as a relocated tree





SYMBOL LEGEND

Tree to Remain

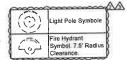

PER LDC SEC. 155.863 (E):
INDIVIDUAL INTERIOR PARKING LOT
AREAS SHALL BE A MINIMUM OF 100
SQUARE FEET TOTAL ADEQUATELY
LANDSCAPED WITH SHRUBS,
GROUNDCOVER, OR OTHER
AUTHORIZED LANDSCAPE MATERIAL
NOT TO EXCEED 24 INCHES IN HEIGHT
IN ADDITION TO REQUIREMENTS
LISTED BELOW. HEDGES INSTALLED
WITHIN INTERIOR PARKING ISLAND
ARE REQUIRED TO BE INSTALLED AND
MAINTAINED AT 24 INCHES, DUE TO
LINE OF SIGHT CONFLICTS.

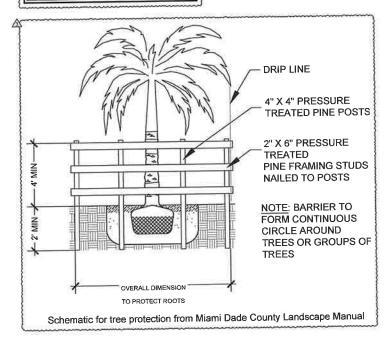

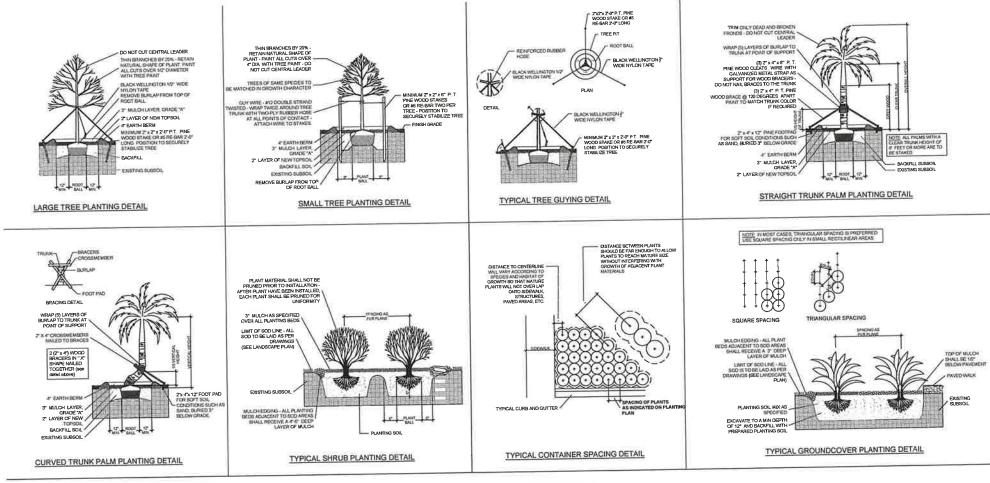

PLANTING NOTES:

- -All plant material is to be Florida Number 1 or better pursuant to the Florida Department of Agriculture's Grades and
- -All plants are to be top dressed with a minimum 3" layer of Melaleuca mulch, Eucalyptus mulch or equal.
- -Planting plans shall take precedence over plant list in case of discrepancies.
- -No changes are to be made without the prior consent of the Landscape Architect and Owner. Additions and or deletions to the plant material must be approved by the project engineer.
- -Landscape Contractor is responsible for providing their own square footage takeoffs and field verification for 100% sod coverage for all areas specified.
- All landscape areas are to be provided with automatic sprinkler system which provide 100% coverage, and 50% overlan.
- As per ANSI 300 standards, mulch shall not be placed against tree trunks or cover the root flares. Mulch shall be applied and maintained with at least 6-inches of diameter clearance, free of mulch at the base of the tree trunk.
- Trees are to be planted within parking islands after soil is brought up to grade. Deeply set root balls are not acceptable.
- Planting soil for topsoil and backfill shall be 50/50 mix, nematode free. Planting soil for annual beds to be comprised of 50% Canadian peat moss, 25% sait free coarse sand and 25% Aerolite.
- Tree and shrub pits will be supplemented with "Agriform Pells", 21 gram size with a 20-10-5 analysis, or substitute application accepted by Landscape Architect. Deliver in manufacturer's standard containers showing weight, analysis and name of manufacturer.

SOD NOTES:

- -Sod is to be grade "A" weed free.
- -All areas marked "LAWN" shall be solid sodded with St. Augustine 'Floratam' solid sod. See limit on plan. All areas marked 'Bahia Grass' shall be solid sodded with Paspalum.
- -Provide a 2" deep blanket of planting soil as described in planting notes on this sheet. Prior to planting, remove stones, sticks, etc. from the sub soil surface. Excavate existing non-conforming soil as required so that the finish grade of sod is flush with adjacent pavement or top of curb as well as adjacent sod in the case of sod patching.
- -Place sod on moistened soil, with edges tightly butted, in staggered rows at right angles to slopes.
- -Keep edge of sod bed a minimum of 18" away from groundcover beds and 24" away from edge of shrub beds and 36" away from trees, measured from center of plant.
- -Sod Shall be watered immediatley after installation to uniformily wet the soil to at least 2" below the bottom of the sod
- -Excavate and remove excess soil so top of sod is flush with top of curb or adjacent pavement or adjacent existing sod.

GENERAL NOTES:

- -The Landscape Contractor is to locate and verify all underground and overhead utilities prior to beginning work. Contact proper utility companies and / or General Contractor prior to digging for field verification. The Owner and the Landscape Architect shall not be responsible for any damages to utility or irrigation lines (see Roadway Plans for more utility notes).
- -Landscape Contractor is to verify all current drawings and check for discrepancies and bring to the attention of the Landscape Architect prior to commencing with the work.
- -All unattended and unplanted tree pits are to be properly barricaded and flagged during installation.
- -All planting plans are issued as directives for site layout. Any deviations, site changes, etcetera are to be brought to the attention of the Landscape Architect for clarification prior to installation.



MedSquare + The Contemporary
PEMBROKE PINES, FLORIDA
JANDSCAPE DETAILS

Revisions: Date: By:

Inter-constitution 0.112021 MMX.

Total Community 0.112021 MMX.

Total




Date: 12/21/2023
Scale: See Left
Drawn by: DA
Sheet No:

L-2
Cad Id: 2023-035

Drawing: Landscape Details

Exterior Sign

TYPE: Illuminated Reverse Channel Letters

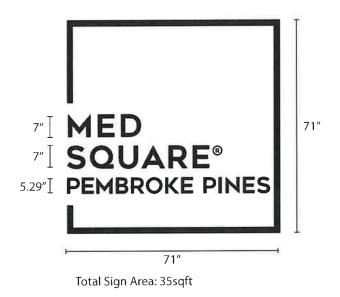



NIGHT VIEW, BACKLIT ILLUMINATION



01 North Elevation

THE DESIGN CONTENT MATERIAL ATTACHED IS THE SOLE PROPERTY OF ORION VISUAL, INC. THE DESIGN MATERIAL MAY NOT BE USED WITHOUT EXPRESSED WRITTEN CONSENT OF ORION VISUAL, INC.

PLEASE CAREFULLY REVIEW THIS PROOF FOR CORRECT COPY, SPELLING AND COLOR THIS PROOF IS INTENDED FOR A VISUALIZATION REFERENCE ONLY AND COLORS MAY LOOK DIFFERENT IN THE FINAL PRODUCT THAN WHAT IS PRESENTED ON THE SCREEN, PROOFS AND VISUAL REPRESENTATION IS NOT TO SCALE, PLEASE REFER TO CALLED OUT MEASUREMENTS FOR FINAL SIZES.

PRODUCTION WILL BEGIN ONCE THE PROOF HAS BEEN APPROVED. WE ARE NOT RESPONSIBLE FOR UNDETECTED ERRORS IN APPROVED PROOFS, ALL CUSTOM ORDERS ARE FINAL AND NON-RETURNABLE. CLIENT ACKNOWLEDGES RESPONSIBILITY WHEN SIGNING.


| | - 1 | OC |
|---------------------|---------|----|
| DATE CREATED: | 3-11-24 | |
| SALES REP: | GABRIEL | |
| SURVEYED BY: | PLANS | |
| TEMPLATE BY: | N/A | |
| DESIGNED BY: | EV | |
| PROOF BY: | EV | |
| | | |

| PROJECT: | AJP VENTURES-MEDSQUARE PEMBROKE PINES EXTERIOR AND MONUMENT SIGN | | REVISIONS |
|-----------|--|----------|-----------|
| ADDRESS: | | <u> </u> | <u> </u> |
| | Print: Signature: | <u>A</u> | <u> </u> |
| □ Revisio | | <u> </u> | <u> </u> |



Exterior Sign

TYPE: Illuminated Reverse Channel Letters

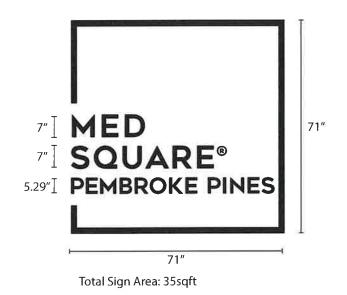



NIGHT VEW, BACKLIT ILLUMINATION



THE DESIGN CONTENT MATERIAL ATTACHED IS THE SOLE PROPERTY OF ORION VISUAL, INC. THE DESIGN MATERIAL MAY NOT BE USED WITHOUT EXPRESSED WRITTEN CONSENT OF ORION VISUAL, INC.

PLEASE CAREFULLY REVIEW THIS PROOF FOR CORRECT COPY, SPELLING AND COLOR. THIS PROOF IS INTENDED FOR A VISUALIZATION REFERENCE ONLY AND COLORS MAY LOOK DIFFERENT IN THE FINAL PRODUCT THAN WHAT IS PRESENTED ON THE SCREEN. PROOFS AND VISUAL REPRESENTATION IS NOT TO SCALE. PLEASE REFER TO CALLED OUT MEASUREMENTS FOR FINAL SIZES.

PRODUCTION WILL BEGIN ONCE THE PROOF HAS BEEN APPROVED. WE ARE NOT RESPONSIBLE FOR UNDETECTED ERRORS IN APPROVED PROOFS. ALL CUSTOM ORDERS ARE FINAL AND NON-RETURNABLE. CLIENT ACKNOWLEDGES RESPONSIBILITY WHEN SIGNING.

| I | | | OC |
|---|---------------------|---------|----|
| | DATE CREATED: | 3-11-24 | , |
| | SALES REP: | GABRIEL | |
| | SURVEYED BY: | PLANS | |
| | TEMPLATE BY: | N/A | |
| | DESIGNED BY: | EV | |
| | PROOF BY: | EV | |


| PROJECT: | AJP VENTURES-MEDSQUARE PEMBROKE PINES EXTERIOR AND MONUMENT SIGN | REVISIONS | |
|----------|--|-------------------|----------|
| ADDRESS: | | <u> \$ 9-3-24</u> | |
| | Print: Signature: | <u>A</u> 9-11-24 | <u>-</u> |
| | | <u>A</u> <u>A</u> | _ |




Exterior Sign

TYPE: Illuminated Monument Sign

Total Sign Area: 23.6sqft Landscaping around Sign provided for and detailed in Landscape Plans

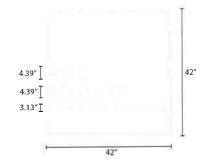

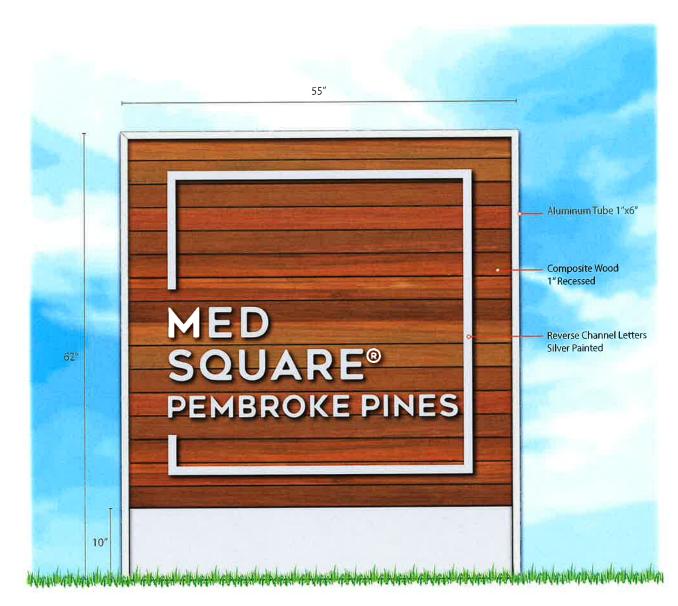



NIGHT VIEW

THE DESIGN CONTENT MATERIAL ATTACHED IS THE SOLE PROPERTY OF ORION VISUAL, INC. THE DESIGN MATERIAL MAY NOT BE USED WITHOUT EXPRESSED WRITTEN CONSENT OF ORION VISUAL, INC.

PLEASE CAREFULLY REVIEW THIS PROOF FOR CORRECT COPY, SPELLING AND COLOR. THIS PROOF IS INTENDED FOR A VISUALIZATION REFERENCE ONLY AND COLORS MAY LOOK DIFFERENT IN THE FINAL PRODUCT THAN WHAT IS PRESENTED ON THE SCREEN. PROOFS AND VISUAL REPRESENTATION IS NOT TO SCALE, PLEASE REFER TO CALLED OUT MEASUREMENTS FOR FINAL SIZES.

PRODUCTION WILL BEGIN ONCE THE PROOF HAS BEEN APPROVED. WE ARE NOT RESPONSIBLE FOR UNDETECTED ERRORS IN APPROVED PROOFS. ALL CUSTOM ORDERS ARE FINAL AND NON-RETURNABLE. CLIENT ACKNOWLEDGES RESPONSIBILITY WHEN SIGNING.

| | | 1 | QC |
|---|---------------|------------------|----|
| 1 | DATE CREATED: | 3-11 - 24 | |
| | SALES REP: | GABRIEL | |
| | SURVEYED BY: | PLANS | |
| | TEMPLATE BY: | N/A | |
| | DESIGNED BY: | EV | |
| | PROOF BY: | EV | |
| | DESIGNED BY: | | |

| PROJECT: | A JP VENTURES-MEDSQUARE PEMBROKE PINES EXTERIOR AND MONUMENT SIGN | REVISIONS | |
|----------|---|-----------|------------------|
| ADDRESS: | | <u> </u> | <u>\$</u> 9-3-24 |
| | Print: Signature: | <u>^</u> | <u> </u> |
| | | <u> </u> | <u> </u> |

