

# Storefront Replacements at Various Charter Schools

### Invitation for Bids # PSPW-24-02

	General Information	
Project Cost Estimate	\$110,000	See Section 1.4
Project Timeline	150 calendar days from NTP with an estimated start timeline of May 2024	See Section 1.4
<b>Evaluation of Proposals</b>	Staff	See Section 1.7
Mandatory Pre-Bid Meeting	10:00 a.m. on March 5, 2024, at various Charter School locations. The order of sites for the meeting will be as follows: 1) Central Campus, 2) Academic Village, 3) West Elementary. Location addresses can be found in Section 1.3.3 of the bid package. See Section 1.8.1 for more details regarding the Pre-Bid Meeting.	See Section 1.8
Question Due Date	March 11, 2024	See Section 1.8
Proposals will be accepted until	2:00 p.m. on March 26, 2024	See Section 1.8
Proposal Security / Bid Bond	<ul> <li>□ Not required.</li> <li>✓ Required only for bidders that have a total cumulative base proposal amount that exceeds \$200,000. Proposal Security shall be in the amount of 5% of the total cumulative base amount proposed.</li> <li>□ Required for every bidder, regardless of proposal amount. Proposal Security shall be in the amount of 5% of the total cumulative base amount proposed.</li> <li>□ Required for every bidder, regardless of proposal amount. Proposal Security shall be in the amount of \$10,000 or 5% of the total cumulative base amount proposed, whichever is less.</li> </ul>	See Section 4.1
100% Payment and Performance Bonds	<ul> <li>□ Not required.</li> <li>□ Required, regardless of the awarded contract amount.</li> <li>✓ Required in the event that the awarded contract exceeds \$200,000.</li> </ul>	See Section 4.2
Grant or Federal Funding Information	Not Applicable	Not Applicable

THE CITY OF PEMBROKE PINES
PROCUREMENT DEPARTMENT
8300 SOUTH PALM DRIVE
PEMBROKE PINES, FLORIDA 33025
(954) 518-9020



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#### **ATTACHMENTS**

Attachment A: Non-Collusive Affidavit

Attachment B: Sample Insurance Certificate

Attachment C: Specimen Contract – Construction Agreement

Attachment D: Standard Release of Lien Form

Attachment E: Academic Village Storefronts Plans

Attachment F: Central Campus Storefronts Plans

Attachment G: West Campus Storefronts Plans

Attachment H: NOA - Series "3100-Resistor" Aluminum Storefront Window Wall System

Attachment I: NOA - "351 Series" Outswing Aluminum Entrance Door w/wo Transom

#### **SECTION 1 - INSTRUCTIONS**

#### **1.1 NOTICE**

Notice is hereby given that the City Commission of the City of Pembroke Pines is seeking sealed proposals for:

#### IFB # PSPW-24-02 Storefront Replacements at Various Charter Schools

Solicitations may be obtained from the City of Pembroke Pines website at <a href="http://www.ppines.com/index.aspx?NID=667">http://www.ppines.com/index.aspx?NID=667</a> and on the <a href="https://ppines.bonfirehub.com/">https://ppines.bonfirehub.com/</a> website.

If you have any problems downloading the solicitation, please contact the Bonfire Support at <a href="mailto:Support@GoBonfire.com">Support@GoBonfire.com</a>.

If additional information help is needed with downloading the solicitation package please contact the Procurement Department at (954) 518-9020 or by email at <a href="mailto:purchasing@ppines.com">purchasing@ppines.com</a>. The Procurement Department hours are between 7:00 a.m. - 6:00 p.m. on Monday through Thursday and is located at 8300 South Palm Drive, Pembroke Pines, Florida 33025.

The City requires all questions relating to the solicitation be entered through the "Messages" section for the specific project on the <a href="https://ppines.bonfirehub.com/">https://ppines.bonfirehub.com/</a> website. Under the "Messages" section, vendors will find the "Opportunity Q&A" tab in which they can ask their specific question(s). Responses to the questions will be provided online at <a href="https://ppines.bonfirehub.com">https://ppines.bonfirehub.com</a>. Such request must be received by the "Question Due Date" stated in the solicitation. The issuance of a response via Bonfire is considered an Addendum and shall be the only official method whereby such an interpretation or clarification will be made.

**Proposals will be accepted until 2:00 p.m., Tuesday, March 26, 2024.** Proposals must be **submitted electronically at https://ppines.bonfirehub.com/**. The sealed electronic proposals will be publicly opened at 2:30 p.m. by the City Clerk's Office, in the City Hall Administration Building, 4<sup>th</sup> Floor Conference Room located at 601 City Center Way, Pembroke Pines, Florida, 33025.

#### 1.1.1 VIRTUAL BID OPENING

The bid opening for this project will be held in the <u>City Clerk's Office Conference</u> <u>Room</u> located on the 4<sup>th</sup> Floor in the Charles F. Dodge City Center/City Hall Administration Building at 601 City Center Way, Pembroke Pines, Florida, 33025 at **2:30 PM on the bid due date.** 



In light of public health concerns and to ensure accessibility for all, the City encourages interested parties, vendors, and the public to participate virtually via live streaming instead of attending the meeting in person. To virtually attend the bid opening, please use the Cisco Webex Meetings platform.

#### **Virtual Meeting Details:**

• WebEx Meeting Link: https://ppines.webex.com/meet/purchasing

Cisco Webex Meeting Number: 717 019 586
 Join by Phone Number: +1-408-418-9388

The public may download the **Cisco Webex Meetings app** from <a href="https://www.webex.com/downloads.html/">https://www.webex.com/downloads.html/</a>

To ensure an efficient meeting process, participants are requested to mute their audio and camera during the meeting. While the public is welcome to attend the virtual bid opening, please note that active participation and commenting will not be allowed during the proceedings.

For further information about the bid opening or assistance in accessing the virtual meeting, please contact:

Danny Benedit, Procurement Department City of Pembroke Pines 8300 South Palm Drive, Pembroke Pines, FL 33025 954-518-9022 or 954-518-9020 purchasing@ppines.com

#### 1.2 PURPOSE

The City of Pembroke Pines is seeking proposals from qualified firms, hereinafter referred to as the Contractor, for the replacement of storefront systems at various Pembroke Pines Charter School locations, in accordance with the terms, conditions, and specifications contained in this solicitation.

#### 1.3 SCOPE OF WORK

#### 1.3.1 PROJECT DETAILS

- Contractor to remove existing storefront systems and dispose of at the City's discretion.
- Contractor shall be responsible to remove all debris from the site daily.
- Contractor is responsible for removal of metal framing wall at Academic Village and Central Campus main entries.
- The contractor must be careful to maintain security alarms, and other existing conditions for all parts of items to remain.



- Contractor shall take proper care to protect and close off work area as required for normal facility operation.
- Doors WE1, WE2, WE3, AV2, and AV3 are to include Allegion LCN 4040XP closers, Von Duprin 98/99 Series concealed vertical rods with push bar, hinges, power supply, Von Duprin EPT10 power transfer, Schlage AD Series card reader, and keyway cylinder Schlage Everest T for all doors. Any wiring needed for these items is to be included.
- Doors WE1, WE2, and WE3 require remote openers compatible with hardware being installed.
- Doors AV1, AV4 and C1 will not require card reader, push bars, EPT10 power transfer, power supply, and closer hardware.
- Contractor shall provide key cylinders a minimum of 2 weeks in advance for owner to rekey prior to Contractor's installation.
- Frame color to match existing.
- All doors removed shall have the new assemblies installed before end of work day to
  ensure that building can be locked up.
- Any repairs required around the doors due to replacement of such, shall be done by the contractor to include but not limited to, removal and reinstall drywall, stucco, paint, polyurethane sealant, interior and exterior floors, etc.
- Contractor is responsible for acquiring permit and calling in all necessary inspections.

#### 1.3.2 PROJECT DETAILS

- If Contractor is awarded during the school year, Contractor should plan for weekend work. If Contractor is awarded during the summer break, the work must be performed Monday through Friday, from 8 am to 5 pm, or as approved by the Project Manager.
- Contractor will be required to schedule all work with the City's Project Manager.
- Contractor must not allow materials and debris generated daily to be disposed of in an illegal manner.
- The minimum experience required as a licensed General Contractor is five (5) years for these projects.
- Contractor shall provide all materials, labor, equipment, and any other necessary items required for complete turn-key installation.
- City shall provide the Contractor with existing building plans and storefront NOA's.
   All other documents, plans, and submittals required to obtain a permit are to be provided by the contractor. Contractor is allowed to provide alternate NOA's with similar specifications for storefront doors and windows at time of bid submittal, for review and approval by the City.



- If Contractor is submitting pricing for alternate storefront doors and windows, (see Attachments H & I for City's provided NOA's) contractor must confirm in the "Vendor Notes" column of the "Additional Responses" price sheet if the alternate storefront manufacturer can fabricate the doors to fit the specialized hardware. See 1.5.1 Pricing Sheet / Bid Tables for more details and sample.
- Contractor shall provide all testing, manufacturer warranties, contractor warranties, and certifications.
- All items must be installed as per all governing code requirements.
- The successful Bidder shall employ a competent English-speaking superintendent who
  shall be in attendance at the project site during the progress of the work. The
  superintendent shall be the primary representative for the Bidder and all
  communications given to and all decisions made by the superintendent shall be binding
  to the Bidder.
- Contractor shall be responsible for all debris removal and restoration to any existing areas damaged by the contractor once the project is completed. Site shall be made safe as per OSHA standard, and clean of debris at the end of each work day.
- All precautions need to be taken for life safety and protection of people, vehicles, and all other structures on the site.
- Contractor is responsible for removal and reinstallation of fencing, landscaping, concrete, and any other items as necessary to access the work areas. Contractor is allowed to setup temporary container for storage.
- Contractor is responsible for acquiring all necessary permits.
- Contractor shall provide weekly schedule/progress updates.

#### 1.3.3 LOCATIONS

Charter School	Address	Storefront Numbers
Name		
Central Campus	12350 Sheridan St,	C1
	Pembroke Pines, FL	
	33026	
Academic Village	17189 Sheridan St,	AV1, AV2, AV3, AV4
	Pembroke Pines, FL	
	33331	
West Elementary	18501 Pembroke Rd,	WE1, WE2, WE3
	Pembroke Pines, FL	
	33029	



#### 1.3.4 WARRANTIES

- Contractor shall provide a minimum (1) year workmanship labor and material warranty covering repair of existing concrete and new concrete removed and/or replaced by the contractor.
- Upon completion of the project, and with their application instructions and specifications strictly adhered to, the contractor shall provide a written minimum (5) year product warranty from the manufacturer.

#### 1.3.5 USE OF PREMISES

- Contractor shall limit their use on the premises for work and storage, and to allow for Owner's Occupancy.
- Contractor shall coordinate use of premises under direction of owner representative, assume full responsibility for protection and safe keeping of products under this contract stored on site, and move any stored products under Contractor's control which interfere with operations of the Owners or separate contractor.

#### 1.4 PROJECT COST ESTIMATE & TIMELINE

Staff estimates this project to cost approximately \$110,000, which does not include permit costs.

Please note that the City will waive all City related permit, license, impact or inspection fees (including the Building Department and Engineering Department Permit Fees) related to this project. Any related State or County fees, for the aforementioned permits, will be paid by the City.

In addition, the City shall cover the cost for any other permit fees related to external entities through the City's Owner's Contingency for this project, therefore proposers should not include permit costs in their total proposal price.

The work shall be completed within 150 days from issuance of CITY's Notice to Proceed, with an estimated start timeline of May 2024.

In addition, please note the city's average time for a contractor to apply for and receive an approved permit is 30 days; delays in this timeline caused by the contractor's failure to actively monitor the permit process and submit all required documentation in a timely manner, will count against the project's contractual completion period.

#### 1.4.1 LIQUIDATED DAMAGES

Liquidated Damages for this project shall be \$500 per day.



#### 1.4.2 PERMIT, LICENSE, IMPACT OR INSPECTION FEES

With the exception of the City related permit, license, impact or inspection fees (including the Building Department and Engineering Department Permit Fees), which will be waived for this project, the City does not anticipate any additional permit, license, impact or inspection fees for this project.

The City shall determine the amount of the Owner's Contingency at time of award. The Owner's Contingency may be based on a specified percent of the proposed project amount and shall be established for the specific project being performed under the contract. This dollar amount shall be shown on the specific project purchase order as a distinct item from the vendor's overall offer to determine the total potential dollar value of the contract. Any Owner's Contingency funds that have not been utilized at the end of the project will remain with the City, if the permit fees exceed the Owner's Contingency indicated, the City will reimburse the contractor the actual amount of the permit fees required for project completion.

#### 1.5 PROPOSAL REQUIREMENTS

The <a href="https://ppines.bonfirehub.com">https://ppines.bonfirehub.com</a> website allows for vendors to complete, scan and upload their documents as part of the proposer's submittal on the website.

Prospective proposers interested in responding to this solicitation are requested to provide all of the information listed in this section. Submittals that do not respond completely to all of requirements specified herein may be considered non-responsive and eliminated from the process. Brevity and clarity are encouraged.


The Bonfire system utilizes "Questionnaires" to request the following information from prospective proposers.

#### 1.5.1 Pricing Sheet / Bid Tables

- 1. **Bid Table:** The vendor must provide their pricing through the designated lines items listed on the Excel Sheet that is available for download on the Bonfire website under the "**Pricing Sheet / Bid Table**" section. Please follow the instructions given in this package and on the Excel Sheet to complete and upload the information back onto the Bonfire website.
- 2. **Primary Responses:** This tab of the Bid Table includes a "Vendor Notes" column for any additional comments regarding the requested line item(s). A comment is required in the "Vendor Notes" column. If the vendor does not need to submit any comments, please enter N/A or similar. If the total cumulative base proposal amount does not exceed \$200,000 and a Payment and Performance Bond is not required, please enter "0" on the "If Applicable, Cost for Payment and Performance Bond" column for each line item.



a. Below is a sample of the "**Primary Responses**" tab of the Bid Table:

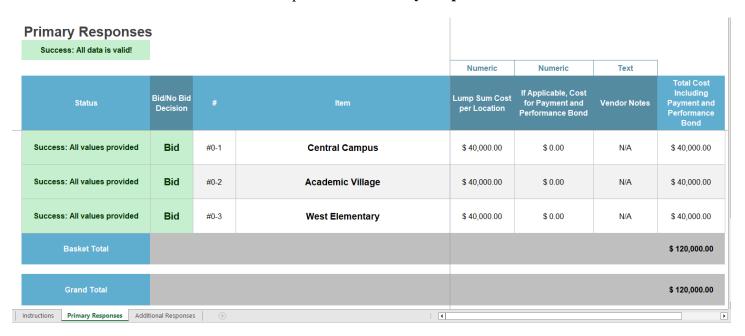

- 3. **Additional Responses:** This tab of the Bid Table allows for bidders to submit alternative options. Substitutions of brands or products must be submitted as an alternative for the City's review and approval.
  - To submit an alternative, the vendor must copy the information for the corresponding line item from the "#" column in the "Primary Responses" tab and paste it into the "Additional Reponses" tab to identify which item they are providing an alternative option for.
  - b. Vendors are required to identify the substitution of brands or products in the "Vendor Notes" column. In addition, vendors must confirm in the "Vendor Notes" column if the alternate storefront manufacturer can fabricate the doors to fit the specialized hardware.
  - c. For additional information on uploading supporting documentation for the proposed alternative(s), please refer to **Section 1.5.4(3)**.
  - d. Below is a sample of the "Additional Responses" tab of the Bid Table:



Success: All data is valid!						
			Numeric	Numeric	Text	
Status	#	ltem	Lump Sum Cost per Location	If Applicable, Cost for Payment and Performance	Vendor Notes	Total Cost Including Payment an Performand
Success: All values provided	#0-1	Central Campus	\$ 40,000.00	\$ 0.00	Submitting "Alternate Brand Name", Doors can fit the specialized hardware.	\$ 40,000.00
Success: All values provided	#0-2	Academic Village	\$ 40,000.00	\$ 0.00	Submitting "Alternate Brand Name", Doors can fit the specialized hardware.	\$ 40,000.00
Success: All values provided	#0-3	West Elementary	\$ 40,000.00	\$ 0.00	Submitting "Alternate Brand Name", Doors can fit the specialized hardware.	\$ 40,000.00

#### 1.5.2 Questionnaires

- 1. Contact Information Form
- 2. Proposer's Background Information
- 3. Vendor Registration Checklist
- 4. **References Form:** Provide specific examples of similar contracts delivered by the proposed team members. Provide details on related projects (preferably where the team was the same). A minimum of 3 references should be from the last five years and should be capable of explaining and confirming your firm's capacity to successfully complete the scope of work outlined herein. As part of the proposal evaluation process, the City may conduct an investigation of references, including a record check or consumer affairs complaints. Proposers' submission of a proposal constitutes acknowledgment of the process and consent to investigate. The City is the sole judge in determining Proposers qualifications. In this section you will have the ability to enter information for 5 different references including the Reference Contact Information and the specific Project Information.

In addition, do not provide City of Pembroke Pines projects as any of your references and do not utilize any current City of Pembroke Pines employees as reference contacts.

- A) References Contact Information
  - a. Name of Firm, City, County or Agency
  - b. Address
  - c. Contact Name



- d. Contact Title
- e. Contact E-mail Address
- f. Contact Telephone #
- B) Project Information
  - a. Name of Contractor Performing the work
  - b. Name and location of the project
  - c. Nature of the firm's responsibility on the project
  - d. Project duration
  - e. Completion (Anticipated) Date
  - f. Size of project
  - g. Cost of project
  - h. Work for which staff was responsible

#### **1.5.3** Other Completed Documents

- 1. Attachment A: Non-Collusive Affidavit
- 2. Proposal Security (Bid Bond Form or Cashier's Check)
  - a. Each Proposal should be accompanied by a certified or cashier's check or by a Bid Bond made payable to the City of Pembroke Pines on an approved form, duly executed by the Proposer as principal and having as surety thereon a surety company acceptable to CITY and authorized to write such Bond under the laws of the State of Florida, in an amount not less than five percent (5%) of the amount of the base Proposal price.
  - b. Contingency is not to be counted in the total amount the proposal security is based on.
  - c. Proposers must submit a scanned copy of their bid security (bid bond form or cashier's check) with their bid submittal through Bonfire.
  - d. Proposers should also submit their original bid security (bid bond form or cashier's check) at time of the bid due date, or they may be deemed as non-responsive.
  - e. The original Bid Bond or Cashier's Check should be in a sealed envelope, plainly marked "BID SECURITY IFB # PSPW-24-02 Storefront Replacements at Various Charter School Locations" and sent to the City of Pembroke Pines, City Clerk's Office, 4th Floor, 601 City Center Way, Pembroke Pines, Florida, 33025.

Please see SECTION 4 - SPECIAL TERMS & CONDITIONS of this document for additional information.



#### 1.5.4 Optional Documentation

#### 1. Trade Secrets:

- a. The Proposer's response to this solicitation is a public record pursuant to Florida law, which is subject to disclosure by the City under the State of Florida Public Records Law, Florida Statutes Chapter 119.07 ("Public Records Law"). The City shall permit public access to all documents, papers, letters or other material submitted in connection with this solicitation and the Contract to be executed for this solicitation, subject to the provisions of Chapter 119.07 of the Florida Statutes.
- b. Any language contained in the Proposer's response to the solicitation purporting to require confidentiality of any portion of the Proposer's response to the solicitation, except to the extent that certain information is in the City's opinion a Trade Secret pursuant to Florida law, shall be void. If a Proposer submits any documents or other information to the City which the Proposer claims is Trade Secret information and exempt from Florida Statutes Chapter 119.07 ("Public Records Laws"), the Proposer shall clearly designate that it is a Trade Secret and that it is asserting that the document or information is exempt. The Proposer must specifically identify the exemption being claimed under Florida Statutes 119.07. The City shall be the final arbiter of whether any information contained in the Proposer's response to the solicitation constitutes a Trade Secret.
- c. EXCEPT FOR CLEARLY MARKED PORTIONS THAT ARE BONA FIDE TRADE SECRETS PURSUANT TO FLORIDA LAW, DO NOT MARK YOUR RESPONSE TO THE SOLICITATION AS PROPRIETARY OR CONFIDENTIAL. DO NOT MARK YOUR RESPONSE TO THE SOLICITATION OR ANY PART THEREOF AS COPYRIGHTED. ALL DOCUMENTS THAT THE FIRM PURPORTS TO BE CONFIDENTIAL, PROPRIETARY OR A TRADE SECRET SHALL BE UPLOADED TO THE BONFIRE WEBSITE AS A SEPARATE ATTACHMENT, IN THIS SECTION, CLEARLY IDENTIFYING THE EXEMPTION BEING CLAIMED UNDER FLORIDA STATUTES 119.07.
- d. The city's determination of whether an exemption applies shall be final, and the proposer agrees to defend, indemnify, and hold harmless the city and the city's officers, employees, and agent, against any loss or damages incurred by any person or entity as a result of the city's treatment of records as public records.

#### 2. Financial Statements:

- a. The City is <u>not</u> requesting the vendor to submit any financial statements for this project and prefers if the vendor does not submit financial statements. In addition, if the City needs a copy of the vendor's financial statements, the City can contact the vendor after the bid due date to request those documents. However, if the vendor does submit the financial statements, they should be uploaded in this section.
- b. Any claim of confidentiality on financial statements must be asserted at the time of submittal. The firm must identify the specific statute that authorizes the exemption from the Public Records Law. Please note that the financial statement exemption provided for in Section 119.071(1)c, Florida Statutes only applies to submittals in response to a solicitation for a "public works" project.

#### 3. Alternatives:

- a. If you are submitting an alternative product, please upload any related information in this section (such as specification sheets, etc.).
- b. In addition, pursuant to **Section 3.7 "Brand Names,"** if and wherever in the specifications a brand name, make, name of manufacturer, trade name, or vendor catalog number is mentioned, it is for the purpose of establishing a grade or quality of material only. Since the City does not wish to rule out other competition and equal brands or makes, the phrase "OR EQUAL" is added. However, if a product other than that specified is bid, Proposers shall indicate on their proposal and clearly state the proposed substitution and deviation. It is the vendor's responsibility to provide any necessary documentation and samples within their bid submittal to prove that the product is equal to that specified. Such samples are to be furnished before the date of bid opening, unless otherwise specified. Additional evidence in the form of documentation and samples may be requested if the proposed brand is other than that specified. The City retains the right to determine if the proposed brand shall be considered as an approved equivalent or not.

#### 4. Additional Information:

a. Please provide any additional information that you deem necessary to complete your proposal in this section, if it has not been requested in another section.

#### 1.6 VENDOR REGISTRATION DOCUMENTS

The <a href="https://ppines.bonfirehub.com/">https://ppines.bonfirehub.com/</a> website will allow vendors to update their information and documents on an as-needed basis. This process is intended to make the bidding process easier for vendors that bid on multiple City projects. This process will allow vendors to complete and



submit the following standard forms and documents at any time prior to bidding on a project. In addition, the vendors will be able to utilize these same forms without the need to re-fill and resubmit the forms each time they bid on a City project. In the event that the City does not have one of the forms or documents listed below for your company, the City may reach out to your company after the bid has closed to obtain the document(s).

# Furthermore, please make sure to update this information on an as-needed basis so that all pertinent information is accurate, such as local business tax receipts, and any other relevant information.

The following documents can be completed prior to the bidding process through the <a href="https://ppines.bonfirehub.com/">https://ppines.bonfirehub.com/</a> website and do not need to be attached to your submittal as the Bonfire website will automatically include it.

#### 1.6.1 Vendor Information Form

#### 1.6.2 Form W-9 (Rev. October 2018)

a. Previously dated versions of this form will delay the processing of any payments to the selected vendor.

#### 1.6.3 Company Profile Form

#### 1.6.4 Sworn Statement on Public Entity Crimes Form

#### 1.6.5 Equal Benefits Certification Form

#### 1.6.6 Vendor Drug-Free Workplace Certification Form

#### **1.6.7** Scrutinized Company Certification

#### 1.6.8 E-Verify System Certification Statement

- a. Effective January 1, 2021, pursuant to Section 448.095. Florida Statues, the City may not enter into a contract with a vendor/contractor/subcontractor unless that vendor/contractor/subcontractor is registered with and uses the E-Verify system administered by the U.S. Department of Homeland Security ("DHS").
- b. Contractor shall also require all subcontractors to provide an affidavit attesting that the subcontractor does not employ, contract with, or subcontract with, an unauthorized alien. The Contractor shall maintain a copy of such affidavit for the duration of the contract.

#### **1.6.9** Veteran Owned Small Business Preference Certification

- a. If claiming Veteran Owned Small Business Preference Certification, business must attach the "Determination Letter" from the United States Department of Veteran Affairs Center for Verification and Evaluation notifying the business that they have been approved as a Veteran Owned Small Business (VOSB).
- b. The Veteran Owned Small Business Preference Certification form must be completed by/for the proposer; the proposer <u>WILL NOT</u> qualify for Veteran Owned Small Business Preference based on their sub-contractors' qualifications.

#### 1.6.10 Local Business Tax Receipts

#### 1.6.11 Local Vendor Preference Certification

#### 1.7 EVALUATION OF PROPOSALS & PROCESS OF SELECTION

- A. Staff will evaluate all responsive proposals received from proposers who meet or exceed the bid requirements contained in the solicitation. Evaluations shall be based upon the information contained in the proposals as submitted.
- B. Staff will make a recommendation to the City Commission for award of contract.

#### 1.8 TENTATIVE SCHEDULE OF EVENTS

Event	Time &/or Date
Issuance of Solicitation (Posting Date)	February 27, 2024
Mandatory Pre Bid Meeting	10:00 a.m. on March 5, 2024
Question Due Date	March 11, 2024
Anticipated Date of Issuance for the	March 14, 2024
Addenda with Questions and Answers	
Proposals will be accepted until	2:00 p.m. on March 26, 2024
Proposals will be opened at	2:30 p.m. on March 26, 2024
Evaluation of Proposals by Staff	March 26, 2024– May 1, 2024
Recommendation of Contractor to	May 1, 2024
City Commission award	
Issuance of Notice to Proceed	May 9, 2024
Project Commencement	Not later than 10 days after NTP
Project Completion	150 days after NTP

#### 1.8.1 MANDATORY SITE VISIT

It is mandatory to visit all sites prior to submitting a bid for this project. There is a scheduled site visit on March 5, 2024, at 10 a.m. The order of sites for the meeting will be as follows: 1) Central Campus, 2) Academic Village, 3) West Elementary.



Charter School Name	Address
Central Campus	12350 Sheridan St, Pembroke Pines, FL 33026
Academic Village	17189 Sheridan St, Pembroke Pines, FL 33331
West Elementary	18501 Pembroke Rd, Pembroke Pines, FL 33029

In the event that a contractor cannot attend the scheduled site visit, or if a contractor would like a follow up visit to the site, they may request a site visit by contacting Irene Munarriz at 954-518-9061. We urge all contractors to attend the scheduled meeting, as a separate or follow-up meeting may not be afforded to the requester due to scheduling and availability of staff to assist with any additional meetings. In addition, if making a request for a separate or follow-up meeting, contractors are urged to make these requests as early as possible.

Contractors may be required to sign in at any of the meetings to show proof of attendance. It is the vendor's responsibility to make sure that they sign in at the meeting.

#### 1.9 SUBMISSION REQUIREMENTS

Bids/proposals <u>must be submitted electronically</u> at <u>https://ppines.bonfirehub.com/</u> on or before 2:00 p.m. on March 26, 2024.

Please note vendors should be registered on Bonfire under the name of the organization that they are operating as and it should match the organization name on the documents that they are submitting and utilizing when responding to the solicitation.

In addition, the vendor must complete any questionnaires on the <a href="https://ppines.bonfirehub.com/">https://ppines.bonfirehub.com/</a> website and provide any additional information requested throughout this solicitation. Any additional information requested in the solicitation should be scanned and uploaded.


The City recommends for proposers to submit their proposals as soon as they are ready to do so. Please allow ample time to submit your proposals on the <a href="https://ppines.bonfirehub.com/">https://ppines.bonfirehub.com/</a> website. Proposals may be modified or withdrawn prior to the deadline for submitting Proposals. Bonfire Support is happy to help you with submitting your proposal and to ensure that you are submitting your proposals correctly, but we ask that you contact <a href="mailto:Support@GoBonfire.com">Support@GoBonfire.com</a> with ample time before the bid closing date and time.

#### PLEASE DO NOT SUBMIT ANY PROPOSALS VIA MAIL, E-MAIL OR FAX.

However, please note that any required Bid Bond or Cashier's Check should be in a sealed envelope, plainly marked "BID SECURITY - IFB # PSPW-24-02 Storefront Replacements at Various Charter School Locations" and sent to the City of Pembroke Pines, City Clerk's Office, 4th Floor, 601 City Center Way, Pembroke Pines, Florida, 33025.


# ACADEMIC VILLAGE STOREFRONT REPLACEMENT

17189 SHERIDAN STREET PEMBROKE PINES FLORIDA

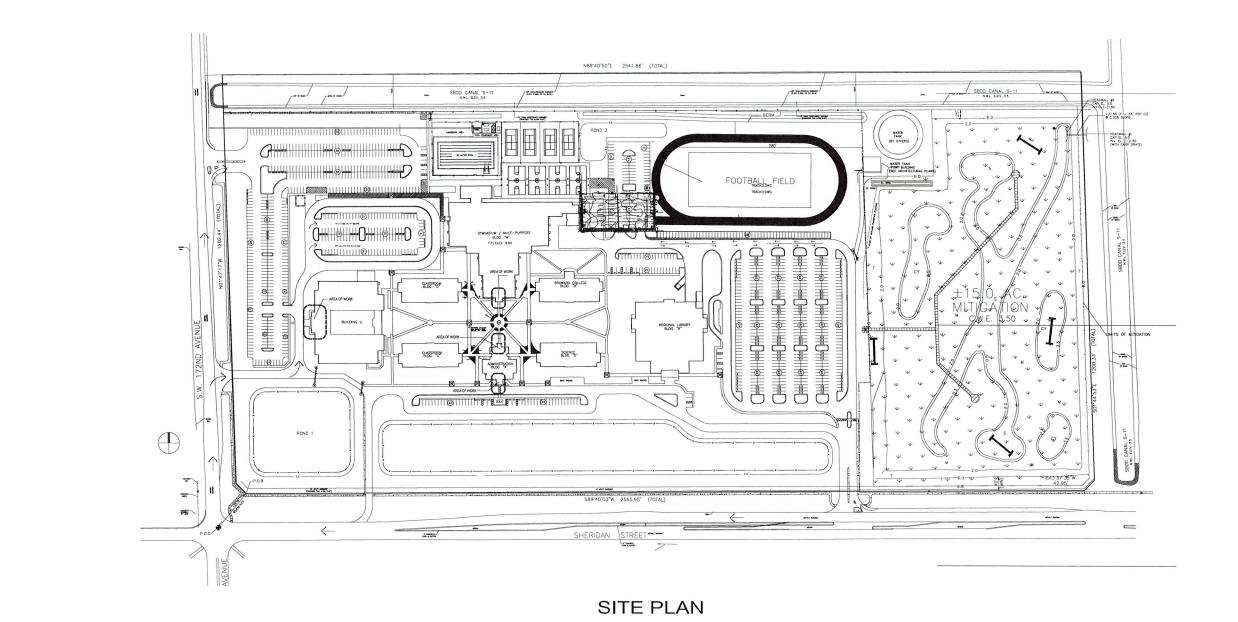


LICENSE NO. ACADEMIC VILLAGE STOREFRONT REPLACEMENT SCALE N.T.S DATE 01-23-2024 DRAWN BY A. NUNEZ DRAWING NO. 07272005


A-1

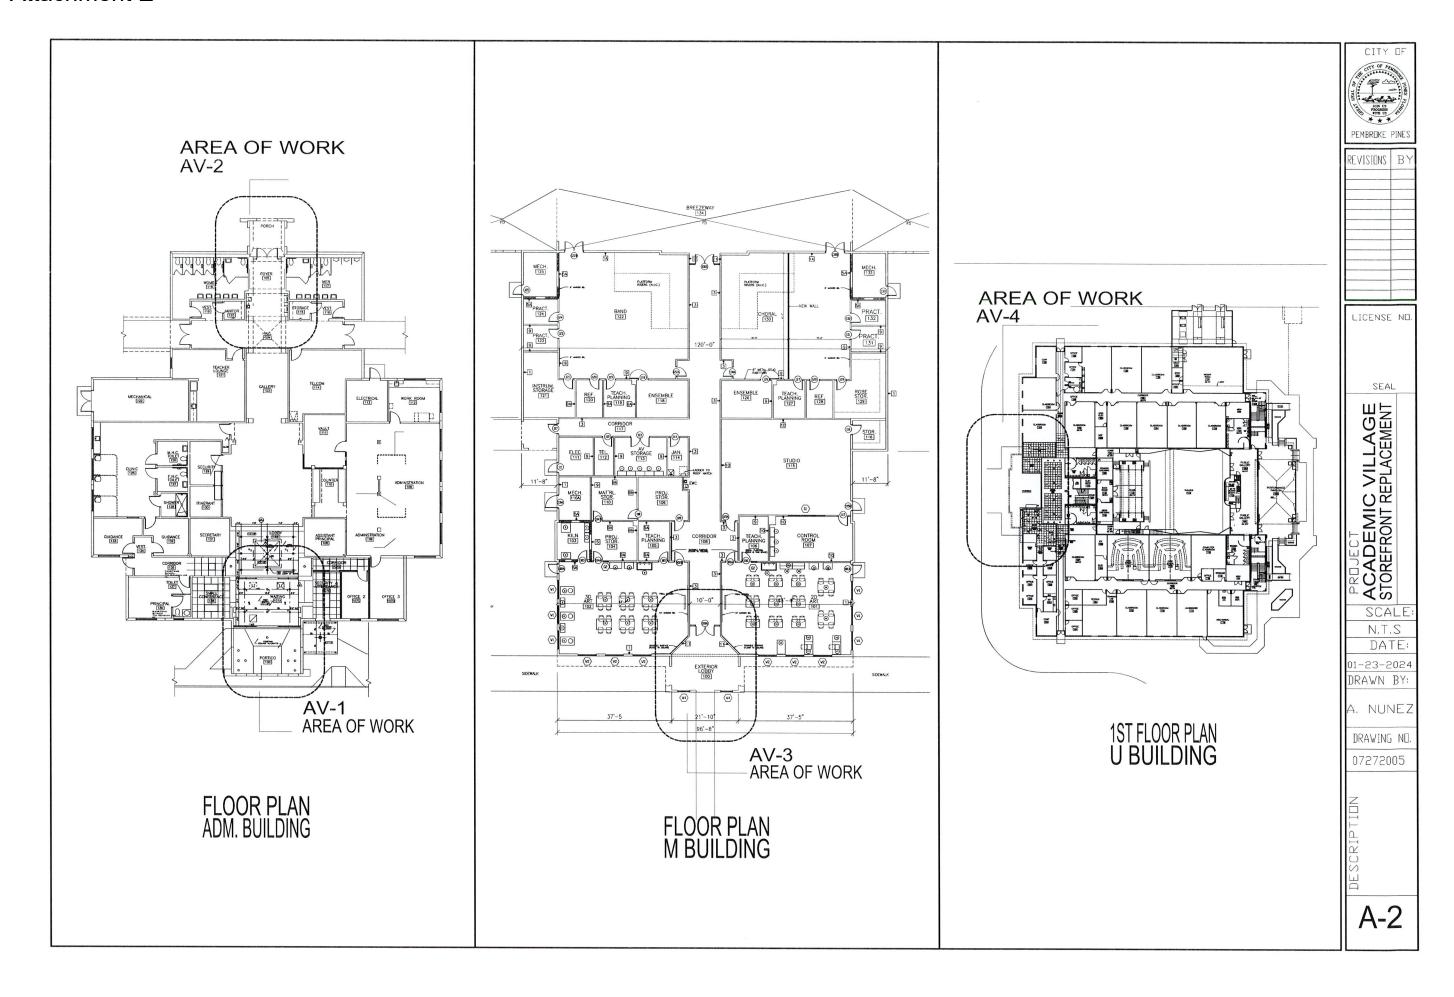

# CENTRAL CAMPUS CHARTER SCHOOL STOREFRONT REPLACEMENT

12350 SHERIDAN ST. PEMBROKE PINES FLORIDA 33026

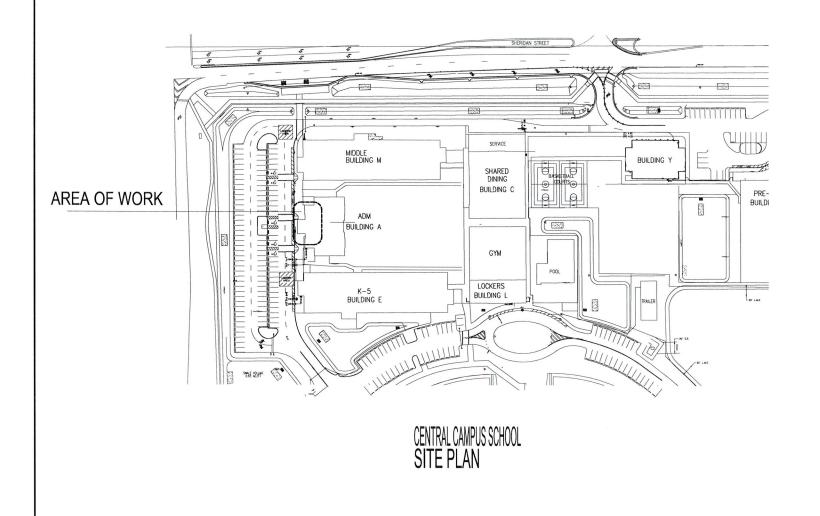

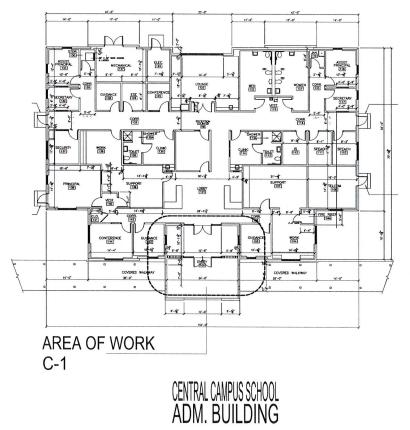



REVISIONS 1

LICENSE NO

SEAL

PREJECT
CENTRAL CAMPUS CHARTER SCHOOL
STOREFRONT REPLACEMENT

N.T.S DATE: 11-23-2024

SCALE


A. NUNEZ

DRAWN BY

DRAWING NO.

SCRIPTION

A-1

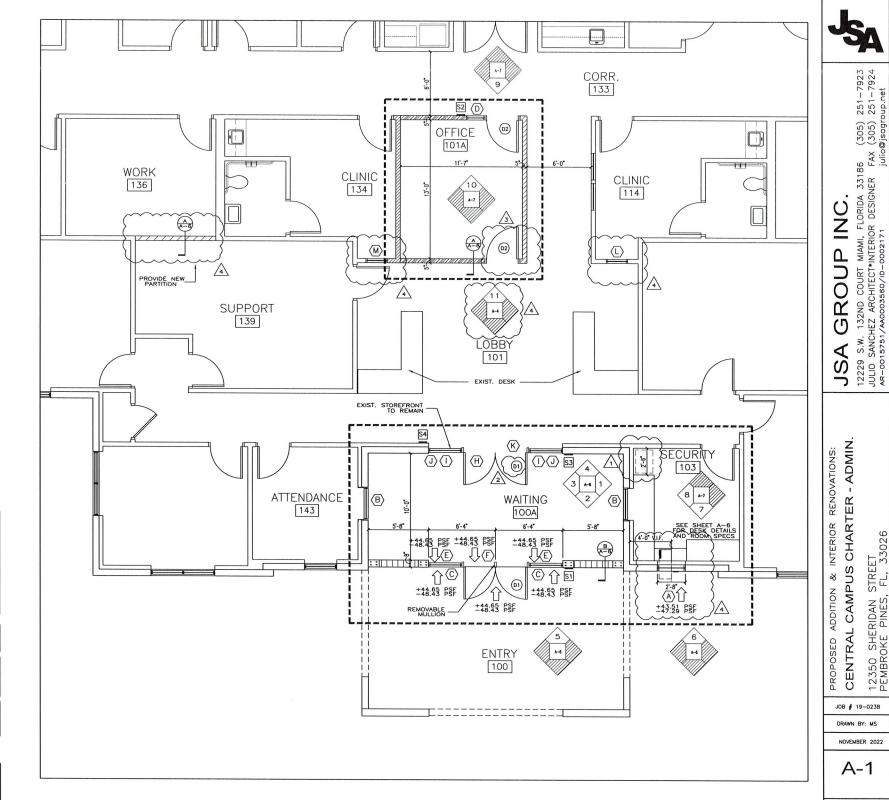

#### **GENERAL NOTES:**

- REVIEW AND APPROVAL BY AHJ SHALL NOT RELIEVE THE APPLICANT OF THE RESPONSIBILITY OF COMPLIANCE WITH THIS CODE PER NFPA 1:1.14.4.
- B- FIRE CODE IN EFFECT: FLORIDA FIRE PREVENTION CODE (FFPC) 6TH EDITION, EFFECTIVE DECEMBER 31, 2017 WITH BROWARD COUNTY AMENDMENTS, WHICH INCLUDES NFPA 101, 2015 EDITION, NFPA 1, 2015 EDITION & STATE STATUES, 2017 EDITION.
- D- ADDITIONAL EXIT SIGNS AND EMERGENCY LIGHTS MAY BE REQUIRED BY THE FIRE INSPECTOR AT THE TIME OF THE FIRE FINAL.
- E- SEPARATE FIRE ALARM SHOP DRAWINGS COMPLYING WITH NFPA 72(2013 ED) AND PERMITS TO BE PROVIDED BY A LICENSED AND CERTIFIED FIRE ALARM CONTRACTOR.
- F- SEPARATE FIRE SPRINKLER SHOP DRAWINGS COMPLING WITH NFPA 13 (2013 ED.) AND PERMITS TO BE PROVIDED BY A LICENSED AND CERTIFIED FIRE SPRINKLER CONTRACTOR.

#### WALL LEGEND

NEW 8" CONCRETE BLOCK WALL

NOTE: THESE DOCUMENTS ARE IN COMPLIANCE WITH THE FBC 2017.

NOTE:
AS PER FBC 2017, EXIST. BUILDING,
CHAPTER 3 SECTION 303, THIS
PROJECT IS CLASSIFIED AS ALTERATION
LEVEL 2 AND TYPE III CONSTRUCTION

NOTE:
ALL WOOD IN CONTACT WITH CONCRETE
OR C.M.U. SHALL BE PRESSURE
TREATED AS PER FBC CHAPTER 2303

BUILDING SHALL COMPLY WITH FBC 2017, TABLE 803.5
INTERIOR WALLS AND CEILING FINISH REQUIREMENTS:

1 - CLASS "B" FOR VERTICAL EXITS AND EXIT PASSAGEWAYS
2 - CLASS "C" FOR EXIT ACCESS CORRIDORS AND OTHER EXITWAYS,
ROOMS AND ENCLOSED SPACES.

PROPOSED FLOOR PLAN





NOVEMBER 2022

A-1

STREET

SHERIDAN


12350 PFMBR


CENTRAL

REVISIONS 1 FEB. 18, 2021 2 JUNE 4, 2021 3 MARCH 3, 2022 NOV. 1, 2022

# WEST CAMPUS CHARTER SCHOOL STOREFRONT REPLACEMENT

18501 PEMBROKE RD. PEMBROKE PINES FLORIDA 33029

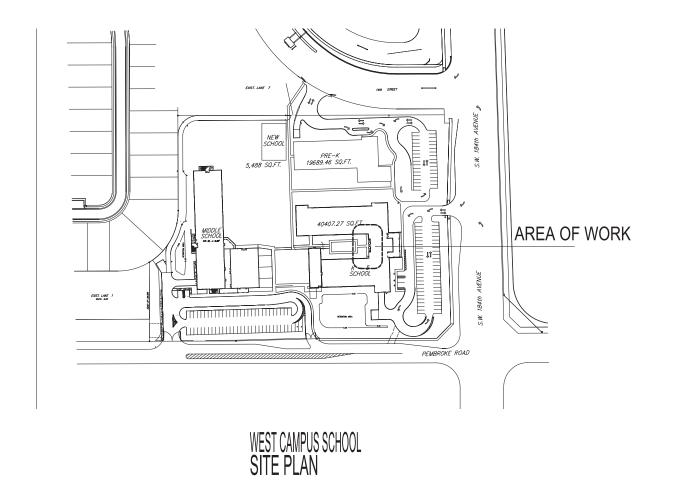

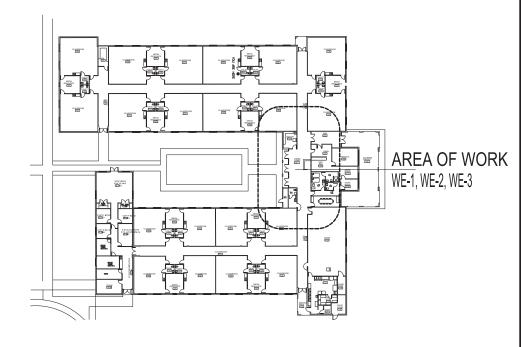

WEST CAMPUS SCHOOL ELEMENTARY BUILDING



REVISIONS B

LICENSE NO.

PROJECT
WEST CAMPUS CHARTER SCHOOL
STOREFRONT REPLACEMENT

SCALE

N.T.S

DATE:

01-23-2024 DRAWN BY:

A. NUNEZ

DRAWING NO.

A-1



#### Attachment H

MIAMI-DADE COUNTY PRODUCT CONTROL SECTION

11805 SW 26 Street, Room 208 Miami, Florida 33175-2474 T (786) 315-2590 F (786) 315-2599

www.miamidade.gov/economy

### DEPARTMENT OF REGULATORY AND ECONOMIC RESOURCES (RER) BOARD AND CODE ADMINISTRATION DIVISION

#### **NOTICE OF ACCEPTANCE (NOA)**

Trulite Glass & Aluminum Solutions, LLC 403 West Park Ct, #201 Peachtree City, GA 30269

#### SCOPE:

This NOA is being issued under the applicable rules and regulations governing the use of construction materials. The documentation submitted has been reviewed and accepted by Miami-Dade County RER -Product Control Section to be used in Miami Dade County and other areas where allowed by the Authority Having Jurisdiction (AHJ).

This NOA shall not be valid after the expiration date stated below. The Miami-Dade County Product Control Section (In Miami Dade County) and/or the AHJ (in areas other than Miami Dade County) reserve the right to have this product or material tested for quality assurance purposes. If this product or material fails to perform in the accepted manner, the manufacturer will incur the expense of such testing and the AHJ may immediately revoke, modify, or suspend the use of such product or material within their jurisdiction. RER reserves the right to revoke this acceptance, if it is determined by Miami-Dade County Product Control Section that this product or material fails to meet the requirements of the applicable building code.

This product is approved as described herein, and has been designed to comply with the Florida Building Code, including the High Velocity Hurricane Zone.

#### DESCRIPTION: "351 Series" Outswing Aluminum Entrance Door w/wo Transom -LMI

**APPROVAL DOCUMENT:** Drawing No. **AD15-23**, titled "351 Series Alum Outswing Doors w/wo Transom (Large Missile Impact)", sheets 1 through 17 of 17, dated 03/24/15, with revision "1" dated 02/11/2020, signed and sealed by Yiping Wang, P.E, bearing the Miami-Dade County Product Control Revision stamp with the Notice of Acceptance number and expiration date by the Miami-Dade County Product Control Section.

## MISSILE IMPACT RATING: Large and Small Impact Limitations:

- 1. See water limitations in sheet 8, 9 & 13.
- 2. Lower DP shall control, when doors w/wo transom is mulled to Storefront (under Separate approval), Full length Steel reinforcement is required, the tributary load, the mullion end anchors to be reviewed by Bldg. official.

**LABELING:** Each unit shall bear a permanent label with the manufacturer's name or logo, city, state and series and following statement: "Miami-Dade County Product Control Approved", unless otherwise noted herein.

**RENEWAL** of this NOA shall be considered after a renewal application has been filed and there has been no change in the applicable building code negatively affecting the performance of this product.

**TERMINATION** of this NOA will occur after the expiration date or if there has been a revision or change in the materials, use, and/or manufacture of the product or process. Misuse of this NOA as an endorsement of any product, for sales, advertising or any other purposes shall automatically terminate this NOA. Failure to comply with any section of this NOA shall be cause for termination and removal of NOA.

**ADVERTISEMENT:** The NOA number preceded by the words Miami-Dade County, Florida, and followed by the expiration date may be displayed in advertising literature. If any portion of the NOA is displayed, then it shall be done in its entirety.

**INSPECTION:** A copy of this entire NOA shall be provided to the user by the manufacturer or its distributors and shall be available for inspection at the job site at the request of the Building Official.

This NOA revises and renews NOA #17-1017.13 and consists of this page 1 and evidence pages E-1, E-2 and E-3, as well as approval document mentioned above.

The submitted documentation was reviewed by Sifang Zhao, P.E.



*5,2*. 07/16/2020

NOA No. 20-0424.01 Expiration Date: June 04, 2025 Approval Date: July 16, 2020 Page 1

#### **Trulite Glass & Aluminum Solutions, LLC**

#### NOTICE OF ACCEPTANCE: EVIDENCE SUBMITTED

#### 1. EVIDENCE SUBMITTED UNER PREVIOUS NOA'S

#### A. DRAWINGS

- 1. Manufacturer's die drawings and sections. (Submitted under NOA#14-0225.02).
- 2. Drawing No. **AD-1523**, titled "351 Series Alum Outswing Dry-Glazed Doors w/wo Transom (Large Missile Impact)", sheets 1 through 11 of 11, dated 03/24/15, prepared, signed and sealed by Yiping Wang, P.E. on 09/29/17.

#### B. TESTS

- 1. Test reports on: 1) Air Infiltration Test, per FBC, TAS 202-94
  - 2) Uniform Static Air Pressure Test, Loading per FBC TAS 202-94
  - 3) Water Resistance Test, per FBC, TAS 202-94
  - 4) Large Missile Impact Test per FBC, TAS 201-94
  - 5) Cyclic Wind Pressure Loading per FBC, TAS 203-94
  - 6) Forced Entry Test, per FBC 2411 3.2.1, TAS 202-94

along with marked-up drawings and installation diagram of an outswing aluminum entrance door w/wo Transoms, prepared by Fenestration Testing Lab, Test Report No(s). **FTL 7458**, dated 10/15/13, with addendum letter dated 04/09/14, signed and sealed by Marlin D. Brinson, P.E. (Submitted under NOA#14-0225.02).

#### C. CALCULATIONS

- 1. Anchor verification calculations and structural analysis, complying with FBC2014, prepared by MCY Engineering, Inc., dated FEB 15, 2015 and last revised on 04/28/15, signed and sealed by Yiping Wang, P.E.
- 2. Glazing complies w/ ASTME-1300-02 & -04

#### D. QUALITY ASSURANCE

1. Miami Dade Department of Regulatory and Economic Resources (RER).

#### E. MATERIAL CERTIFICATIONS

1. NOA No. **14-0916.11** issued to Kuraray America., Inc. for their "SentryGlas" (Clear and White) Interlayer", expiring on 07/04/18.

#### F. STATEMENTS

- 1. Statement letter of conformance to FBC 5<sup>th</sup> Edition (2014) and FBC 6<sup>th</sup> Edition (2017), and no financial interest, prepared by MCY Engineering, Inc., dated 09/29/17, signed and sealed by Yiping Wang, P.E.
- 2. Statement letter of Lab compliance, part of above referenced test reports.
- 3. Test Proposal # **12-1089** dated DEC 10, 2012, issued by PERA.

#### G. OTHER

1. This NOA revises NOA #14-0225.02, expiring on 06/04/20.

Sifang Zhao, P.E. Product Control Examiner NOA No. 20-0424.01 Expiration Date: June 04, 2025

Approval Date: July 16, 2020

#### Trulite Glass & Aluminum Solutions, LLC

#### **NOTICE OF ACCEPTANCE: EVIDENCE SUBMITTED**

#### 2. NEW EVIDENCE SUBMITTED

#### A. DRAWINGS

1. Drawing No. **AD15-23**, titled "351 Series Alum Outswing Doors w/wo Transom (Large Missile Impact)", sheets 1 through 17 of 17, dated 03/24/15, with revision "1" dated 02/11/2020, prepared, signed and sealed by Yiping Wang, P.E.

#### B. TESTS

- 1. Test reports on: 1) Air Infiltration Test, per FBC, TAS 202-94
  - 2) Uniform Static Air Pressure Test, Loading per FBC TAS 202-94
  - 3) Large Missile Impact Test per FBC, TAS 201-94
  - 4) Cyclic Wind Pressure Loading per FBC, TAS 203-94

along with marked-up drawings and installation diagram of an outswing aluminum entrance door w/wo Transoms, prepared by Fenestration Testing Lab, Test Report No(s). **FTL-10168**, **FTL-9378**, dated 01/31/2020, signed and sealed by Idalmis Ortega, P.E.

- 2. Test reports on: 1) Air Infiltration Test, per FBC, TAS 202-94
  - 2) Uniform Static Air Pressure Test, Loading per FBC TAS 202-94
  - 3) Large Missile Impact Test per FBC, TAS 201-94
  - 4) Cyclic Wind Pressure Loading per FBC, TAS 203-94
  - 5) Forced Entry Test, per FBC 2411 3.2.1, TAS 202-94

along with marked-up drawings and installation diagram of an outswing aluminum entrance door w/wo Transoms, prepared by Fenestration Testing Lab, Test Report No(s). **FTL-9867**, **FTL-8757** and **FTL-9689**, dated 01/31/2020, signed and sealed by Idalmis Ortega, P.E.

#### C. CALCULATIONS

- 1. Anchor verification calculations and structural analysis, complying with FBC 6<sup>th</sup> (2017) and FBC 7<sup>th</sup> (2020) editions, prepared by MCY Engineering, Inc., dated June 02, 2020, signed and sealed by Yiping Wang, P.E.
- 2. Glazing complies w/ ASTME-1300-09 & -12

#### D. QUALITY ASSURANCE

1. Miami Dade Department of Regulatory and Economic Resources (RER).

#### E. MATERIAL CERTIFICATIONS

- 1. NOA No. **17-0808.02** issued to **Kuraray America**, **Inc.** for their "**SentryGlas**® (**Clear and White**) **Glass Interlayers**" dated 12/28/17, expiring on 07/04/23.
- 2. NOA No. **17-0712.05** issued to **Eastman Chemical Company (MA)** for their "**Saflex PVB Clear and Color Glass Interlayers**" dated 09/07/17, expiring on 05/21/21.

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Sifang Zhao, P.E. Product Control Examiner NOA No. 20-0424.01 Expiration Date: June 04, 2025

Approval Date: July 16, 2020

Attachment H

#### Trulite Glass & Aluminum Solutions, LLC

#### **NOTICE OF ACCEPTANCE: EVIDENCE SUBMITTED**

#### F. STATEMENTS

- 1. Statement letter of conformance to FBC 6<sup>th</sup> Edition (2017) and FBC 7<sup>th</sup> Edition (2020), and no financial interest, prepared by MCY Engineering, Inc., dated 06/02/2020 signed and sealed by Yiping Wang, P.E.
- 2. Test Proposal # **14-1349 Rev** #**1** dated 05/13/2015, issued by RER.

#### G. OTHER

1. This NOA revises and renews NOA #17-1017.13, expiring on 06/04/20.

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Sifang Zhao, P.E. Product Control Examiner NOA No. 20-0424.01 Expiration Date: June 04, 2025

Approval Date: July 16, 2020

### TRULITTE GLASS & ALUMINUM SOLUTION SERIES 351 ALUMINUM OUT SWING DOORS LARGE MISSILE IMPACT

- THIS PRODUCT HAS BEEN DESIGNED AND TESTED TO COMPLY WITH THE REQUIREMENTS OF THE FLORIDA BUILDING CODE 2017 6TH / 2020 7TH EDITION INCLUDING HIGH VELOCITY HURRICANE ZONE (HVHZ).
- DOORS ARE RATED LARGE MISSILE IMPACT. SHUTTERS OR EXTERNAL PROTECTION DEVICES IS NOT REQUIRED.
- DOOR TESTED FOR IMPACT LEVEL D
- ULTIMATE DESIGN LOAD OBTAINED FROM ASCE 7-10/16, MULTIPLY BY 0.6, SHALL BE LESS THAN OR EQUAL TO MAX. DESIGN LOAD IN THE DOCUMENT.
- FOR WATER INFILTRATION RATINGS, SEE LIMITATION ON SHEET A1.
- 1X OR 2X WOOD BUCKS BY OTHERS, MUST BE ANCHORED PROPERLY TO TRANSFER LOADS TO THE STRUCTURE, TO BE REVIEWED BY BUILDING OFFICIAL.
- ANCHORING OR LOADING CONDITIONS NOT SHOWN IN THESE DETAILS ARE NOT PART OF THIS APPROVAL.

- A LOAD DURATION INCREASE IS USED IN DESIGN OF ANCHORS INTO WOOD ONLY.
- MATERIALS INCLUDING BUT NOT LIMITED TO STEEL/METAL SCREWS, THAT COME INTO CONTACT WITH OTHER DISSIMILAR MATERIALS SHALL MEET THE REQUIREMENTS OF 2017 6TH EDITION FLORIDA BUILDING CODE SECTION AS APPLICABLE.
- ANCHORS SHALL BE AS LISTED, SPACED AS SHOWN ON DETAILS. ANCHORS EMBEDMENT TO BASE MATERIAL SHALL BE BEYOND WALL DRESSING OR STUCCO.
- LIMITATION: WHEN DOORS OR DOOR WITH TRANSOM ARE MULLED TO STOREFRONT (UNDER SEPARATE APPROVAL) LOWER DESIGN PRESSURE FROM DOOR, DOOR WITH TRANSOM OR STOREFRONT SHALL GOVERN IN THE ENTIRE ASSEMBLY.
- WHERE APPLICABLE: EGRESS REQUIREMENTS TO BE REVIEWED BY BUILDING OFFICIAL.

#### DRAWING INDEX

SHEET DESCRIPTION REVISION					
COVER	COVER				
G1	GLASS OPTION				
E01	ELEVATIONS				
E02	ELEVATIONS				
E03	ELEVATIONS				
E04	ELEVATIONS				
E05	ELEVATIONS				
D1	DETAILS				
D2	DETAILS				
D3	DETAILS				
D4	DETAILS				
D5	DETAILS				
A1	ANCHOR TYPES				
H1	HARDWARE				
BOM	BILL OF MATERIALS				
P01	PARTS				
ISO	ISOMETRIC				

#### ABBREVIATIONS AND SYMBOLS

D.L.O. - DAYLITE OPENING F.H. - FRAME HEIGHT F.W. - FRAME WIDTH LG. - LONG

STL. - STEEL ALUM. - ALUMINUM MULL. - MULLION HORIZ. - HORIZONTAL

W/ - WITH W/O - WITHOUT

- VERTICAL VERT.

S.S. - STAINLESS STEEL H.S. - HEAT STRENGTHENED SSG - STRUCTURAL SILICONE GLAZED TEMP. - TEMPERED

O.C. - ON CENTER

DETAIL NUMBER

SHEET NUMBER

http://www.trulite.com

403 WESTPARK CT. SUITE 201 PEACHTREE CITY, GA 30269 p. 800-432-8132 | f. 954-724-2083

PRODUCT:

#### 351 SERIES **ALUM OUTSWING DOORS**


W/ OR W/O TRANSOM (LARGE MISSILE IMPACT)

REVN	DATE/REMARKS
REV 01	02/11/2020

ENGINEER:



**GLAZING CONSULTANT** 12871 Miramar Pkwy Ste. 301 Miramar, FL 33027 P: 305-271-0117 Email: MCY.Engineering@att.net www.MCYEngineering.com

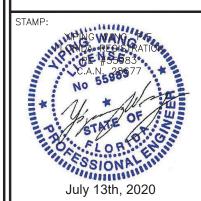

PRODUCT CONTROL APPROVAL:

PRODUCT REVISED as complying with the Florida Building Code NOA-No. 20-0424.01 NOA-No.

Expiration Date 06/04/2025


00 Miami-Dade Product Control

SHEET TITLE COVER

DRAWN: FRANK

DWG: AD15-23

DRAWING No: DATE: 03-24-15

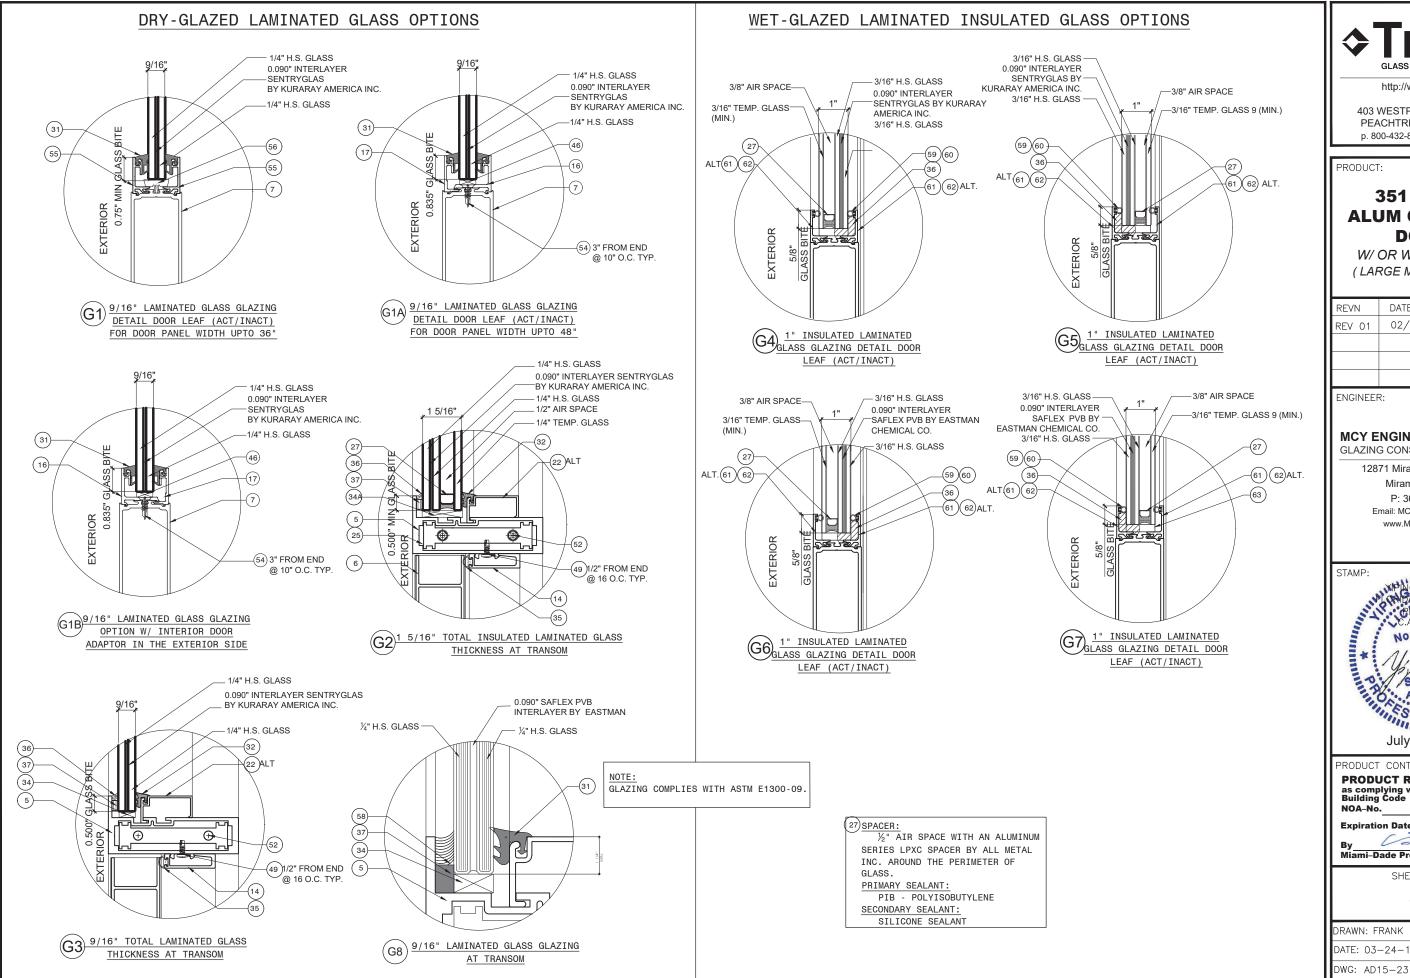

http://www.trulite.com

403 WESTPARK CT. SUITE 201 PEACHTREE CITY, GA 30269 p. 800-432-8132 | f. 954-724-2083

PRODUCT:

#### 351 SERIES **ALUM OUTSWING DOORS**

W/ OR W/O TRANSOM (LARGE MISSILE IMPACT)

REVN	DATE/REMARKS
REV 01	02/11/2020

ENGINEER:

#### MCY ENGINEERING, INC. **GLAZING CONSULTANT**

12871 Miramar Pkwy Ste. 301 Miramar, FL 33027 P: 305-271-0117 Email: MCY.Engineering@att.net www.MCYEngineering.com

M

"ILSSIONALINI July 13th, 2020

PRODUCT CONTROL APPROVAL:

PRODUCT REVISED <sup>e</sup> 20-0424.01 NOA-No.

Expiration Date 06/04/2025 00


By Miami-Dade Product Control

SHEET TITLE

G1

DRAWN: FRANK DATE: 03-24-1 DRAWING No:

#### Attachment H

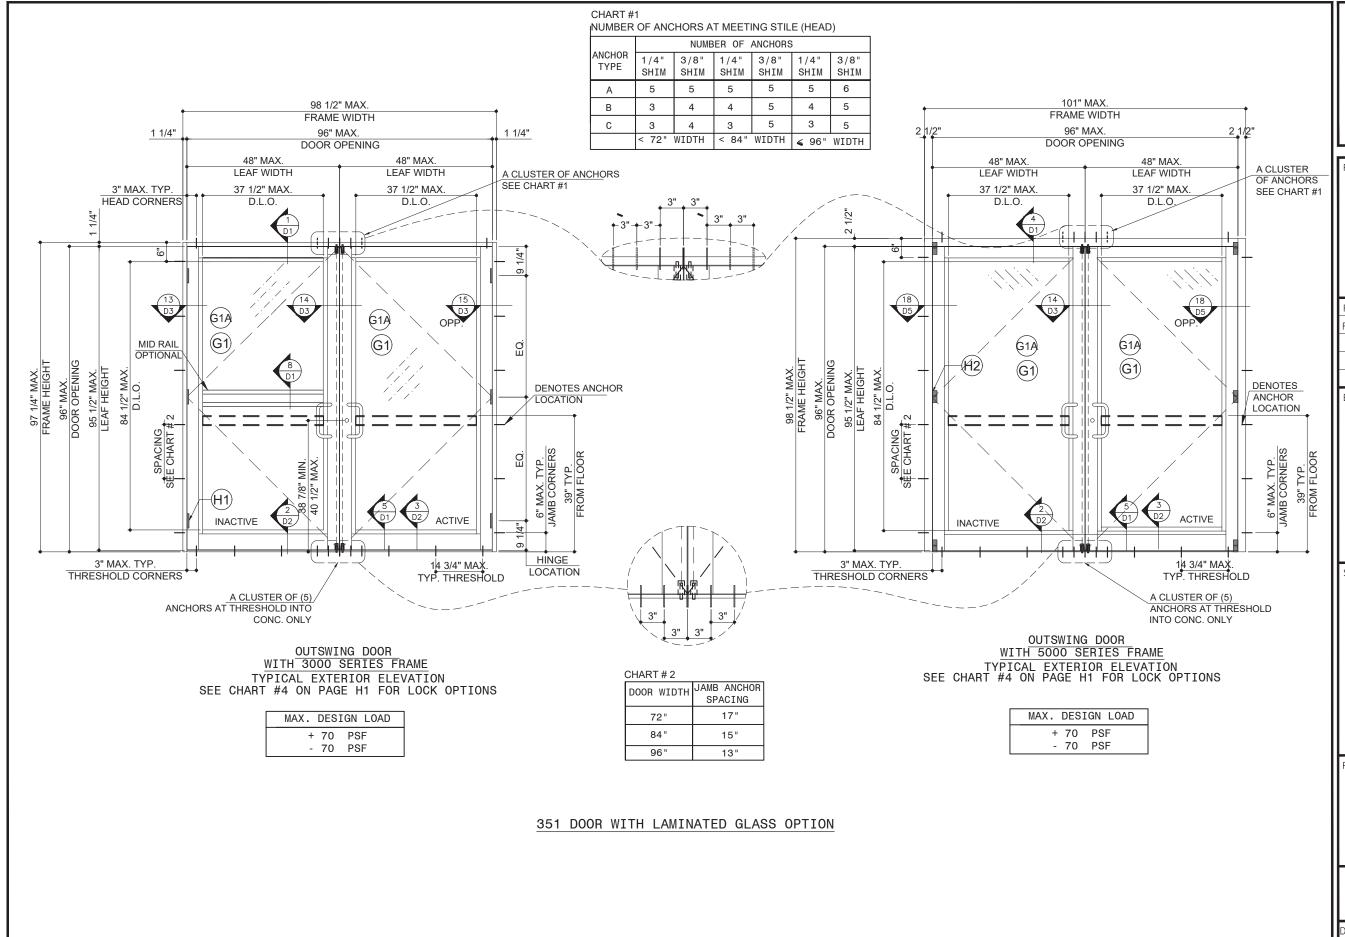



http://www.trulite.com

403 WESTPARK CT. SUITE 201 PEACHTREE CITY, GA 30269 p. 800-432-8132 | f. 954-724-2083

PRODUCT:

#### 351 SERIES **ALUM OUTSWING DOORS**

W/ OR W/O TRANSOM (LARGE MISSILE IMPACT)

REVN	DATE/REMARKS
REV 01	02/11/2020

ENGINEER:

#### MCY ENGINEERING, INC. **GLAZING CONSULTANT**

12871 Miramar Pkwy Ste. 301 Miramar, FL 33027 P: 305-271-0117

Email: MCY.Engineering@att.net www.MCYEngineering.com

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PRODUCT CONTROL APPROVAL:

PRODUCT REVISED
as complying with the Florida
Building Code 20-0424.01

Expiration Date 06/04/2025


Miami-Dade Product Control

SHEET TITLE

E01

DRAWING No: DRAWN: FRANK DATE: 03-24-1:

DWG: AD15-23

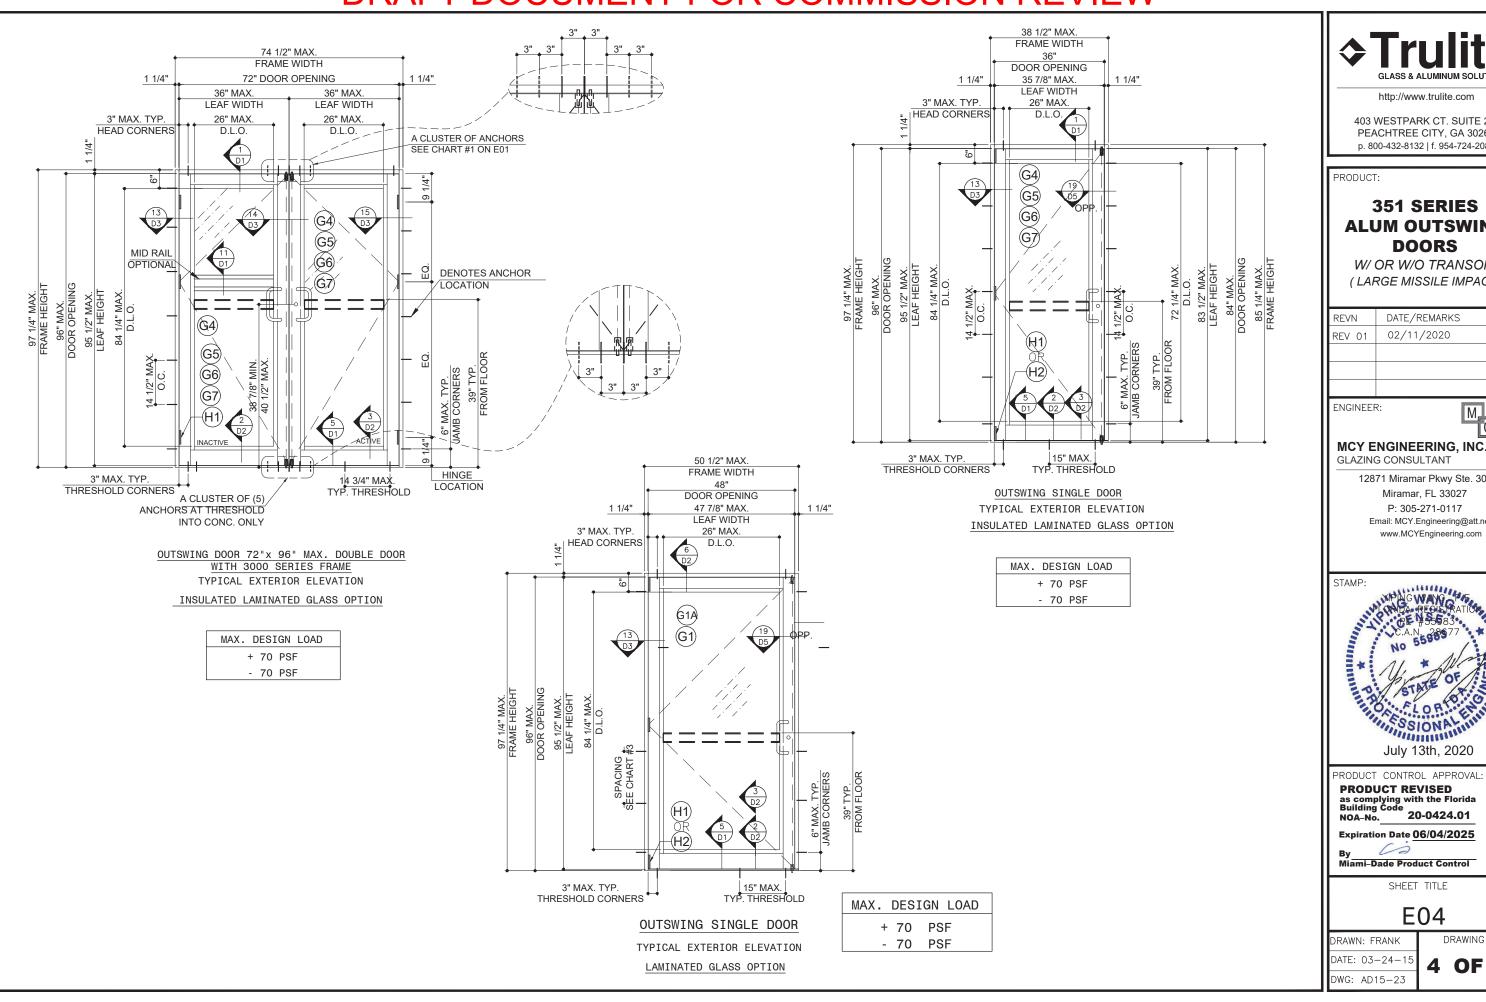



403 WESTPARK CT. SUITE 201 PEACHTREE CITY, GA 30269 p. 800-432-8132 | f. 954-724-2083

## 351 SERIES **ALUM OUTSWING**

W/ OR W/O TRANSOM (LARGE MISSILE IMPACT)

REVN	DATE/REMARKS
REV 01	02/11/2020

## MCY ENGINEERING, INC.

12871 Miramar Pkwy Ste. 301 Miramar, FL 33027 P: 305-271-0117 Email: MCY.Engineering@att.net

www.MCYEngineering.com


July 13th, 2020

as complying with the Florida Building Code NOA-No. 20-0424.01

Miami-Dade Product Control

DRAWING No:

#### Attachment H

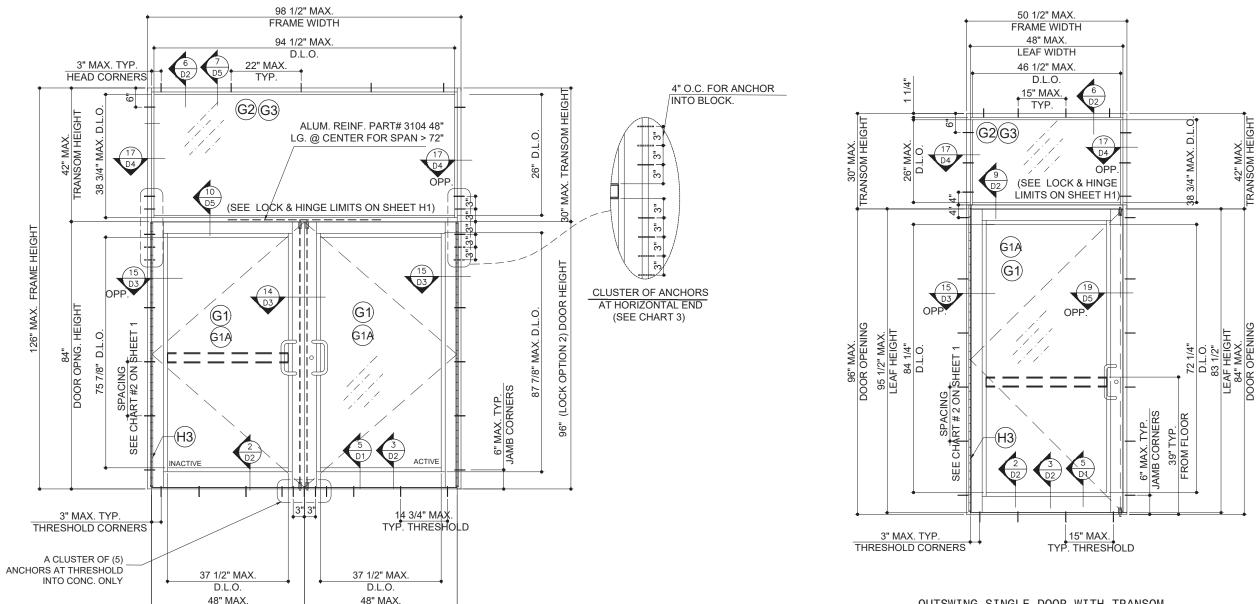

OUTSWING DOOR WITH TRANSOM TYPICAL EXTERIOR ELEVATION SEE CHART #4 ON PAGE H1 FOR LOCK OPTIONS

96" DOOR OPENING

LEAF WIDTH

LEAF WIDTH


MAX. DESIGN LOAD + 70 PSF - 70 PSF

CHART #3 NUMBER OF ANCHORS AT TRANSOM END

	NUMBER OF ANCHORS					
ANCHOR TYPÆ	1/4" SHIM	3/8" SHIM	1/4" SHIM	3/8"	1/4"	3/8"
· · · A	SUTIN	OTITIVI	OTITIVI	SHIM	SHIM	SHIM
В	4	4	5	5	5	5
	3	4	6	5	6	5
B**	4	4	5	5	6	5
	2	3	3	4	3	4
≼ 72" WIDTH			<b>≼</b> 84'	' WIDTH	<b>≼</b> 96"	WIDTH

\*\* into CMU with ultracon only

351 DOOR WITH LAMINATED GLASS OPTION

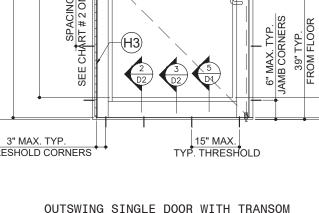

MAX. DESIGN LOAD

+ 70 PSF

- 70 PSF

TYPICAL EXTERIOR ELEVATION



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PRODUCT:

#### 351 SERIES **ALUM OUTSWING DOORS**

W/ OR W/O TRANSOM (LARGE MISSILE IMPACT)

REVN	DATE/REMARKS
REV 01	02/11/2020

ENGINEER:

#### M.C. MCY ENGINEERING, INC. **GLAZING CONSULTANT**

12871 Miramar Pkwy Ste. 301 Miramar, FL 33027 P: 305-271-0117 Email: MCY.Engineering@att.net www.MCYEngineering.com

SSIONALINI July 13th, 2020

RODUCT CONTROL APPROVAL:

PRODUCT REVISED as complying with the Florida Building Code NOA-No. 20-0424.01

Expiration Date 06/04/2025

Miami-Dade Product Control

SHEET TITLE


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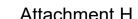
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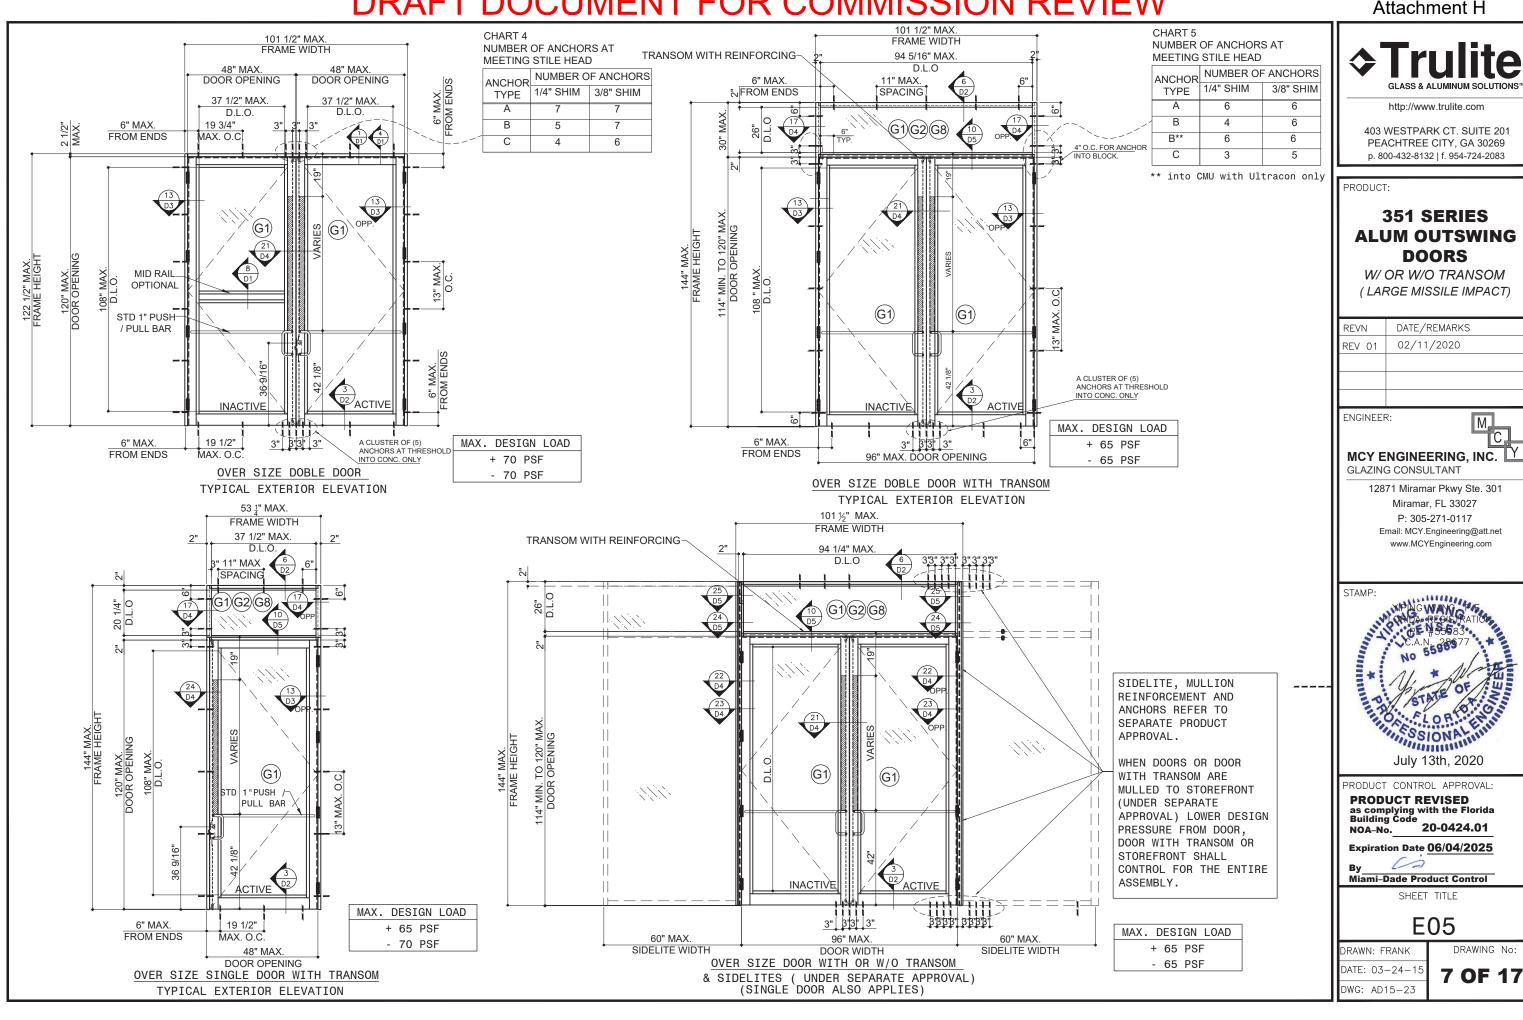
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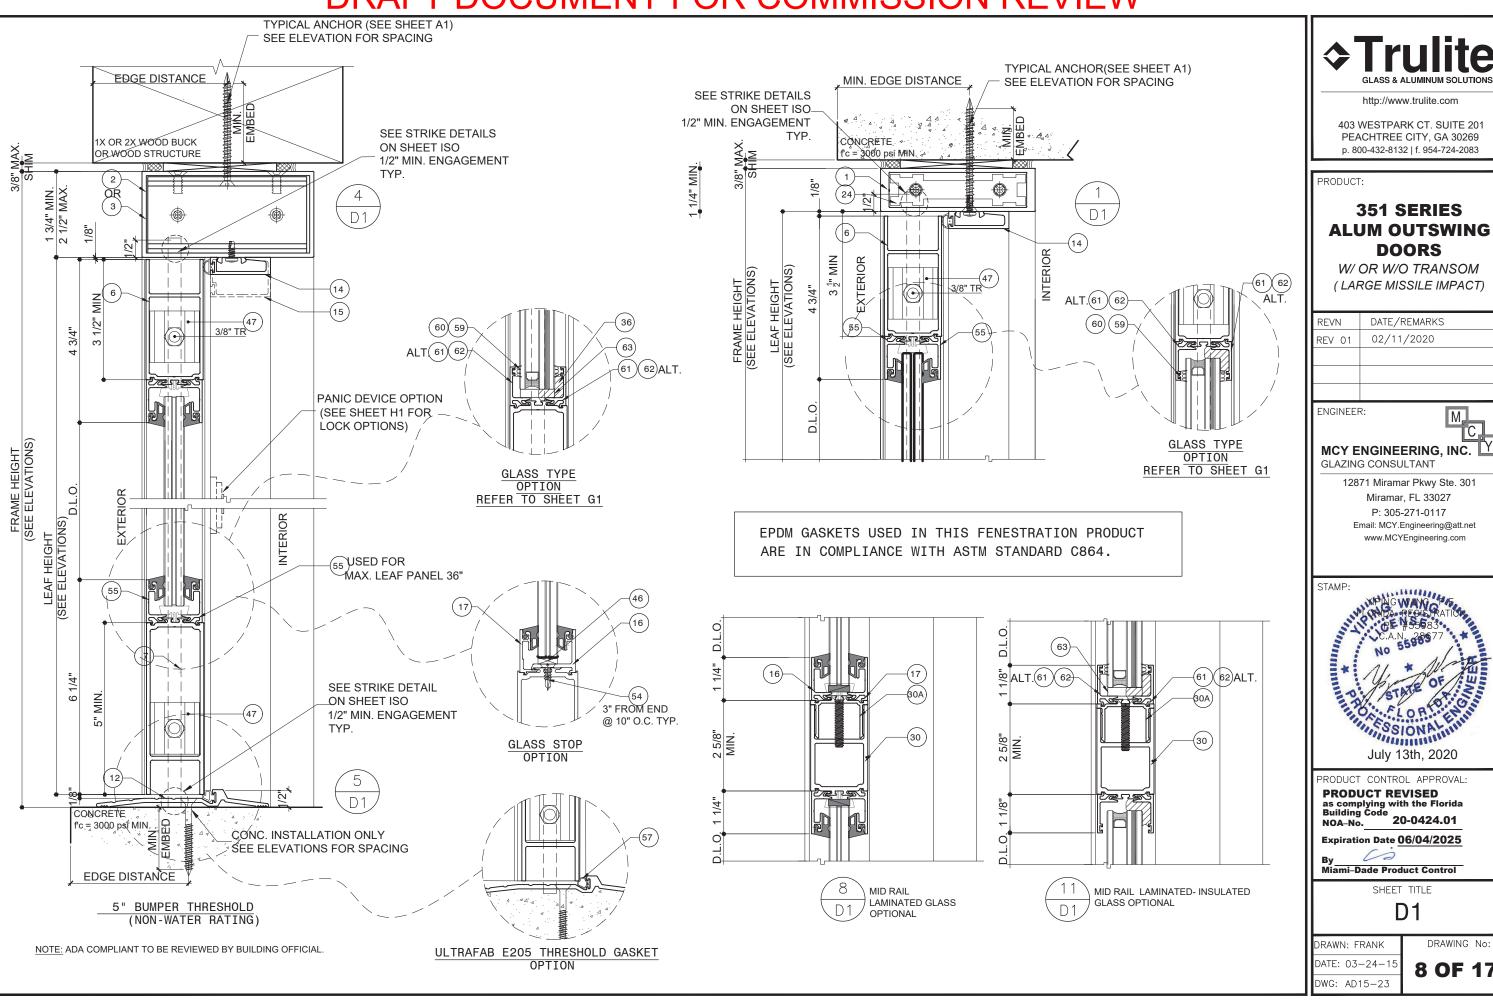
5 OF 17 DWG: AD15-23

DRAWING No:







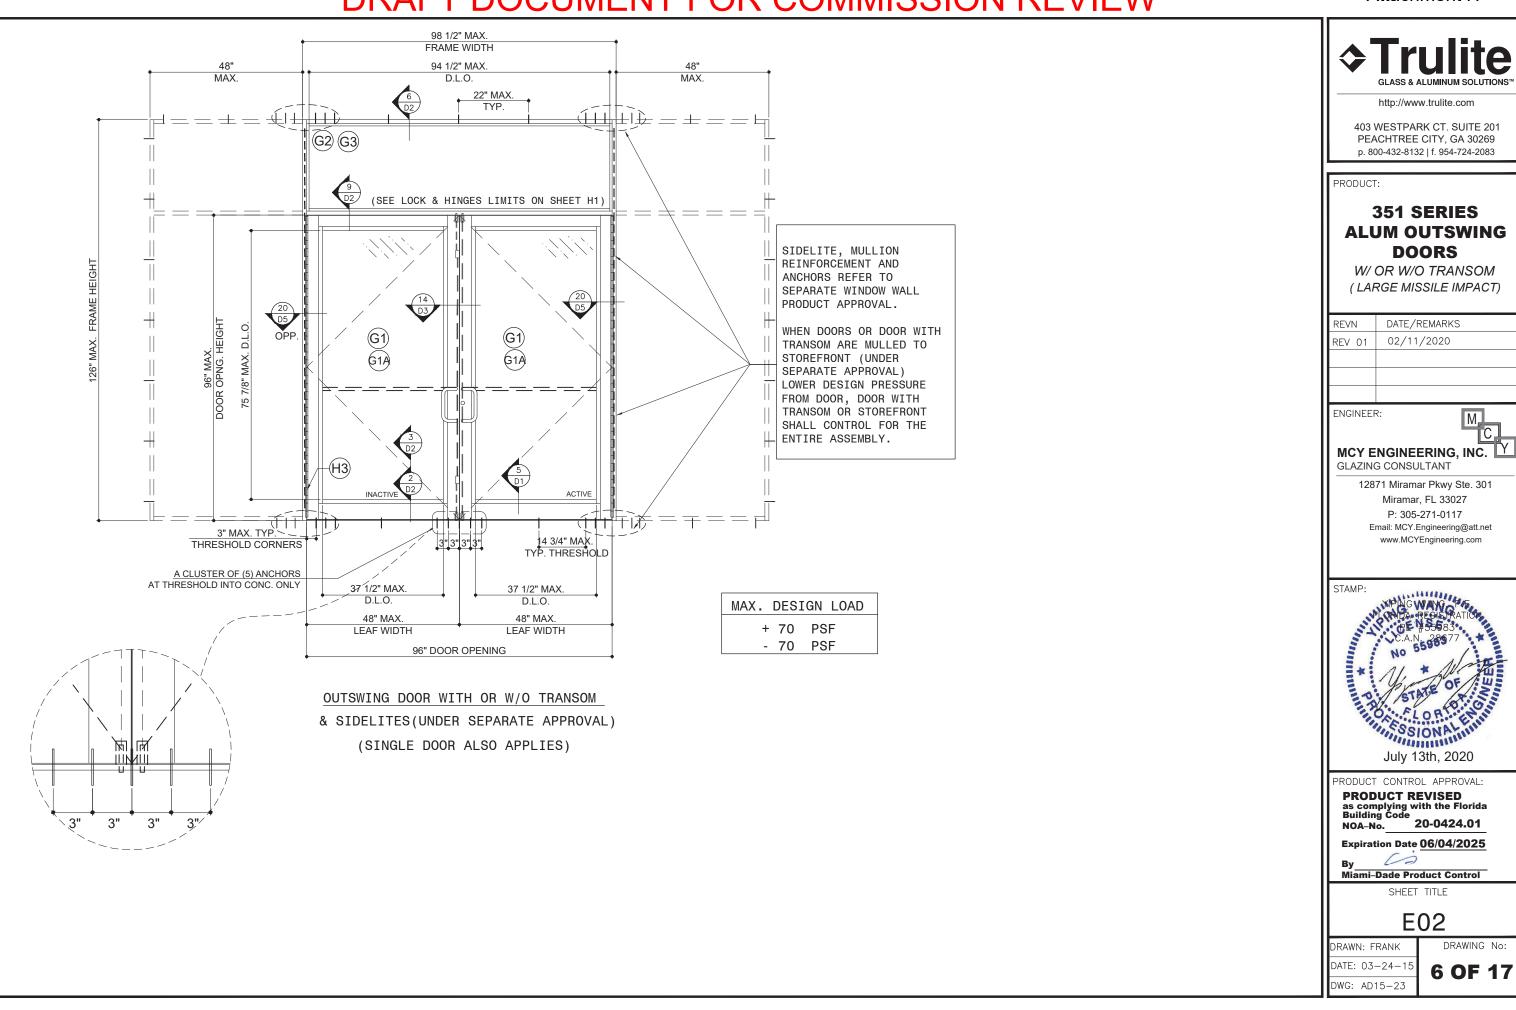



PEACHTREE CITY, GA 30269 p. 800-432-8132 | f. 954-724-2083

#### 351 SERIES **ALUM OUTSWING DOORS**

W/ OR W/O TRANSOM (LARGE MISSILE IMPACT)

REVN	DATE/REMARKS
REV 01	02/11/2020

## M.C. MCY ENGINEERING, INC.


12871 Miramar Pkwy Ste. 301 Miramar, FL 33027 P: 305-271-0117 Email: MCY.Engineering@att.net


www.MCYEngineering.com



RODUCT CONTROL APPROVAL:

as complying with the Florida Building Code NOA-No. 20-0424.01

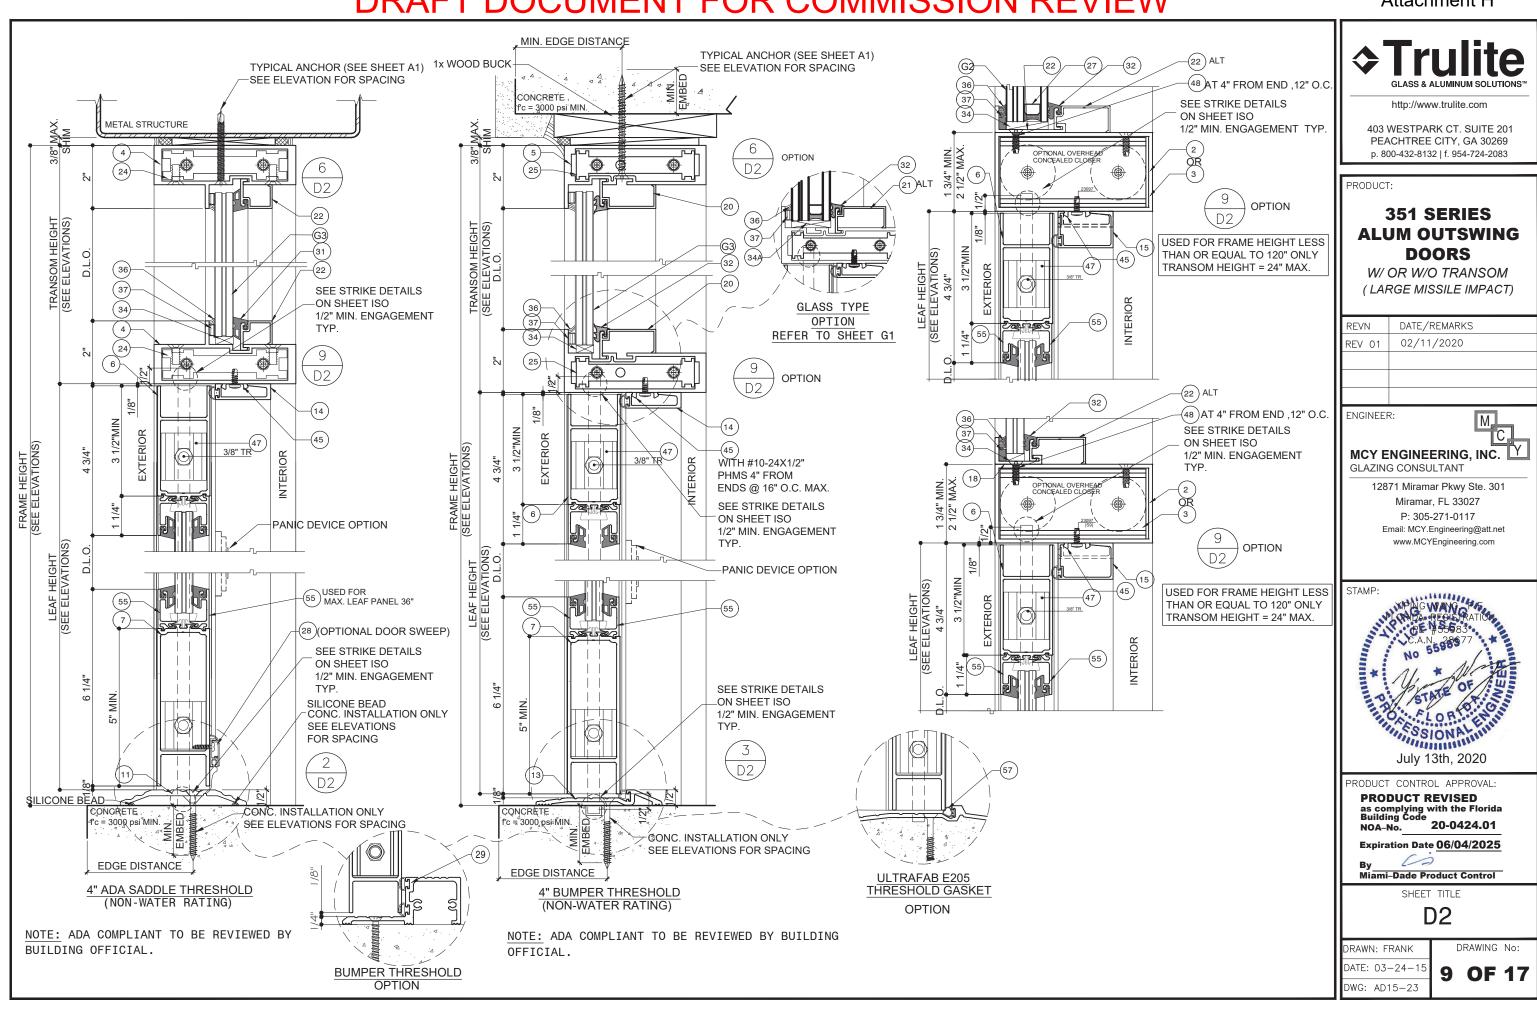

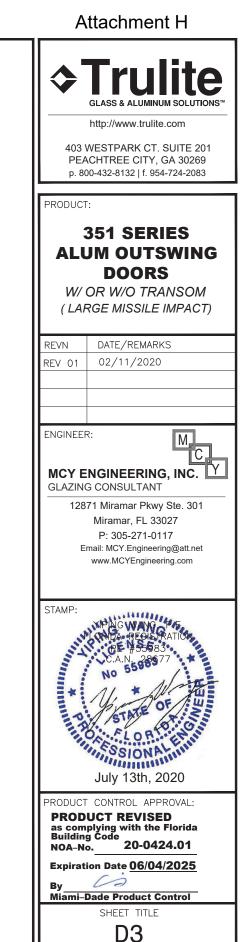



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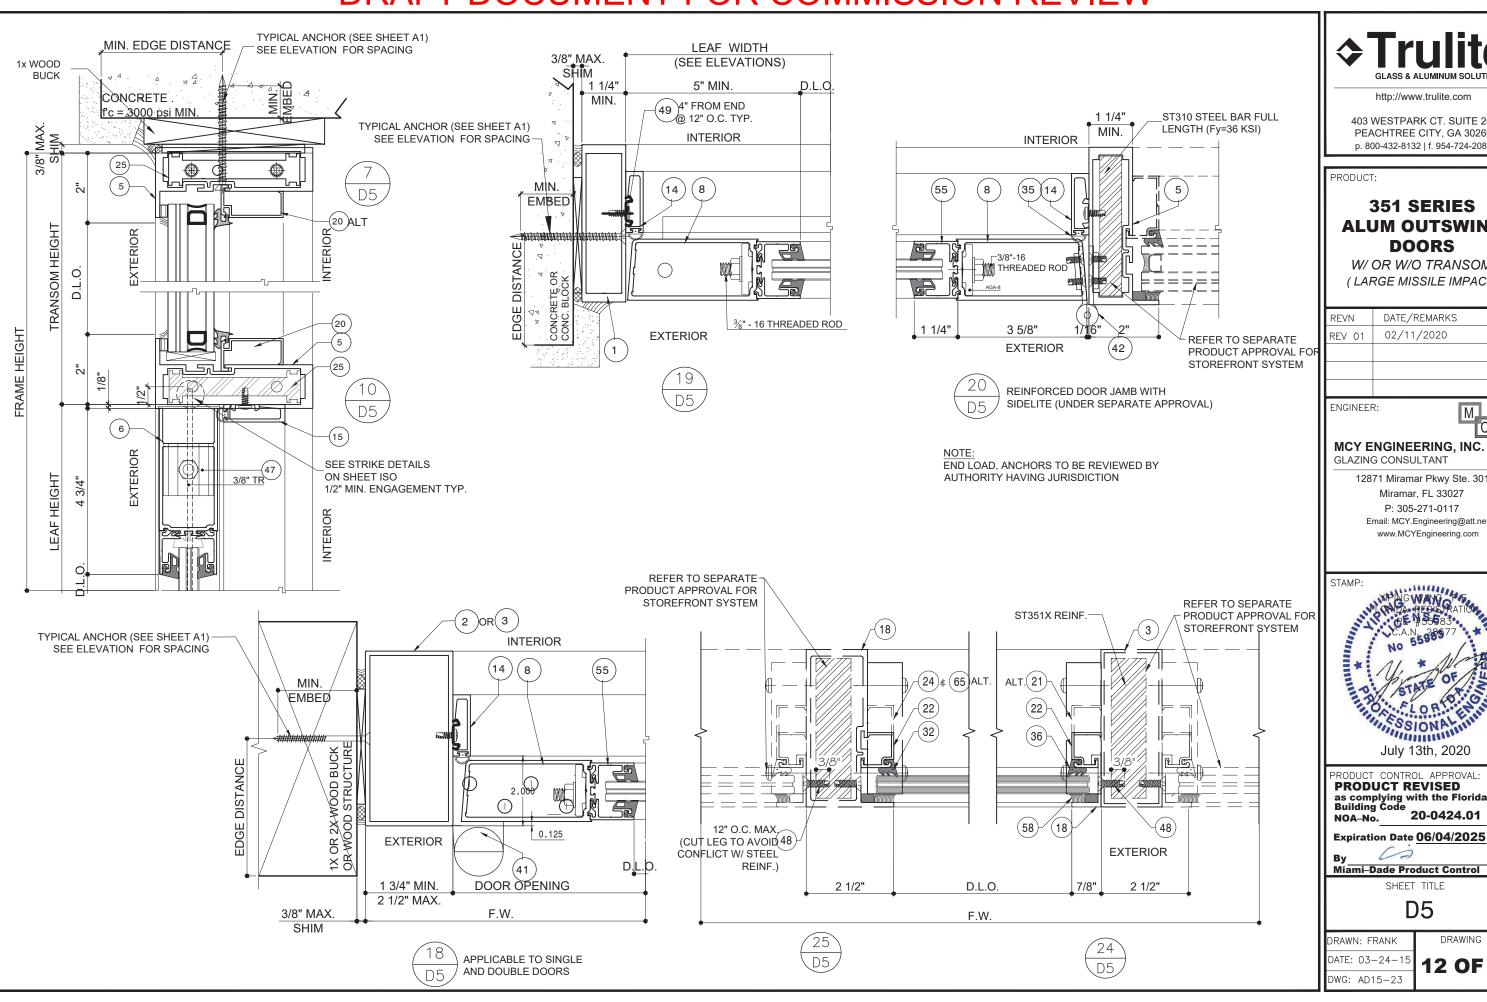
10 OF 17

DRAWN: FRANK DATE: 03-24-1

DWG: AD15-23



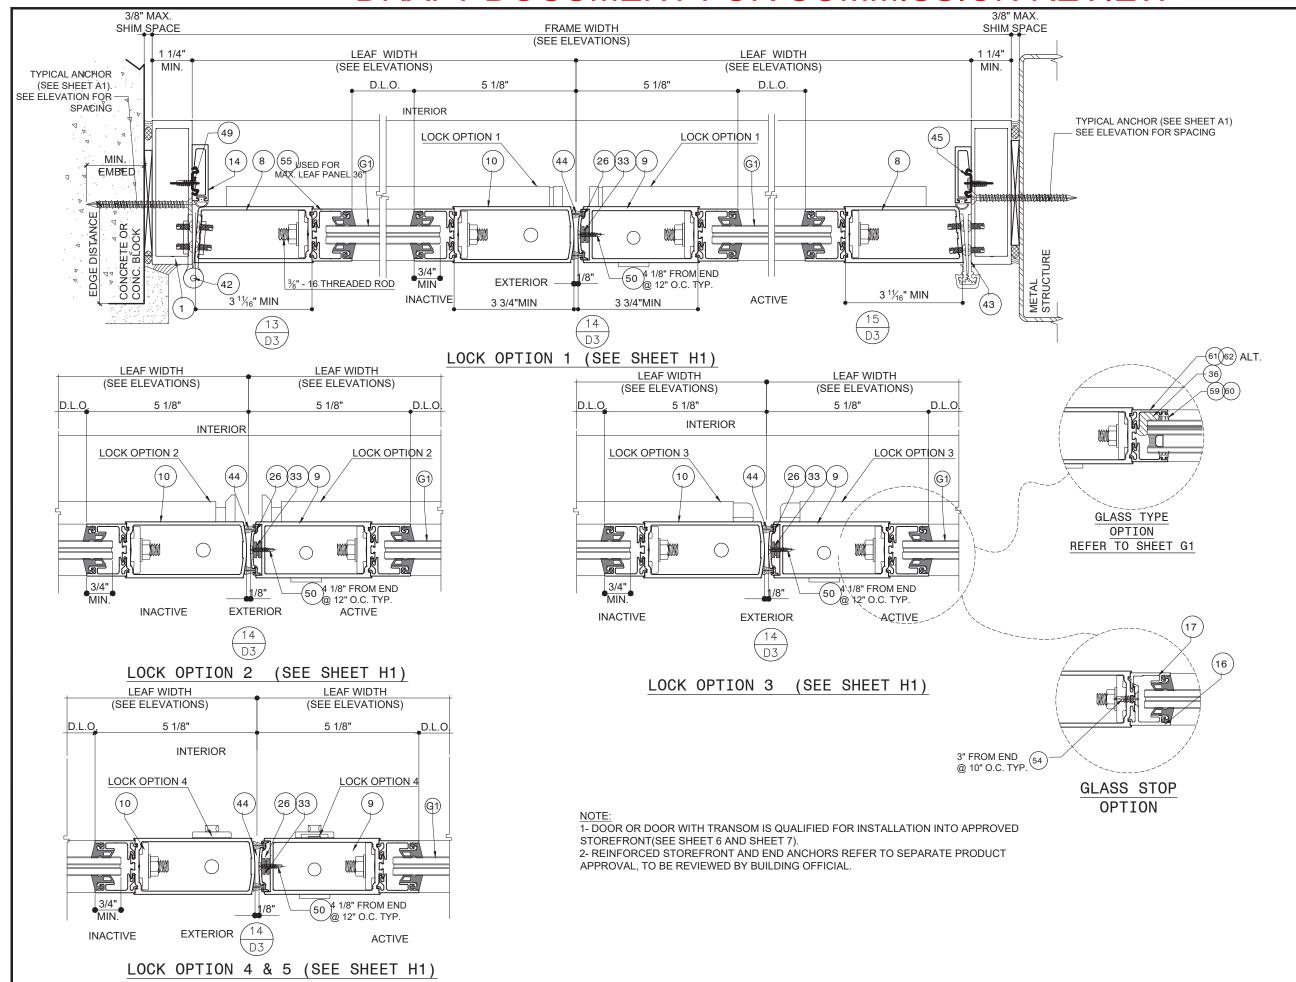

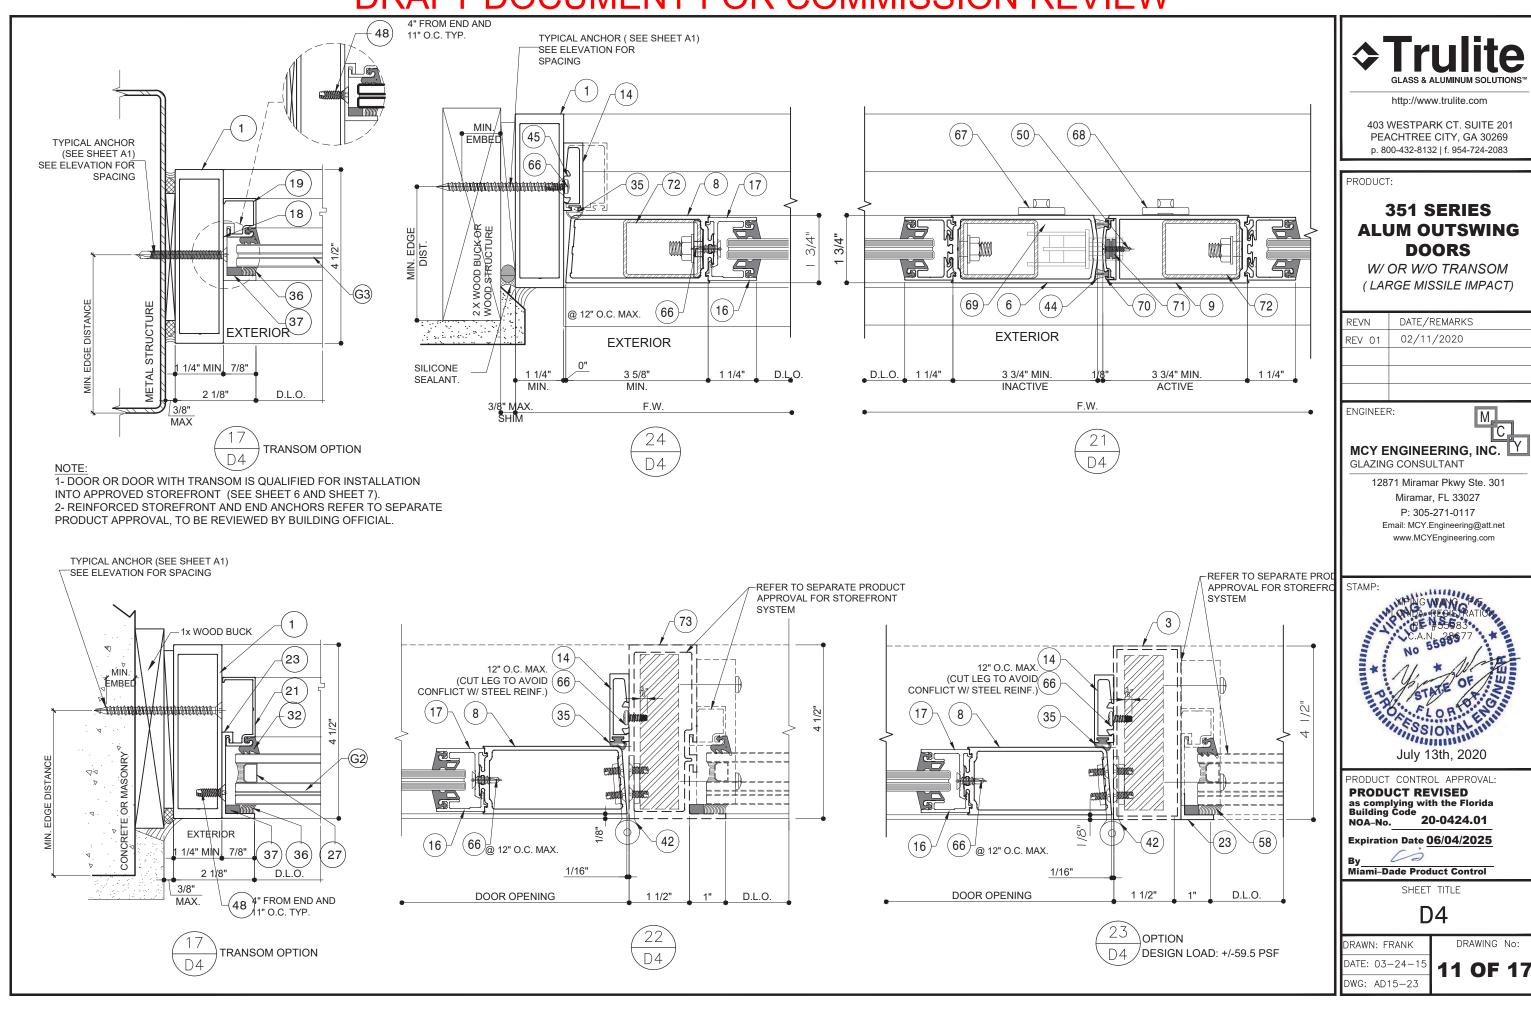



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#### 351 SERIES **ALUM OUTSWING DOORS**

W/ OR W/O TRANSOM (LARGE MISSILE IMPACT)

REVN	DATE/REMARKS
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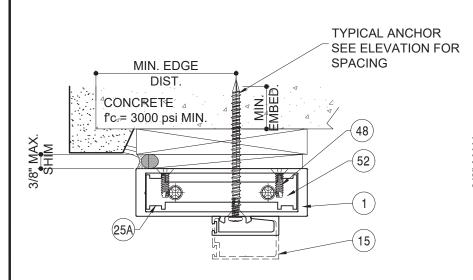



as complying with the Florida Building Code NOA-No. 20-0424.01

Expiration Date 06/04/2025

DRAWING No:

12 OF 17



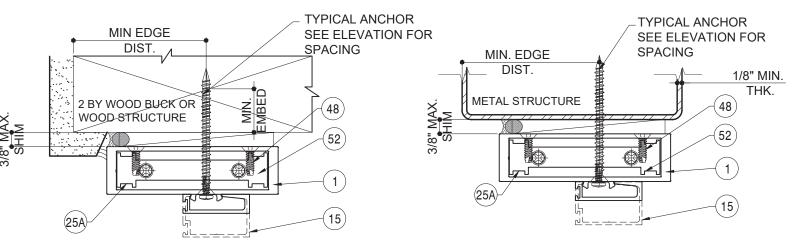

#### TYPICAL ANCHORS: SEE ELEV. FOR SPACING

TYPE A: 1/4" DIA. ELCO ULTRACON (Fu=177 ksi Fy=120 ksi) OR 1/4" DIA. TAPCON (Fu=120 ksi Fv=92 ksi)

• THRU 1BY OR 2BY WOOD BUCKS

1-3/4" MIN. EMBED INTO CONC.@ HEAD/SILL

1-3/4" MIN. EMBED INTO GROUT FILLED BLOCK @ JAMB

1-1/4" MIN. EMBED INTO HOLLOW BLOCK @ JAMB

INTO 2X WOOD BUCKS OR WOOD STRUCTURAL

1-1/2" MIN. EMBED @ HEAD AND JAMB

TYPE B: 1/4" DIA. ELCO ULTRACON (Fu=177 ksi Fy=120 ksi) OR 1/4" DIA. ITW TAPCON (Fu=120 ksi Fy=92 ksi)

DIRECTLY INTO CONCRETE, GROUT FILLED BLOCK OR HOLLOW BLOCK.

1-3/4" MIN. EMBED INTO CONCRETE @ HEAD/SILL

1-3/4" MIN. EMBED INTO GROUT FILLED BLOCK @ JAMB

1-1/4" MIN. EMBED INTO HOLLOW BLOCK @ JAMB

TYPE C: 1/4" TEK OR SELF DRILLING SCREWS(GRADE 5 FU=120ksi FY=92ksi)

• INTO METAL STRUCTURES (HEAD/JAMB)

STEEL: 1/8" MIN. THICKNESS (Fy = 36 ksi MIN.) ALUMINUM: 1/8" THK. MIN. (6063-T5 MIN.)

(STEEL IN CONTACT WITH ALUMINUM TO BE PLATED OR PAINTED)

#### MIN. EDGE DISTANCES

INTO CONCRETE AND MASONRY = 2 1/2" INTO WOOD STRUCTURE = 1" INTO METAL STRUCTURE = 3/4"

#### SUBSTRATE

CONCRETE f'c = 3000 PSI MIN. MASONRY C-90 f'c = 2000 PSI MIN. WOOD SG= 0.55


#### SEALANTS:

ALL FRAME AND PANEL JOINT, INSTALLATION SCREWS AND HEADS OF ANCHOR SCREWS AT SILL TO BE SEALED WITH CLEAR SEALANT.

1X OR 2X WOOD BUCKS AND METAL STRUCTURES BY OTHERS MUST SUPPORT LOADS IMPOSED BY GLAZING SYSTEMS AND TRANSFER THEM TO THE BUILDING STRUCTURE.

#### NOTE #1:

UNITS WHERE WATER INFILTRATION IS REQUIRED MUST BE INSTALLED AT LOCATIONS PROTECTED BY AN OVERHANG MEETING CRITERIA AS PER ILLUSTRATION BELOW OR IN NON-HABITABLE AREAS WHERE WATER INFILTRATION IS ACCEPTABLE. IT IS APPLIED TO 4" NON-WATER RATING SADDLE THRESHOLD (DETAIL 2/D2) AND 4"(DETAIL 3/D2) OR 5"(DETAIL 5/D1) BUMPER THRESHOLD. FOR WATER INFILTRATION REQUIRE HIGHER THAN 5 PSF (≤33.3 PSF)

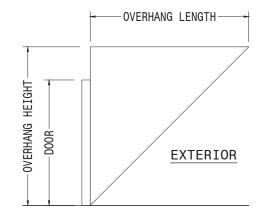

OVERHANG LENGTH OH RATIO= OVERHANG HEIGHT Attachment H



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PRODUCT:

#### 351 SERIES **ALUM OUTSWING DOORS**


W/ OR W/O TRANSOM (LARGE MISSILE IMPACT)

REVN	DATE/REMARKS
REV 01	02/11/2020

ENGINEER:



12871 Miramar Pkwy Ste. 301 Miramar, FL 33027 P: 305-271-0117 Email: MCY.Engineering@att.net www.MCYEngineering.com

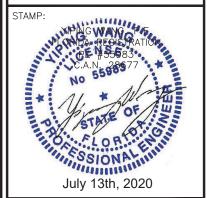

PRODUCT CONTROL APPROVAL: PRODUCT REVISED as complying with the Florida Building Code 20-0424.01 NOA-No. Expiration Date 06/04/2025 00 By Miami-Dade Product Control

SHEET TITLE

A1

DRAWN: FRANK DATE: 03-24-15

13 OF 17

DRAWING No:

DWG: AD15-23

#### LOCKS:

LOCK OPTION 1(ACTIVE/INACTIVE PANEL): AHT 8000 CVR TWO POINT LOCK SYSTEM WITH STRIKE PLATES AND ACTIVATING SURFACE MOUNT METALLIC INTERIOR PANIC DEVICE AND REGENT KEY OPERATOR ON THE EXTERIOR

LOCK OPTION 2(ACTIVE/INACTIVE PANEL): FALCON DOOR-O-MATIC 1690 CVR TWO POINT LOCK SYSTEM WITH STRIKE PLATES AND ACTIVATING SURFACE MOUNT METALLIC PANIC DEVICE ON THE INTERIOR

LOCK OPTION 3(ACTIVE/INACTIVE PANEL): VON DUPRIN 9947 CVR TWO POINT LOCK SYSTEM WITH TOP/BOTTOM STRIKE PLATES AND ACTIVATING SURFACE MOUNT METALLIC PANIC DEVICE ON THE INTERIOR AND SCHLAGE STANDARD KEY OPERATOR ON THE EXTERIOR

#### LOCK OPTION 4:

INACTIVE PANEL: ADAMS RITE MS1880, MS1881 & ILCO 1880 CONCEALED TWO POINT

LOCK SYSTEM WITH VERTICAL ROD AND STRIKE PLATES. THUMB TURN ON THE INTERIOR CAN NOT APPLY TO SINGLE PANEL DOOR

ACTIVE PANEL: ADAMS RITE W/AR4016 OR ILCO 4016 TOP ROD & AR4015 OR ILCO 4015 BOTTOM ROD WITH STRIKE PLATE, CONCEALED THREE POINT LOCK SYSTEM WITH ILCO185 EIGHT PLY HOOK LOCK, KEY OPERATOR ON THE EXTERIOR AND THUMB TURN ON THE INTERIOR

#### LOCK OPTION 5:

INACTIVE PANEL: REGENT ML-207-TT-2PT TWO POINT LOCK SYSTEM WITH EIGHT PLY HOOK LOCK. THUMB TURN ON THE INTERIOR CAN NOT APPLY TO SINGLE PANEL DOOR

ACTIVE PANEL: REGENT ML-207-012, CONCEALED THREE POINT LOCK SYSTEM WITH EIGHT PLY HOOK LOCK, KEY OPERATOR ON THE EXTERIOR AND THUMB TURN ON THE INTERIOR

HINGES: REFER TO DETAILS(H1) (H2) &(H3)

HINGE OPTION 1:(32) H1: (3) 4 1/2" BUTT HINGES (26298) 9 1/4" FROM TOP & BOTTOM, CENTERED

HINGE OPTION 2:(31) H2: OFFSET CAST ALUMINUM PIVOT HINGES


(H160X) BOTTOM (H160X) MIDSPAN (2456x)

HINGE OPTION 3:(33) H3: CONTINUOUS ALUMINUM GEAR (60095)

#### CHART#4:


DO	OR_	CONFIG.	LOCK OPTIONS		
WIDTH (MAX)HEIGHT(MAX)					
≤ 96" ≤ 96"		XX	1,2,3,4,5		
≤ 96" ≤ 120"		XX	1,4,5		
≤ 48" ≤ 96"		Х	1,2,3,4,5(ACTIVE PANEL)		
≤ 48" ≤ 120"		Х	1,4,5 (ACTIVE PANEL)		

NOTE: HINGES SHOWN ARE IMAGE ONLY.

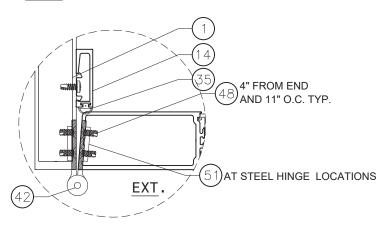


HINGE OPTION 1: (26298) 4-1/2" STEEL BUTT HINGE

(SEE ELEVATION FOR LOCATION)

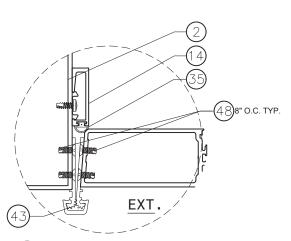

(H3) HINGE OPTION 3: (6009X) CONCEALED ALUM. CONTINUOUS **GEARED HINGE** 

(SEE ELEVATION FOR LOCATION)

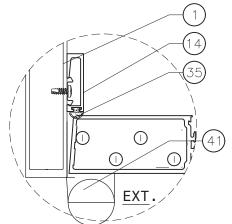

**HINGE OPTION 2: OFFSET PIVOT HINGE** (SEE ELEVATION FOR LOCATION)

(H160X) BOTTOM (H160X) MIDSPAN (2456x)



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PRODUCT:

#### 351 SERIES **ALUM OUTSWING DOORS**


W/ OR W/O TRANSOM (LARGE MISSILE IMPACT)

REVN	DATE/REMARKS
REV 01	02/11/2020

ENGINEER:

### MCY ENGINEERING, INC. **GLAZING CONSULTANT**

12871 Miramar Pkwy Ste. 301 Miramar, FL 33027 P: 305-271-0117 Email: MCY.Engineering@att.net www.MCYEngineering.com

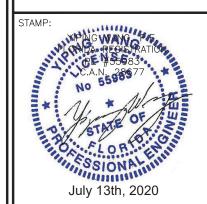

PRODUCT REVISED as complying with the Florida Building Code 20-0424.01

NOA-No. Expiration Date 06/04/2025

Miami-Dade Product Control

SHEET TITLE


H1

DRAWN: FRANK DATE: 03-24-1

14 OF 17

DRAWING No:

DWG: AD15-23

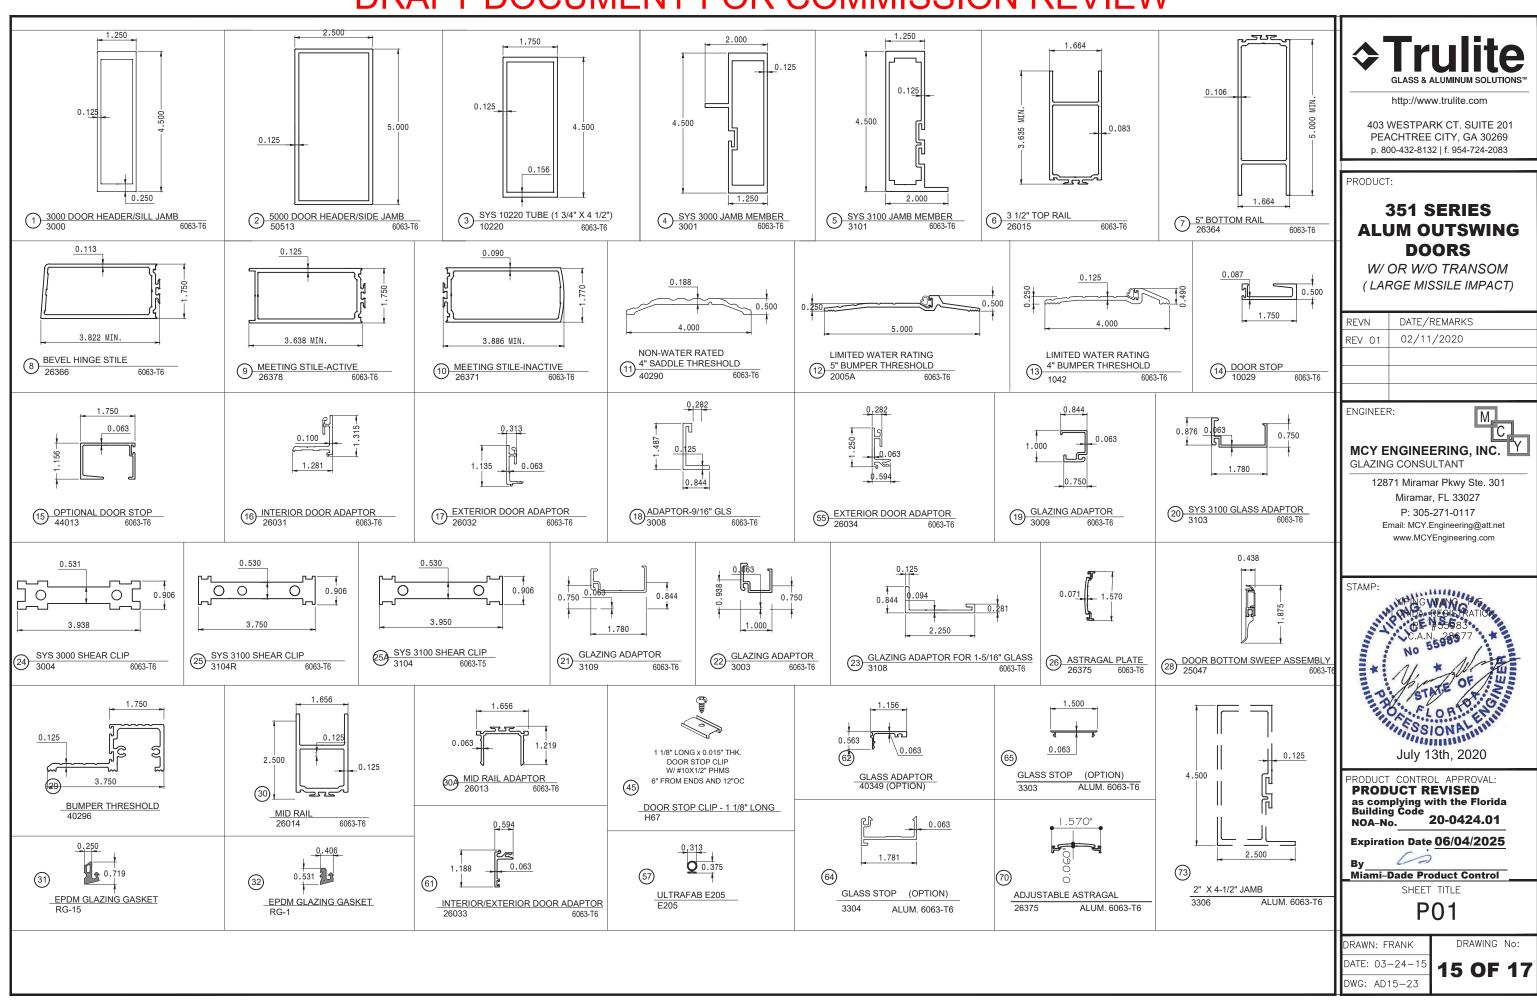

			AI I DOCC	
		BILL OF MAT	FRIALS	
ITEM #	PART #	DESCRIPTION	MATERIAL	SUPPLIER/MANUF.
1	3000	3000 DOOR HEADER/SILL JAMB	ALUM. 6063-T6	BONNELL
2	50513	5000 DOOR HEADER/SIDE JAMB	ALUM. 6063-T6	BONNELL
3	10220	SYS 10220 1-3/4" X 4 1/2" TUBE	ALUM. 6063-T6	BONNELL
4	3001	3000 TRANSOM BAR/TRANSOM HEADER/JAMB	ALUM. 6063-T6	BONNELL
5	3101	3100 TRANSOM BAR/TRANSOM HEADER/JAMB	ALUM. 6063-T6	BONNELL
6	26015	3 1/2" TOP RAIL	ALUM. 6063-T6	BONNELL
7	26364	5" BOTTOM RAIL	ALUM. 6063-T6	BONNELL
8	26366	BEVEL HINGE STILE	ALUM, 6063-T6	BONNELL
9	26378	MEETING STILE-ACTIVE	ALUM. 6063-T6	BONNELL
10	26371	MEETING STILE-INACTIVE	ALUM. 6063-T6	BONNELL
11	40290	4"SADDLE THRESHOLD	ALUM. 6063-T6	BONNELL
12	2005A	5"BUMPER THRESHOLD	ALUM. 6063-T6	PEMKO
13	1042	4"BUMPER THRESHOLD	ALUM. 6063-T6	BONNELL
14	10029	DOOR STOP	ALUM. 6063-T6	BONNELL
15	44013	OPTIONAL DOOR STOP	ALUM. 6063-T6	BONNELL
16	26031	INTERIOR DOOR ADAPTOR	ALUM. 6063-T6	BONNELL
	26032	EXTERIOR DOOR ADAPTOR	ALUM. 6063-T6	BONNELL
17	3008	GLAZING ADAPTOR-9/16"	ALUM. 6063-T6	BONNELL
18	3009	GLAZING ADAPTOR	ALUM. 6063-T6	BONNELL
19	3103	SYS 3100 GLAZING ADAPTOR	ALUM. 6063-T6	BONNELL
20	3109	TRANSOM GLAZING ADAPTOR	ALUM. 6063-T6	BONNELL
21	3003	GLAZING ADAPTOR	ALUM. 6063-T6	BONNELL
22	3108	TRANSOM GLAZING ADAPTOR FOR 1-5/16" GLASS	ALUM. 6063-T6	BONNELL
23	3004	SYS 3000 SHEAR CLIP	ALUM. 6063-T6	BONNELL
24	3104R	SYS 3100 SHEAR CLIP		
25	3104	SYS 3100 SHEAR CLIP	ALUM. 6063-T6	BONNELL BONNELL
25A	26375	ASTRAGAL PLATE	ALUM. 6063-T6 ALUM. 6063-T6	ALL METAL INC.
26	1122	INSULATED ALUMINUM SPACER	ALUMINUM	HAGER
27	25047	DOOR BOTTOM SWEEP ASSEMBLY	ALUM / RUBBER	BONNELL
29	40296	1 1/2" x 3 3/4" BUMPER THRESHOLD	ALUM. 6063-T6	BONNELL
l	26014	MID RAIL	ALUM. 6063-T6	BONNELL
30 30A	26013	MID RAIL ADAPTOR	ALUM. 6063-T6	TREMCO/GRP
31	RG15	EPDM GLAZING GASKET	EPDM (DUROMETER 70 SHORE A)	TREMCO/GRP
	RG1	EPDM GLAZING GASKET		RUBBER GROMMET
32	23301	RUBBER GROMMET AT ASTRAGAL	EPDM (DUROMETER 70 SHORE A)  NITRILE	TREMCO/GRP
33	H62D	1/2"x 1/4" SETTING BLOCK	EPDM (DUROMETER 85 +/-5 SHORE A)	TREMCO/GRP
34 34A	H62F	1 3/8"x 1/4" SETTING BLOCK	EPDM (DUROMETER 85 +/-5 SHORE A)	TREMCO/GRP
35	RG5	DOOR STOP GASKET	. ,	DOW CORNING
	DOWSIL995	DC995 SILICONE	EPDM (DUROMETER 65 SHORE A) SILICONE	אוודוווט וווסמ
36	V2108	1/4"X3/8" GLAZING TAPE	FOAM	ST. GOBAIN
37	(TOP)	., . NO JO GENERAL THE		GLOBAL DOOR
41	H160X SET (BOTTOM)	OFFSET PIVOT HINGE	ALUM. 6063-T6 ALUM. 6063-T6	GLOBAL DOOR GLOBAL DOOR
41	2456X MIDSPAN	OH OEL TIVOT HINGE		
40	26298	4-1/2" STEEL BUTT HINGE 1/8" THK.	ALUM. 6063-T6	GLOBAL DOOR HAGER COMPANIES/IMPERIAL USA (GLOBAL DOOR)
42	6009X	ALUM CONTINUOUS GEARED HINGE 0.094" THK.	STEEL ALUM 6063-T6	
43	24110	BRUSH PILE AT DOOR MEETING STILE	ALUM. 6063-T6 YARN	HAGER COMPANIES  AMESBURY GROUP
44	23501	DOOR STOP CLIP-1 1/8" LG, 6" ON ENDS,12" O.C.	STEEL	EVANS MANUFACTURING
45	SPACER2	PVC SETTING BLOCK FOR 9/16" GLASS	PVC PLASTIC	M & M PLASTIC
47	2620301	BACKING PLATE	ALUM. 6063-T6	BONNELL
48	23163	#12-24" x 3/4" PFH-23	ZINC COATED STEEL	ALLOY FASTENER
49	23897	#10-24" x 1/4" PFH	ZINC COATED STEEL	VARIES
50	23302	#6 x 3/4" UC-PFH TEK	ZINC COATED STEEL	VARIES
51	26139 23233	HINGE BACKING PLATE 1/4-20 X 1-1/2" PFH	STEEL ZINC COATED STEEL	EVANS ALLOV FASTENED
52 53	23089	#10-24" x 5/10" PFH	ZINC COATED STEEL ZINC COATED STEEL	ALLOY FASTENER ALLOY FASTENER
54	23079	#10-24" x 3/14" PFH	STEEL STEEL	ALLOY FASTENER
55	26034	DOOR ADAPTOR USED FOR DOOR LEAF WIDTH UPTO 36"	ALUM. 6063-T6	BONNELL
56	SPACER3	DOOR SETTING BLOCK	PVC PLASTIC EXTRUSION	M&M PLASTICS

SUPPLIER/MANUF.  ULTRAFAB DOW CORNING BONNELL
DOW CORNING BONNELL
BONNELL
TREMCO
BONNELL
BONNELL
TREMCO
BONNELL
BONNELL
VARIES
ADAMS RITE, AT INACTIVE PANEL @ 36 9/16" FROM BOTTOM
ADAMS RITE, AT ACTIVE PANEL @ 36 9/16" FROM BOTTOM
BONNELL
BONNELL
RUBBERGROMMET.COM
VARIES, INSIDE EACH PANEL LOCK STILE LOCATED @ 42"FROM BOTTOM
BONNELL
P P P



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PRODUCT:

# 351 SERIES ALUM OUTSWING DOORS

W/ OR W/O TRANSOM (LARGE MISSILE IMPACT)

	REVN		DATE/REMARKS
		REV 01	02/11/2020
_			
M	Ш		

ENGINEER:



MCY ENGINEERING, INC.

GLAZING CONSULTANT

12871 Miramar Pkwy Ste. 301 Miramar, FL 33027 P: 305-271-0117 Email: MCY.Engineering@att.net www.MCYEngineering.com

STAMP:

MPAG WANG

REGISTRATION

CE #55683

C.A.N. 28677

NO 550NA

July 13th, 2020

PRODUCT CONTROL APPROVAL:
PRODUCT REVISED
as complying with the Florida
Building Code
NOA-No. 20-0424.01

Expiration Date <u>06/04/2025</u>

By Miami-Dade Product Control

SHEET TITLE

BOM


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DRAWN: FRANK
DATE: 03-24-15

DATE: 03-24-15 DWG: AD15-23

DRAWING No:

#### Attachment H



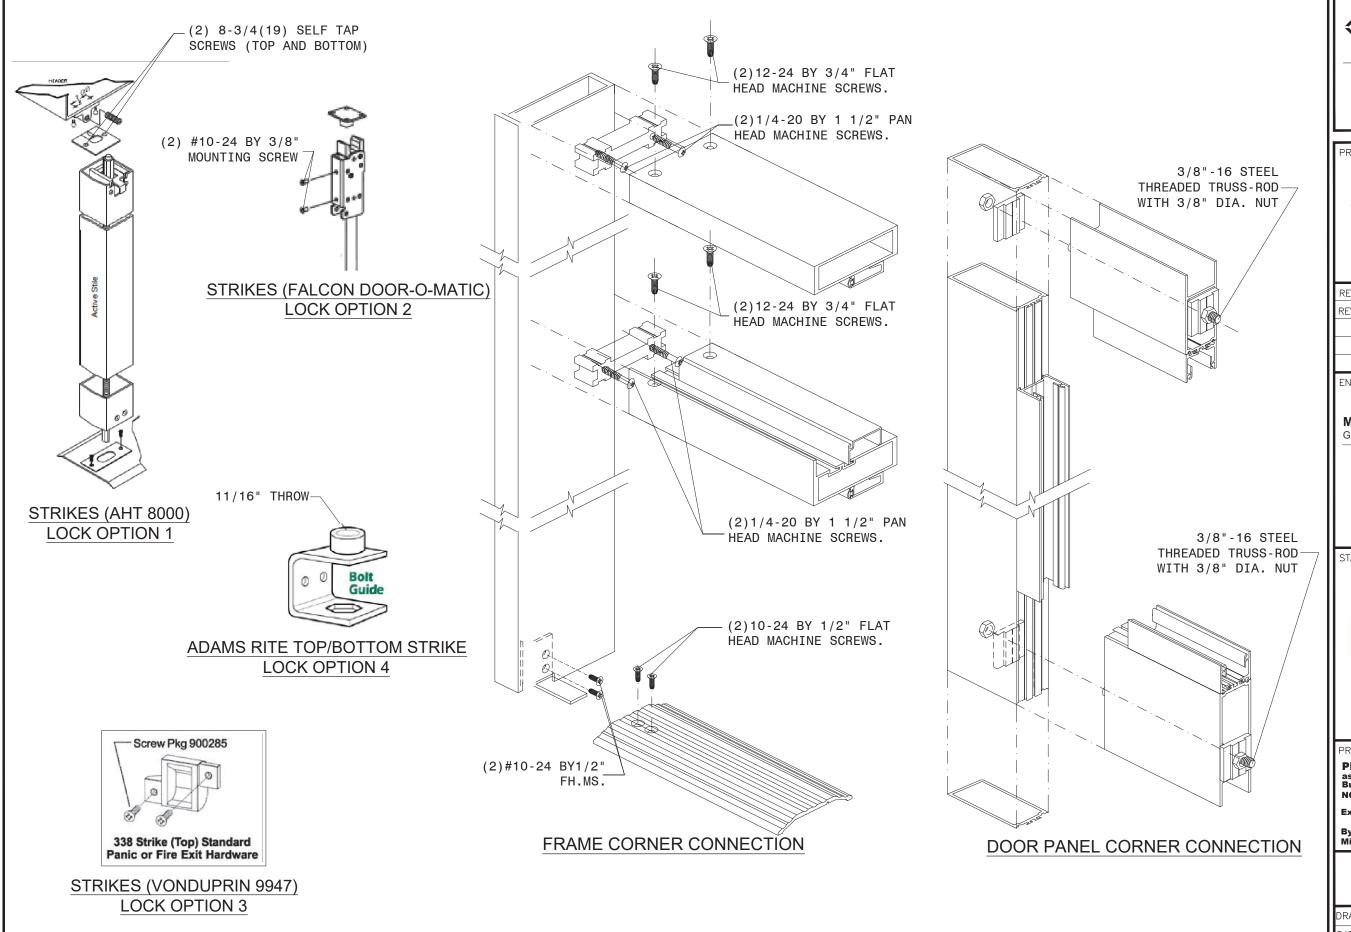

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PRODUCT:

#### 351 SERIES **ALUM OUTSWING DOORS**

W/ OR W/O TRANSOM (LARGE MISSILE IMPACT)

ı	REVN	DATE/REMARKS
ı	REV 01	02/11/2020
ı		
ı		

ENGINEER:



**GLAZING CONSULTANT** 

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July 13th, 2020

PRODUCT REVISED 20-0424.01

Expiration Date 06/04/2025

By Miami-Dade Product Control

SHEET TITLE

IS0

DRAWN: FRANK

DWG: AD15-23

DRAWING No: DATE: 03-24-15 17 OF 17

#### Attachment I



MIAMI-DADE COUNTY
PRODUCT CONTROL SECTION
11805 SW 26 Street, Room 208
Miami, FL 33175-2474
T (786) 315-2590 F (786) 315-2599

www.miamidade.gov/building

DEPARTMENT OF REGULATORY AND ECONOMIC RESOURCES (RER)
BOARD AND CODE ADMINISTRATION DIVISION

#### NOTICE OF ACCEPTANCE (NOA)

Trulite Glass & Aluminum Solutions, LLC 403 West Park Ct, #201 Peachtree City, GA 30269

#### SCOPE:

This NOA is being issued under the applicable rules and regulations governing the use of construction materials. The documentation submitted has been reviewed and accepted by Miami-Dade County RER-Product Control Section to be used in Miami-Dade County and other areas where allowed by the Authority Having Jurisdiction (AHJ).

This NOA shall not be valid after the expiration date stated below. The Miami-Dade County Product Control Section (In Miami-Dade County) and/ or the AHJ (in areas other than Miami-Dade County) reserve the right to have this product or material tested for quality assurance purposes. If this product or material fails to perform in the accepted manner, the manufacturer will incur the expense of such testing and the AHJ may immediately revoke, modify, or suspend the use of such product or material within their jurisdiction. RER reserves the right to revoke this acceptance, if it is determined by Miami-Dade County Product Control Section that this product or material fails to meet the requirements of the applicable building code.

This product is approved as described herein, and has been designed to comply with the Florida Building Code, including the High Velocity Hurricane Zone.

#### DESCRIPTION: Series "3100-Resistor" Aluminum Storefront/Window Wall System - L.M.I.

**APPROVAL DOCUMENT:** Drawing No. **AD11–21**, titled "Resistor 3100 Storefront Wall - LMI", sheets 1 through 13 of 13, dated 09/16/21, with revision 4 dated 03/09/22, prepared by MCY Engineering, Inc., signed and sealed by Yiping Wang, P.E., bearing the Miami–Dade County Product Control Revision stamp with the Notice of Acceptance number and expiration date by the Miami–Dade County Product Control Section.

#### MISSILE IMPACT RATING: Large and Small Missile Impact Resistant.

**LABELING:** Each unit shall bear a permanent label with the manufacturer's name or logo, city, state, series, and following statement: "Miami-Dade County Product Control Approved", unless otherwise noted herein.

**RENEWAL** of this NOA shall be considered after a renewal application has been filed and there has been no change in the applicable building code negatively affecting the performance of this product.

**TERMINATION** of this NOA will occur after the expiration date or if there has been a revision or change in the materials, use, and/ or manufacture of the product or process. Misuse of this NOA as an endorsement of any product, for sales, advertising or any other purposes shall automatically terminate this NOA. Failure to comply with any section of this NOA shall be cause for termination and removal of NOA.

**ADVERTISEMENT:** The NOA number preceded by the words Miami-Dade County, Florida, and followed by the expiration date may be displayed in advertising literature. If any portion of the NOA is displayed, then it shall be done in its entirety.

**INSPECTION:** A copy of this entire NOA shall be provided to the user by the manufacturer or its distributors and shall be available for inspection at the job site at the request of the Building Official.

This NOA revises NOA No. 21-0930.10 and consists of this page 1 and evidence pages E-1, E-2, E-3 and E-4, as well as approval document mentioned above.

The submitted documentation was reviewed by Manuel Perez, P. E.

#### Trulite Glass & Aluminum Solutions, LLC

#### **NOTICE OF ACCEPTANCE: EVIDENCE SUBMITTED**

#### 1. **EVIDENCE SUBMITTED UNDER PREVIOUS NOA's**

#### A. **DRAWINGS**

- 1. Manufacturer's die drawings and sections. (Submitted under NOA No. 04-1213.01)
- 2. Drawing No. AD11-21, titled "Resistor 3100 Aluminum Storefront Wall - LMI", sheets 1 through 13 of 13, dated 09/16/21, with revision 2 dated 09/16/21, prepared by MCY Engineering, Inc., signed and sealed by Yiping Wang, P.E. (Submitted under NOA No. 21-0930.10)

#### B. **TESTS**

- Test reports on: 1) Uniform Static Air Pressure Test, Loading per FBC, TAS 202-94 1.
  - 2) Large Missile Impact Test per FBC, TAS 201-94
  - 3) Cyclic Wind Pressure Loading per FBC, TAS 203-94

along with marked-up drawings and installation diagram of a series 3100 aluminum storefront system, prepared by Intertek, Inc., Test Report No.

M7456.01-450-18R0, dated 09/22/21, signed and sealed by Vinu J. Abraham, P.E. (Submitted under NOA No. 21-0930.10)

- Test reports on: 1) Uniform Static Air Pressure Test, Loading per FBC, TAS 202–94 2.
  - 2) Large Missile Impact Test per FBC, TAS 201–94
  - 3) Cyclic Wind Pressure Loading per FBC, TAS 203–94

along with marked-up drawings and installation diagram of an aluminum window wall system, prepared by Fenestration Testing Laboratory, Inc., Test Report No.:

- FTL-5884, dated 05/28/09, signed and sealed by Michael R. Wenzel, P.E. (Submitted under NOA No.09-1022.01)
- FTL-5140, dated 01/20/07, signed and sealed by Michael R. Wenzel, P.E. (Submitted under NOA No.08-1024.04)
- FTL-3634, dated 04/24/03, signed and sealed by Joseph Chan, P.E. (Submitted under NOA No. 04-1213.01)
- 3. Test reports on: 1) Air Infiltration Test, per FBC, TAS 202–94
  - 2) Uniform Static Air Pressure Test, Loading per FBC, TAS 202–94
  - 3) Water Resistance Test, per FBC, TAS 202–94
  - 4) Large Missile Impact Test per FBC, TAS 201–94
  - 5) Cyclic Wind Pressure Loading per FBC, TAS 203–94

along with marked-up drawings and installation diagram of an aluminum window wall system, prepared by Fenestration Testing Laboratory, Inc., Test Report No.

FTL-3942, dated 02/03/04, signed and sealed by Edmundo Largaespada, P.E.

(Submitted under NOA No. 05-0906.04)

#### **Trulite Glass & Aluminum Solutions, LLC**

#### NOTICE OF ACCEPTANCE: EVIDENCE SUBMITTED

#### 1. EVIDENCE SUBMITTED UNDER PREVIOUS NOA'S (CONTINUED)

#### C. CALCULATIONS

1. Anchor verification calculations and structural analysis, complying with FBC 7<sup>th</sup> Edition (2020), dated 09/28/21, prepared by MCY Engineering, Inc., signed and sealed by Yiping Wang, P.E.

(Submitted under NOA No. 21-0930.10)

2. Glazing complies with ASTM E1300-04

#### D. **QUALITY ASSURANCE**

1. Miami-Dade Department of Regulatory and Economic Resources (RER).

#### E. MATERIAL CERTIFICATIONS

- 1. Notice of Acceptance No. **20-0915.19** issued to **Kuraray America**, **Inc.** for their "SentryGlas® (Clear and White) Glass Interlayers" dated 11/19/20, expiring on 07/04/23.
- 2. Notice of Acceptance No. 20-0622.02 issued to Eastman Chemical Company (MA) for their "Saflex HP Clear or Color Glass Interlayers" dated 08/06/20, expiring on 04/14/23.
- 3. Notice of Acceptance No. 21-0216.01 issued to Eastman Chemical Company (MA) for their "Saflex PVB Interlayers Clear and Colored for Glass" dated 04/29/21, expiring on 05/21/26.
- 4. Notice of Acceptance No. 20-0929.03 issued to Everlam N.V. for their "Everlam Super Tough PVB Glass Interlayer", dated 04/29/21, expiring on 04/29/26.

#### F. STATEMENTS

1. Statement letter of conformance, complying with **FBC** 7<sup>th</sup> **Edition (2020)**, and of no financial interest, dated September 28, 2021, issued by MCY Engineering, Inc., signed and sealed by Yiping Wang, P.E.

(Submitted under NOA No. 21-0930,10)

2. Test Proposal No. 21-0643R issued by the Product Control Section, dated May 20, 2021 and revised on August 27, 2021, signed by Manuel Perez, P.E. (Submitted under NOA No. 21-0930.10)

#### G. OTHERS

1. Notice of Acceptance No. **21-0122.14** issued to Trulite Glass & Aluminum Solutions, LLC for their Series "3100 Resistor" Aluminum Storefront/Window Wall System – L.M.I.", approved on 04/22/21 and expiring on 03/31/25.

#### Trulite Glass & Aluminum Solutions, LLC

#### NOTICE OF ACCEPTANCE: EVIDENCE SUBMITTED

#### 2. NEW EVIDENCE SUBMITTED

#### A. DRAWINGS

1. Drawing No. **AD11-21**, titled "Resistor 3100 Aluminum Storefront Wall - LMI", sheets 1 through 13 of 13, dated 09/16/21, with revision 4 dated 03/09/22, prepared by MCY Engineering, Inc., signed and sealed by Yiping Wang, P.E.

#### B. TESTS

- 1. Test reports on: 1) Uniform Static Air Pressure Test, Loading per FBC, TAS 202-94
  - 2) Large Missile Impact Test per FBC, TAS 201-94
  - 3) Cyclic Wind Pressure Loading per FBC, TAS 203-94

along with marked-up drawings and installation diagram of a series 3100 aluminum storefront system, prepared by Intertek, Inc., Test Report No. **M3224.01-450-18 R0**, dated 12/13/21, signed and sealed by Vinu J. Abraham, P.E.

#### C. CALCULATIONS

1. None.

#### D. QUALITY ASSURANCE

1. Miami-Dade Department of Regulatory and Economic Resources (RER)

#### E. MATERIAL CERTIFICATIONS

- 1. Notice of Acceptance No. **20-0915.19** issued to **Kuraray America**, **Inc.** for their "SentryGlas® (Clear and White) Glass Interlayers" dated 11/19/20, expiring on 07/04/23.
- 2. Notice of Acceptance No. 20-0622.02 issued to Eastman Chemical Company (MA) for their "Saflex HP Clear or Color Glass Interlayers" dated 08/06/20, expiring on 04/14/23.
- 3. Notice of Acceptance No. 21-0216.01 issued to Eastman Chemical Company (MA) for their "Saflex PVB Interlayers Clear and Colored for Glass" dated 04/29/21, expiring on 05/21/26.
- 4. Notice of Acceptance No. 20-0929.03 issued to Everlam N.V. for their "Everlam Super Tough PVB Glass Interlayer", dated 04/29/21, expiring on 04/29/26.
- 5. Notice of Acceptance No. 21-0628.05 issued to Everlam N.V. for their "Everlam LAM50 PVB Glass Interlayer", dated 10/07/21, expiring on 10/07/26.

#### F. STATEMENTS


1. Statement letter of conformance, complying with **FBC** 7<sup>th</sup> **Edition (2020)**, and of no financial interest, dated March 10, 2022, issued by MCY Engineering, Inc., signed and sealed by Yiping Wang, P.E.

Attachment I

#### **Trulite Glass & Aluminum Solutions, LLC**

#### NOTICE OF ACCEPTANCE: EVIDENCE SUBMITTED

- 2. NEW EVIDENCE SUBMITTED (CONTINUED)
- G. OTHERS
  - 1. Notice of Acceptance No. **21-0930.10** issued to Trulite Glass & Aluminum Solutions, LLC for their Series "3100-Resistor" Aluminum Storefront/Window Wall System L.M.I.", approved on 10/28/21 and expiring on 03/31/25.

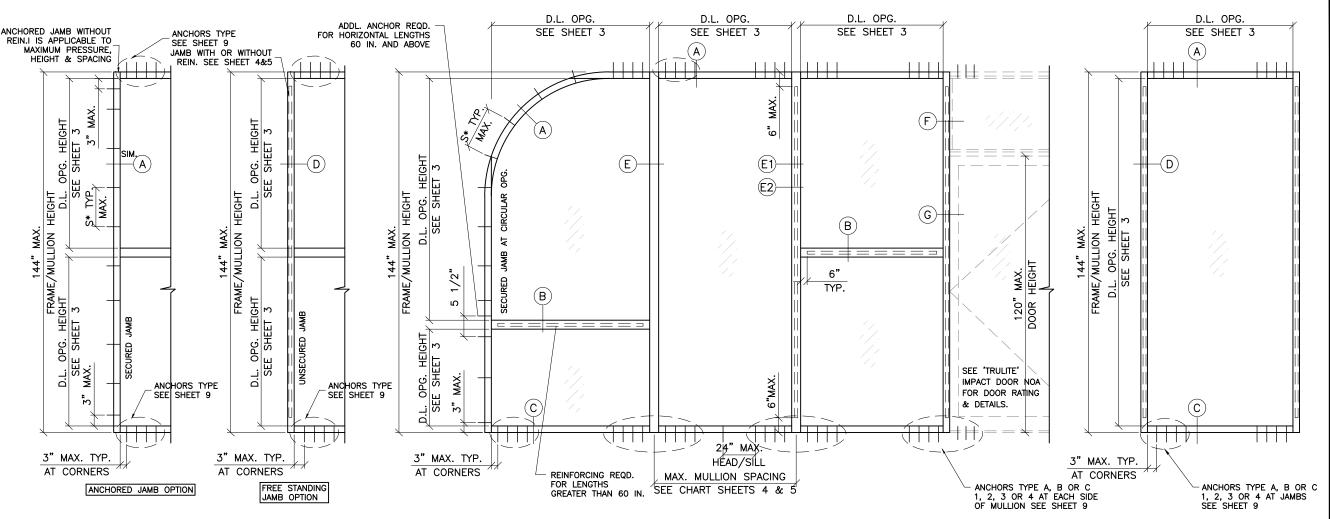

#### SERIES 3100/L-3100 ALUMINUM WINDOW WALL SYSTEM

- WINDOW WALL SYSTEM IS RATED FOR LARGE & SMALL MISSILE IMPACT. SHUTTERS ARE NOT REQUIRED.
- THIS SYSTEM MAY BE USED IN CONJUNCTION WITH MIAMI DADE COUNTY APPROVED ENTRANCE DOORS.
- CODE REQUIREMENTS FOR SAFEGUARDS MUST BE OBSERVED.
- THIS PRODUCT HAS BEEN DESIGNED AND TESTED TO COMPLY WITH THE REQUIREMENTS OF THE 7TH EDITION (2020) FLORIDA BUILDING CODE INCLUDING HIGH VELOCITY HURRICANE ZONE (HVHZ).
- WOOD BUCKS BY OTHERS, MUST BE ANCHORED PROPERLY TO TRANSFER LOADS TO THE STRUCTURE.
- ANCHORS SHALL BE AS LISTED, SPACED AS SHOWN ON DETAILS, ANCHORS EMBEDMENT TO BASE MATERIAL SHALL BE BEYOND WALL DRESSING OR STUCCO.
- ANCHORING OR LOADING CONDITIONS NOT SHOWN IN THESE DETAILS ARE NOT PART OF THIS APPROVAL.
- . A LOAD DURATION INCREASE IS USED IN DESIGN OF ANCHORS INTO WOOD ONLY.
- MATERIALS INCLUDING BUT NOT LIMITED TO STEEL/ METAL SCREWS THAT COME INTO CONTACT WITH OTHER DISSIMILAR MATERIALS SHALL MEET THE REQUIREMENTS OF 2020 FLORIDA BLDG. CODE SECTION AS APPLICABLE.
- ULTIMATE DESIGN LOAD OBTAINED FROM ASCE7-16, MULTIPLY BY 0.6 SHALL BE LESS THAN OR EQUAL TO MAX. DESIGN LOAD IN THIS DOCUMENT.

#### TYPICAL ELEVATIONS

### INSTRUCTIONS: USE CHARTS AS FOLLOWS.

- STEP 1: DETERMINE DESIGN WIND LOAD REQUIREMENTS
  BASED ON WIND VELOCITY, BLDG. HEIGHT, WIND
  ZONE USING APPLICABLE ASCE 7-16 STANDARD.
- STEP 2: SEE CHARTS ON SHEET 2 FOR DESIGN LOAD CAPACITY OF DESIRED GLASS SIZE BASED ON APPLICABLE WIND DURATION.
- STEP 3: CHECK MULLION AND JAMB CAPACITY FOR A GIVEN SPACING AND HEIGHT USING CHARTS ON SHEET 3 & 4.THE CAPACITY SHOULD EXCEED THE DESIGN LOAD.
- STEP 4: USING CHART ON SHEETS 5 SELECT ANCHOR OPTION WITH DESIGN RATING MORE THAN DESIGN LOAD SPECIFIED IN STEP 1 ABOVE.
- STEP 5: THE LOWEST VALUE RESULTING FROM STEPS 2, 3 AND 4 SHALL APPLY TO ENTIRE SYSTEM.

S\* = 11" O.C. FOR ALL TYPICAL ANCHORS EXCEPT 10" O.C. FOR 1/4" ULTRACON INTO GROUT FILLED BLOCK & MULLION SPACE ≥ 64"

THIS PRODUCT HAS BEEN TESTED FOR WATER RESISTANCE INFILTRATION UP TO 50 PSF.



http://www.trulite.com

403 WESTPARK COURT, Suite 201 PEACHTREE CITY, GA 30269 p. 800-432-8132

PRODUCT:

#### Resistor 3100 ALUMINUM

STOREFRONT WALL-LMI



REVN DATE/REMARKS

REV4 03.09.2022 UPDATE INTERLAYER

ENGINEER:

### MCY ENGINEERING. INC.

**GLAZING CONSULTANT** 

12781 Miramar Parkway #301 Miramar. FL 33027

P: 305-271-0117 Email: mcy@mcyengineering

www.MCYEngineering.com

YIPING WANG, P.E.
FLORIDA REGISTRATION
RE #55985
C.A.L. 128677

PRODUCT CONTROL APPROVAL:

PRODUCT REVISED
as complying with the Florida
Building Code

NOA-No. 21-1216.10


Expiration Date 03/31/2025

By Manuel Perez Miami-Dade Product Confrol

DRAWN:James

DRAWING No:

DATE: 03.09.22 **1 OF 13** 

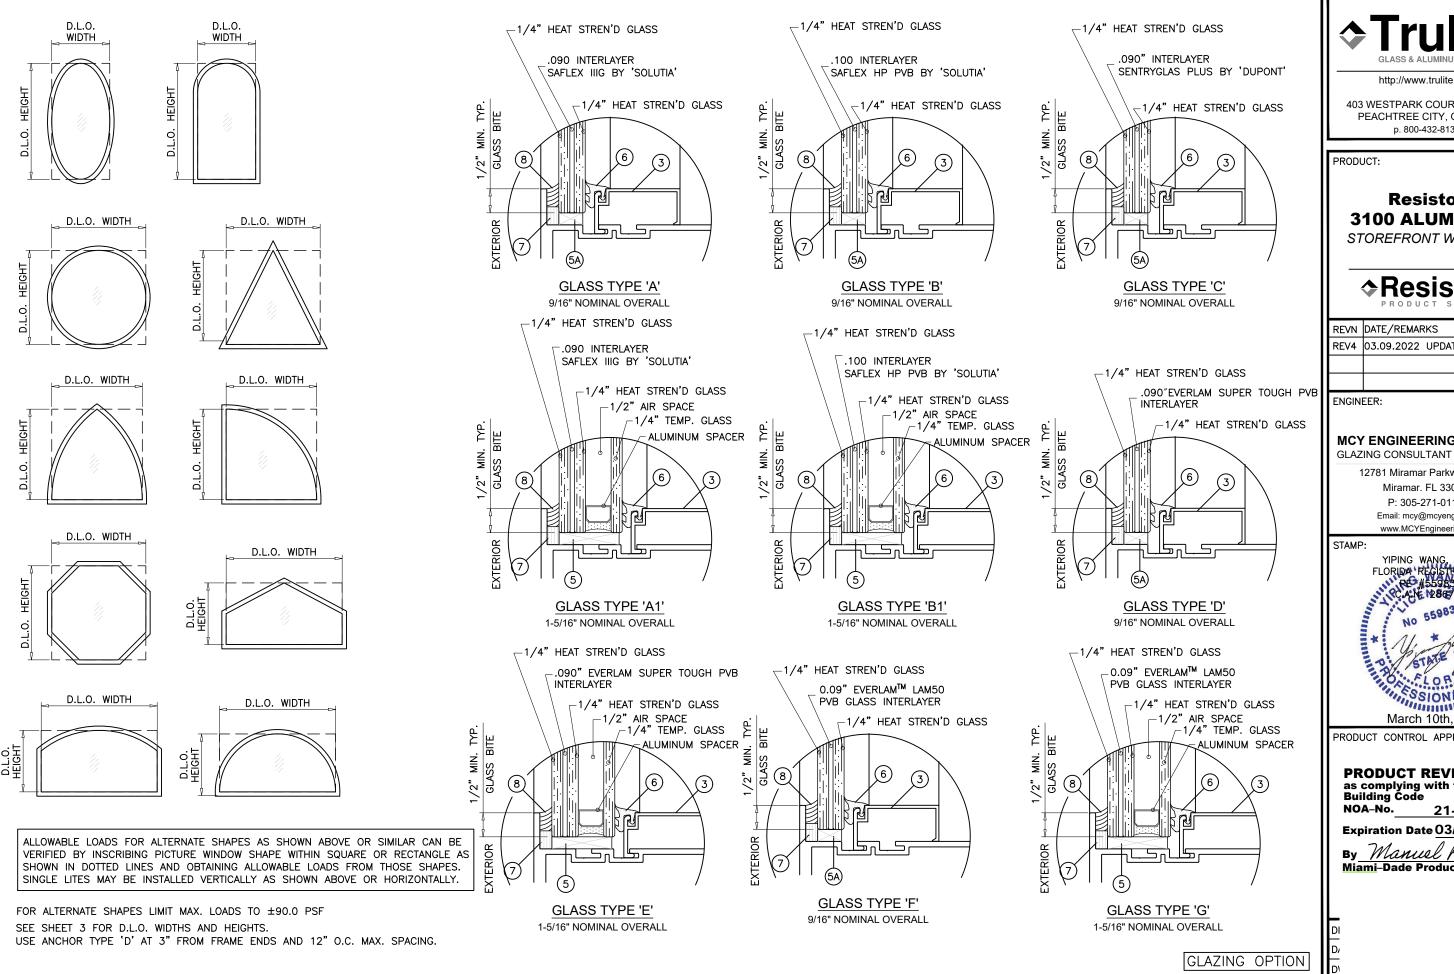

http://www.trulite.com

403 WESTPARK COURT, Suite 201 PEACHTREE CITY, GA 30269 p. 800-432-8132

PRODUCT:

#### Resistor 3100 ALUMINUM

STOREFRONT WALL-LMI




REVN DATE/REMARKS REV4 03.09.2022 UPDATE INTERLAYER



12781 Miramar Parkway #301 Miramar. FL 33027

P: 305-271-0117 Email: mcy@mcyengineering www.MCYEngineering.com

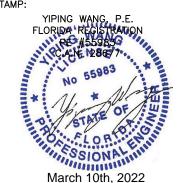

PRODUCT CONTROL APPROVAL:

PRODUCT REVISED as complying with the Florida Building Code NOA-No. 21-1216.10

Expiration Date 03/31/2025

By Manuel Perez Miami-Dade Product Control

		GLAS	S LOAD	CAPACITY	- PSF			
		GLASS						
NOMIN	AL DIMS.	'A'	'A1'	'B'	'B1'	,C,	'D&E'	'F&G'
D.L.O. WIDTH	D.L.O. HEIGHT	EXT. (+) INT. (-)						
20"		70.0	80.0	100.0	100.0	100.0	+70/-85	+65/-75
26"		70.0	80.0	100.0	100.0	100.0	+70/-85	+65/-75
32"		70.0	80.0	100.0	100.0	100.0	+70/-85	+65/-75
38"		70.0	80.0	100.0	100.0	100.0	+70/-85	+65/-75
44"	"	70.0	80.0	100.0	100.0	100.0	+70/-85	+65/-75
53"	68"	70.0	80.0	100.0	100.0	100.0	+70/-85	+65/-75
56"		70.0	80.0	100.0	100.0	100.0	+70/-85	-
62"		70.0	80.0	100.0	100.0	100.0	-	-
68"		70.0	_	100.0	100.0	100.0	_	-
72"		70.0	_	100.0	100.0	100.0	_	_
20"		70.0	80.0	100.0	100.0	100.0	· ·	+65/-75
26"		70.0	80.0	100.0	100.0	100.0		+65/-75
32"		70.0	80.0	100.0	100.0	100.0	· .	+65/-75
38"		70.0	80.0	100.0	100.0	100.0	· .	+65/-75
44"	74"	70.0	80.0	100.0	100.0	100.0	· .	+65/-75
48"		70.0	80.0	100.0	100.0	100.0	<b>-</b>	+65/-75
56"		70.0	80.0	100.0	100.0	100.0	+70/-85	-
62"		70.0	_	100.0	100.0	100.0	-	_
68"			_	100.0	100.0	100.0	_	_
72"		70.0		100.0	100.0	100.0	- +70/-85	- +65/-75
20" 26"		70.0	80.0 80.0	100.0	100.0	100.0	· ·	+65/-75
32"		70.0	80.0	100.0	100.0	100.0	· ·	+65/-75
32 38"		70.0	80.0	100.0	100.0	100.0		+65/-75
45"		70.0	80.0	100.0	100.0	100.0	· .	+65/-75
50"	80"	70.0	80.0	100.0	100.0	100.0	+70/-85	_
56"		70.0	_	100.0	100.0	100.0	_	_
62"		_	_	100.0	100.0	100.0	_	_
68"		_	_	100.0	100.0	100.0	_	_
72"		_	_	100.0	100.0	100.0	_	_
20"		70.0	80.0	100.0	100.0	100.0	+70/-85	+65/-75
26"		70.0	80.0	100.0	100.0	100.0	+70/-85	+65/-75
32"		70.0	80.0	100.0	100.0	100.0	+70/-85	+65/-75
42		70.0	80.0	100.0	100.0	100.0	+70/-85	+65/-75
44"	86"	70.0	80.0	100.0	100.0	100.0	+70/-85	-
50"	60	70.0	_	100.0	100.0	100.0	_	_
56"		70.0	_	100.0	100.0	100.0	_	_
62"		_	-	100.0	100.0	100.0	-	-
68"		-	-	100.0	100.0	100.0	-	-
72"		_	-	100.0	100.0	100.0	-	-
20"		70.0	80.0	100.0	100.0	100.0		+65/-75
26"		70.0	80.0	100.0	100.0	100.0	· ·	+65/-75
32"		70.0	80.0	100.0	100.0	100.0	· .	+65/-75
39.25"		70.0	80.0	100.0	100.0	100.0	· ·	+65/-75
45.25"	92"	70.0	80.0	100.0	100.0	100.0	+70/-85	_
50"		70.0		100.0	100.0	100.0	<u> </u>	
56" 62"			_	100.0	100.0	100.0	_	_
62 68"			_	100.0	100.0	100.0	_	_
72 <b>"</b>		_	_	100.0	100.0	-	_	_
- / -			I	100.0	100.0		l	l

		GT.AS	S LOAD	CAPACITY	- PSF			
NOMINA	AL DIMS.	GLASS 'A'	GLASS 'A1'	GLASS 'B'	GLASS 'B1'	GLASS 'C'	GLASS 'D&E'	GLASS 'F&G'
D.L.O. WIDTH	D.L.O. HEIGHT	EXT. (+) INT. (-)						
20"		70.0	80.0	100.0	100.0	100.0	+70/-85	+65/-75
26"		70.0	80.0	100.0	100.0	100.0	+70/-85	+65/-75
36"		70.0	80.0	100.0	100.0	100.0	+70/-85	+65/-75
38"		70.0	80.0	100.0	100.0	100.0	+70/-85	-
44"		70.0	_	100.0	100.0	100.0	-	-
50"	98"	_	_	100.0	100.0	100.0	-	_
56"		_	_	100.0	100.0	100.0	_	_
62"		_	-	100.0	100.0	100.0	-	-
68"		_	-	100.0	100.0	-	-	-
20"		70.0	80.0	100.0	100.0	100.0	+70/-85	+65/-75
26"		70.0	80.0	100.0	100.0	100.0	+70/-85	+65/-75
34"		70.0	80.0	100.0	100.0	100.0	+70/-85	
38"		70.0	80.0	100.0	100.0	100.0	+70/-85	_
44"	104"	70.0	_	100.0	100.0	100.0	_	_
50"			_	100.0	100.0	100.0	_	_
56"				100.0	100.0	100.0	_	_
62"		_	_	100.0	100.0	100.0	_	_
20"		70.0	90.0	100.0	100.0	100.0	+70/-85	
			80.0 80.0		100.0		+70/-85	<u> </u>
26"		70.0		100.0		100.0	<u> </u>	<u> </u>
32"		70.0	80.0	100.0	100.0	100.0	+70/-85	+03/-/3
38"	110"	70.0	80.0	100.0	100.0	100.0	_	_
44"		70.0	_	100.0	100.0	100.0	_	_
50"		_	_	100.0	100.0	100.0	_	_
56"		_	_	100.0	PRODI	JCT RE	VISED	
62"		70.0	-	97.5	as (			
20"		70.0	80.0	100.0			REVISI with the	
31"		70.0	80.0	100.0	Buil	ding Cod		. i ioiiuu
32"		70.0	80.0	100.0	Exp NO	\-No	21-12	<u> 216.10</u>
38"	116"	70.0	_	100.0	By_Exp	iration Da	ate <u>03/3</u> 1	<u>1/202</u> 5
44"			_	100.0	Mia	Mani	in D. Do	rez
50"		_	_	100.0	By_ Miai	,	Product (	
56"		-	-	97.9				
58-3/4"		-	-	94.6				
20"		70.0	80.0	100.0				
29"		70.0	80.0	100.0				
32"	122"	70.0	80.0	100.0				
38"	-	70.0	_	100.0				
44"		_	_	100.0				
50"		_		100.0				
20"		70.0	80.0	100.0				
28"		70.0	80.0	100.0				
32"	128"	70.0	80.0	100.0				
38"	.20	70.0	_	100.0				
44"		-	_	100.0				
50"		_	_	100.0				

GLASS LOAD CAPACITY - PSF									
NOMINAL DIMS.		GLASS 'A'	GLASS 'A1'	GLASS 'B'	GLASS 'B1'	GLASS 'C'	GLASS 'D&E'	GLASS 'F&G'	
D.L.O. WIDTH	D.L.O. HEIGHT	EXT. (+) INT. (-)							
20"		70.0	80.0	100.0	100.0	100.0	+70/-85	+65/-75	
26"		70.0	80.0	100.0	100.0	100.0	+70/-85	+65/-75	
32"	"	70.0	-	100.0	100.0	100.0	-	_	
38"	134"	_	-	100.0	100.0	100.0	_	_	
44"		_	_	100.0	100.0	100.0	_	-	
50"		-	-	99.8	100.0	-	-	1	
20"		70.0	80.0	100.0	100.0	100.0	+70/-85	+65/-75	
25"		70.0	80.0	100.0	100.0	100.0	+70/-85	+65/-75	
32"	140"	70.0	_	100.0	100.0	100.0	_	1	
38"		_	_	100.0	100.0	100.0	_	-	
44"		_	_	100.0	100.0	100.0	_	_	

NOTE: GLASS CAPACITIES ON THIS SHEET ARE BASED ON ASTM E1300 (3 SEC. GUSTS)

D.L.O. D.L.O.



http://www.trulite.com

403 WESTPARK COURT, Suite 201 PEACHTREE CITY, GA 30269 p. 800-432-8132

PRODUCT:

#### Resistor **3100 ALUMINUM**

STOREFRONT WALL-LMI



REVN DATE/REMARKS REV4 03.09.2022 UPDATE INTERLAYER

ENGINEER:



"ISULTANT ramar Parkway #301

mar. FL 33027 305-271-0117 mcy@mcyengineering MCYEngineering.com




ITROL APPROVAL:


T REVISED ing with the Florida


21-1216.10 Date 03/31/2025

e Product Control

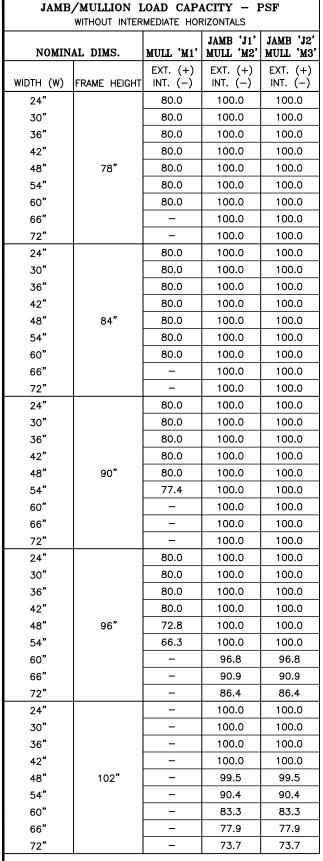


URMID	JAMB/MULLION LOAD CAPACITY - PSF WITHOUT INTERMEDIATE HORIZONTALS				
NOMIN	AL DIMS.	MULL 'M1'	JAMB 'J1' MULL 'M2'	JAMB 'J2' MULL 'M3'	
WIDTH (W)	FRAME HEIGHT	EXT. (+) INT. (–)	EXT. (+) INT. (-)	EXT. (+) INT. (–)	
24"		-	100.0	100.0	
30"		_	100.0	100.0	
36"		_	100.0	100.0	
42"	108"	ı	98.0	98.0	
48"	108	1	87.1	87.1	
54"		-	78.9	78.9	
60"		-	72.5	72.5	
66"		ı	67.6	67.6	
24"		1	100.0	100.0	١v
30"		_	100.0	100.0	
36"		_	98.2	98.2	
42"	114"	=	85.4	85.4	1
48"		-	76.0	76.0	İ
54"		_	69.0	69.0	ĺ
60"		_	63.5	63.5	İ
24"		-	100.0	100.0	İ
30"		-	99.5	99.5	İ
36"	120"	_	83.8	83.8	İ
42"	120	_	72.8	72.8	İ
48"		_	64.7	64.7	İ
54"		-	58.6	60.0	İ
60"		_	53.8	60.0	İ
24"		_	_	60.0	İ
30"		_	_	60.0	İ
36"		_	_	60.0	
42"	126"	_	_	60.0	İ
48"		_	_	60.0	
54"		_	_	60.0	l
24"		_	_	60.0	İ
30"		_	_	60.0	
36"		_	_	60.0	
42"	132"	_	_	60.0	
48"		_	_	60.0	
24"		_	_	60.0	l
30"		_	_	60.0	
36"		_	_	60.0	
42"	138"	_	_	60.0	
48"		_	_	60.0	
24"		_	_	60.0	
30"		_	_	60.0	
36"			_	60.0	
42"	144"	_	_	60.0	
42 48"			_	57.6	
40				37.0	l

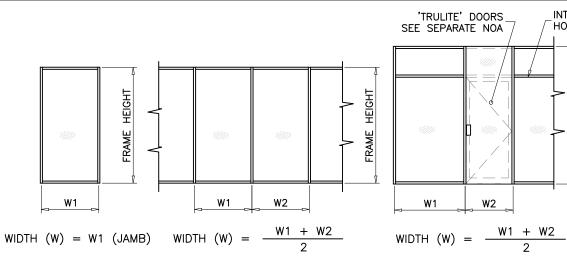

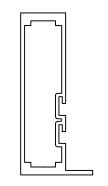


JAMB 'J1' | lx(lN^4) | Sx(lN^3) JAMB 3101 4.5480 1.8932

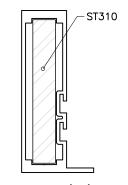


JAMB 'J2' STEEL REINFORCED

JAMB	lx(IN^4)	Sx(IN <sup>3</sup> )
3101	4.5480	1.8932
ST310	3.333X2.9	(IN ALUM.)
TOTAL (IN ALUM.)	14.2146	

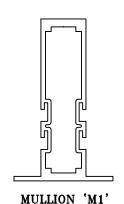


|MULLION|  $|x(IN^4)|$   $|Sx(IN^3)|$ 3102 5.0835 2.0348

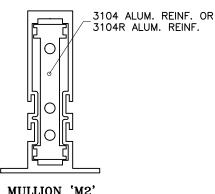

MULLION 'M2' ALUMINUM REINFORCED

MULLION	lx(IN^4)	Sx(IN^3)
3102	5.0835	2.0348
3104 / 3104R	2.7365	1.4483
TOTAL (IN ALUM.)	7.8200	_

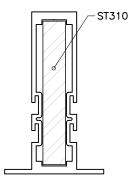

MULLION 'M3' STEEL REINFORCED

MULLION	lx(IN^4)	Sx(IN^3)
3102	5.0835	2.0348
ST310	3.333X2.9	(IN ALUM.)
TOTAL (IN ALUM.)	14.7501	1

STEP 3: MULLION LOAD CAPACITIES



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PRODUCT:

INTERMEDIATE

HORIZONTAL

#### Resistor 3100 ALUMINUM

STOREFRONT WALL-LMI



	REVN	DATE/REMAF	RKS	
	REV4	03.09.2022	UPDATE	INTERLAYER
ı				

**ENGINEER:** 



**GLAZING CONSULTANT** 

12781 Miramar Parkway #301 Miramar. FL 33027 P: 305-271-0117 Email: mcy@mcyengineering

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STAMP: YIPING WANG, P.E.
FLORIDA REGISTRATION
RE #55985 WILESSION PARTY 20


PRODUCT CONTROL APPROVAL:

March 10th, 2022


PRODUCT REVISED as complying with the Florida Building Code NOA-No. 21-1216.10


Expiration Date 03/31/2025

By Manuel Perez Miami-Dade Product Control

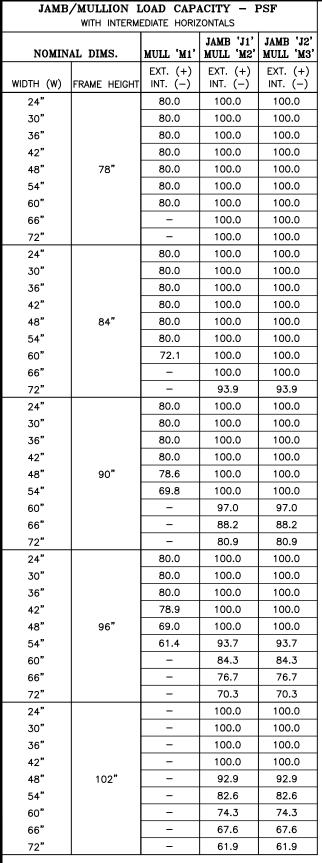


NOMIN	AL DIMS.	MULL 'M1'	JAMB 'J1' MULL 'M2'	JAMB 'Ja MULL 'M
		EXT. (+)	EXT. (+)	EXT. (+)
WIDTH (W)	FRAME HEIGHT	INT. (-)	INT. (-)	INT. (-)
24"		-	100.0	100.0
30 <b>"</b>		-	100.0	100.0
36"		_	100.0	100.0
42"	108"	_	94.7	94.7
48"	-	_	82.9	82.9
54"			73.7	73.7
60"			66.3	66.3
66"		-	60.3	60.3
24"		-	100.0	100.0
30 <b>"</b>	-	-	100.0	100.0
36"		_	94.5	94.5
42"	114"	_	81.0	81.0
48"		_	70.9	70.9
54"			63.0	63.0
60"		-	56.7	60.0
24"	120"		100.0	100.0
30"			97.3	97.3
36"		_	81.1	81.1
42"			69.5	69.5
48"		_	60.8	60.8
54"		_	54.0	60.0
60"		-	48.6	60.0
24"		_	-	60.0
30"		_	-	60.0
36"	126"	_	-	60.0
42"		-	-	60.0
48"		-	-	60.0
54"		-	-	60.0
24"		-	-	60.0
30"		-	-	60.0
36"	132"	-	-	60.0
42"		_	-	60.0
48"		-	-	60.0
24"		-	-	60.0
30"		-	-	60.0
36"	138"	-	-	60.0
42"		-	-	60.0
48"		-	-	60.0
24"		-	-	60.0
30"		-	-	60.0
36"	144"	_	_	60.0
42"	'**	_	_	60.0
48"		_	_	55.2

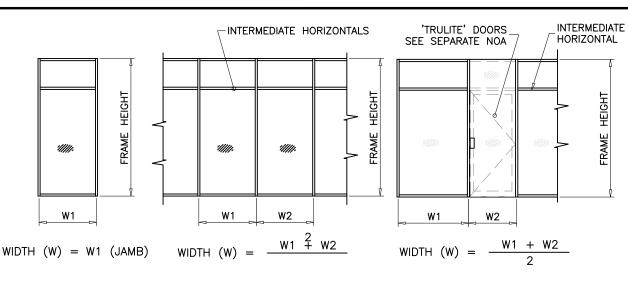

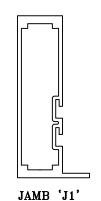


JAMB Ix(IN^4) Sx(IN^3)
3101 4.5480 1.8932

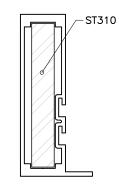


JAMB 'J2'
STEEL REINFORCED

JAMB	lx(IN^4)	Sx(IN^3)
3101	4.5480	1.8932
ST310	3.333X2.9	(IN ALUM.)
TOTAL (IN ALUM.)	14.2146	

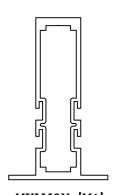


MULLION 'M1'

MULLION |x(IN^4) | Sx(IN^3) | 3102 | 5.0835 | 2.0348

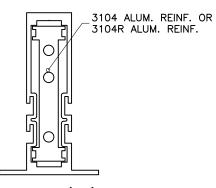

MULLION 'M2'
ALUMINUM REINFORCED

MULLION	lx(IN^4)	Sx(IN <sup>3</sup> )
3102	5.0835	2.0348
3104 / 3104R	2.7365	1.4483
TOTAL (IN ALUM.)	7.8200	_

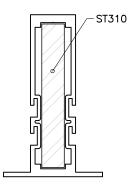

MULLION 'M3'
STEEL REINFORCED

MULLION	lx(IN^4)	Sx(IN^3)
3102	5.0835	2.0348
ST310	3.333X2.9	(IN ALUM.)
TOTAL (IN ALUM.)	14.7501	_

STEP 3: MULLION LOAD CAPACITIES



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PRODUCT:

# Resistor 3100 ALUMINUM

STOREFRONT WALL-LMI



	REVN	DATE/REMAR	RKS	
	REV4	03.09.2022	UPDATE	INTERLAYER
ı				


ENGINEER:



GLAZING CONSULTANT

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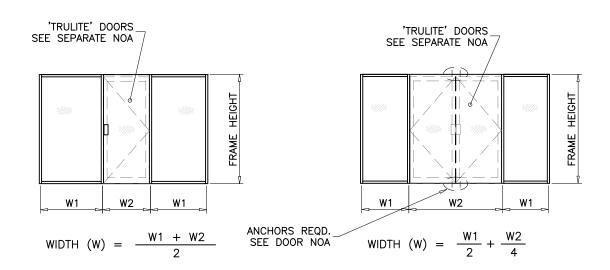
PRODUCT CONTROL APPROVAL:


product revised as complying with the Florida Building Code NOA-No. 21-1216.10

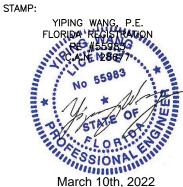Expiration Date 03/31/2025

By Manuel Perez Miami-Dade Product Confrol


DOC	R MULLION	LOAD CAPACITY	7 - PSF
NOMIN	AL DIMS.	WITHOUT REINFORCING	WITH REINFORCING
WIDTH (W)	1	EXT.(+) / INT.(-)	EXT.(+) / INT.(-)
30"		87.0	87.0
36"		87.0	87.0
42"	04 4 /4"	87.0	87.0
48"	81-1/4"	87.0	87.0
54"		_	87.0
60"		_	87.0
30"		87.0	87.0
36"		87.0	87.0
42"		87.0	87.0
48"	85-1/4"	84.5	87.0
54"		_	87.0
60"		_	87.0
30"		87.0	87.0
36"		87.0	87.0
42"		80.7	87.0
42 48"	91-1/4"		87.0
54 <b>"</b>		_	87.0
60 <b>"</b>		_	87.0
30"		87.0	
		87.0	87.0
36"		77.8	87.0
42"	97-1/4"	66.7	87.0
48"		_	87.0
54 <b>"</b>		_	87.0
60"		_	79.1
30 <b>"</b>		_	87.0
36"		_	87.0
42"	102"	_	87.0
48"		_	87.0
54 <b>"</b>		_	79.9
60"		_	71.9
30"		_	87.0
36"		<del>-</del>	87.0
42"	108"	_	87.0
48"		_	79.3
54"		_	70.5
60"		_	63.5
30"		_	87.0
36"		_	87.0
42"	114"	_	77.1
48"	'''	_	67.5
5 <b>4"</b>		_	60.0
60"		_	54.0
30"		_	87.0
36"		_	77.1
42"	120"	_	66.1
48"	120"		57.8
54"			51.4
60"			46.3



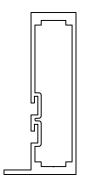

DOOR MULLION W/O REINF.

JAMB	lx(IN^4)	Sx(IN <sup>3</sup> )
3101	4.5480	1.8932

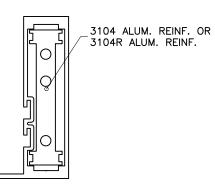

DOOR MULLION W/ ALUM. REINF.

JAMB	lx(IN^4)	Sx(IN^3)
3101	4.5480	1.8932
3104	2.7385	1.4483
TOTAL	7.2865	



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PRODUCT:

#### Resistor **3100 ALUMINUM**

STOREFRONT WALL-LMI



REVN DATE/REMARKS

REV4 03.09.2022 UPDATE INTERLAYER

ENGINEER:




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Miramar. FL 33027 P: 305-271-0117 Email: mcy@mcyengineering

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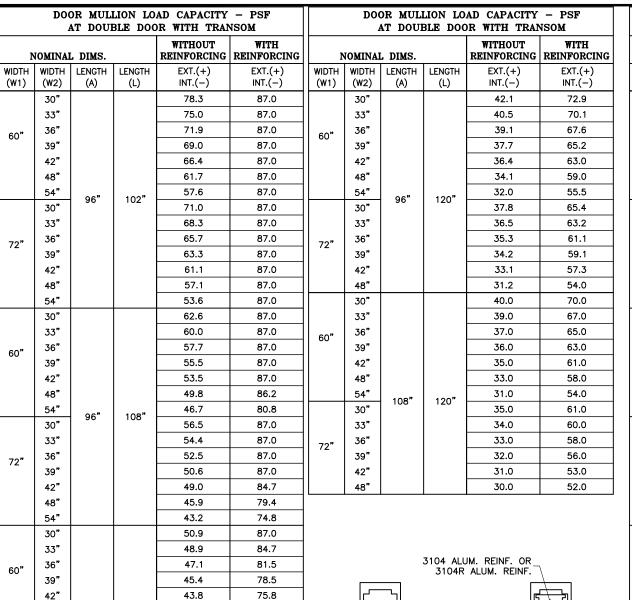
PRODUCT CONTROL APPROVAL:

PRODUCT REVISED
as complying with the Florida
Building Code NOA-No. 21-1216.10

Expiration Date 03/31/2025

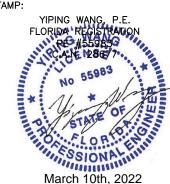By Manuel Perez Miami-Dade Product Confrol

STEP 3: MULLION LOAD CAPACITIES





	1	R WITH TRAI	TITH TRANSOM		
N	OMINA	L DIMS.		WITHOUT REINFORCING	WITH REINFORCING
WIDTH (W1)	WIDTH (W2)	LENGTH (A)	LENGTH (L)	EXT.(+) INT.(-)	EXT.(+) INT.(–)
	30"			87.0	87.0
	33"			87.0	87.0
60"	36"			84.2	87.0
60	39"			80.8	87.0
	42"			77.8	87.0
	48"			72.2	87.0
	54"	00"	06"	67.4	87.0
	30"	90"	96"	83.4	87.0
	33"			80.1	87.0
72"	36"			77.0	87.0
12	39"			74.2	87.0
	42"			71.6	87.0
	48"			66.9	87.0
	54"			62.7	87.0
	30"			73.8	87.0
	33"	90 <b>"</b>	102"	70.8	87.0
60"	36"			68.1	87.0
	39"			65.5	87.0
	42"			63.1	87.0
	48"			58.9	87.0
	54"			55.1	87.0
	30"			66.6	87.0
	33"			64.1	87.0
72"	36"			61.9	87.0
	39"			59.8	87.0
	42"			57.8	87.0
	48"			54.2	87.0
	54"			51.0	86.4
	30"			59.4	87.0
	33"			57.1	87.0
60"	36"			55.0	87.0
	39"			53.0	87.0
	42"			51.2	87.0
	48"			47.8	82.8
	54"	90"	108"	44.9	77.7
	30"			53.4	87.0
	33"			51.6	87.0 86.2
72"	36"			49.8 48.2	86.2 83.4
	39" 42"			46.6	80.7
	42 48"			43.9	75.9
	54"			41.4	71.6
	J 54			T 1.7	/ 1.0

DOOR MULLION LOAD CAPACITY - PSF

SOM		4	AT DOUI	BLE DOO	OR WITH TRAI	MOSM	
WITH REINFORCING	ı	OMINA	L DIMS.	WITHOUT REINFORCING	WITH REINFORCING		
EXT.(+) INT.(–)	WIDTH (W1)	WIDTH (W2)	LENGTH (A)	LENGTH (L)	EXT.(+) INT.(–)	EXT.(+) INT.(-)	
87.0		30"			48.7	84.3	
87.0		33"			46.9	81.2	
87.0	60"	36"			45.2	78.2	
87.0	"	39"			43.6	75.5	
87.0		42"			42.2	73.0	
87.0		48"			39.5	68.3	
87.0		54"	90"	114"	37.1	64.3	
87.0		30"	90		43.7	75.6	
87.0	WIDTH	33"			42.2	73.1	
87.0		36"			40.8	70.7	
87.0	'-	39"			39.5	68.4	
87.0	60"	42"			38.3	66.3	
87.0		48"			36.1	62.5	
87.0		54"			34.1	59.1	
87.0		30"			40.6	70.3	
87.0		33"			39.1	67.7	
87.0	60"	36"			37.7	65.3	
87.0		39"			36.5	63.1	
87.0		42"			35.3	61.0	
87.0		48"			33.1	57.2	
87.0		54"	90"	120"	31.1	53.9	
87.0		30"	90	120	36.3	62.9	
87.0		33"			35.1	60.8	
87.0	72"	36"			34.0	58.9	
87.0	'-	39"			33.0	57.0	
87.0	60"	42"			32.0	55.3	
87.0		48"			30.2	52.2	
86.4							
87.0			<del>-</del>			<del></del>	
87.0							
87.0			┷	<b>=</b> ₄= =	_		
87.0				\\\\\\\\\\\\\\\\\\\\\\\\\\\\\\\\\\\\\\	_ <b> </b>	<u> </u>	
	- 11		11	/ 111 \	II I	~ IT	

DOOR MULLION LOAD CAPACITY - PSF

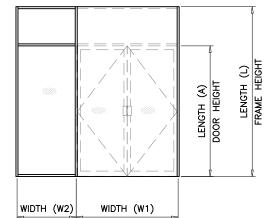

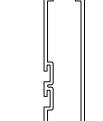

48"

54"

30"

33"

36"

39"

42"

48"

54"

72"

96"

114"

40.9

38.4

45.8

44.2

42.7

41.3

39.9

37.5

35.4

70.8

66.5

79.3

76.5

73.8

71.4

69.1

65.0

61.3

DOOR MULLION W/O REINF.

JAMB	lx(IN^4)	Sx(IN <sup>3</sup> )
3101	4.5480	1.8932

JAMB	lx(IN^4)	Sx(IN^3)
3101	4.5480	1.8932
3104	2.7385	1.4483
TOTAL	7.2865	

DOOR MULLION

W/ ALUM. REINF.



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PRODUCT:

# Resistor 3100 ALUMINUM

STOREFRONT WALL-LMI



REVN DATE/REMARKS
REV4 03.09.2022 UPDATE INTERLAYER

ENGINEER:



GLAZING CONSULTANT
12781 Miramar Parkway #301

Miramar. FL 33027
P: 305-271-0117
Email: mcy@mcyengineering
www.MCYEngineering.com

STAMP:



PRODUCT CONTROL APPROVAL:

PRODUCT REVISED
as complying with the Florida
Building Code
NOA-No. 21-1216.10

Expiration Date 03/31/2025

By Manuel Perez Miami-Dade Product Control

				AD CAPACITY OR WITH TRAI						AD CAPACITY OR WITH TRAI							
N	IOMINA	L DIMS.		WITHOUT REINFORCING	WITH REINFORCING	1	NOMINA	L DIMS.		WITHOUT REINFORCING	WITH REINFORCING						
WIDTH (W1)	WIDTH (W2)	LENGTH (A)	LENGTH (L)	EXT.(+) INT.(-)	EXT.(+) INT.(-)	WIDTH (W1)	WIDTH (W2)	LENGTH (A)	LENGTH (L)	EXT.(+) INT.(-)	EXT.(+) INT.(-)						
	30"			87.0	87.0		30"			56.8	87.0						
	33"			87.0	87.0		33"			54.7	87.0						
60"	36"			87.0	87.0	60"	36"			52.7	87.0						
	39"			87.0	87.0		39"			50.9	87.0						
	42"			87.0	87.0		42"			49.2	85.1						
	48"			82.7	87.0		48"			46.1	79.8						
	54"	84"	90"	77.3	87.0		54"	84"	108"	43.4	75.1						
	30"			87.0	87.0		30"			50.9	87.0						
	33"			87.0	87.0		33"			49.2	85.1						
72"	36"			87.0	87.0	72"	36"			47.6	82.4						
	39"			84.9	87.0		39"			46.1	79.8						
	42"			81.9	87.0		42"			44.7	77.4						
	48"			76.6	87.0		48"			42.1	72.9						
	54"			71.9	87.0		54"			39.9	69.0						
	30" 33"								87.0 84.0	87.0 87.0		30" 33"			46.9 45.2	81.2 78.3	
	36"										80.7	87.0		36"		43.7	75.5
60"	39"			77.7	87.0	60"	39"			42.2	73.0						
	42"			74.8	87.0		42"			40.8	70.6						
	48"			69.7	87.0		48"			38.3	66.3						
	54"	84"		65.3	87.0		54"			36.1	62.5						
	30"		96"	79.0	87.0		30"	84"	114"	42.0	72.6						
	33"							76.1	87.0		33"			40.6	70.3		
72"	36"							73.4	87.0	72"	36"			39.3	68.0		
/2	39" 42"				70.9	87.0	/2	39"			38.1	66.0					
				68.5	87.0		42"			37.0	64.0						
	48"			64.2	87.0		48"			34.9	60.4						
	54"			60.4	87.0		54"			33.1	57.2						
	30"			70.0	87.0		30"			39.3	68.1						
	33"			67.3	87.0		33"			38.0	65.7						
60"	36"			64.8	87.0	60"	36"			36.7	63.4						
	39"			62.4	87.0		39"			35.4	61.3						
	42"			60.3	87.0		42"			34.3	59.4						
	48"			56.4	87.0		48"			32.2	55.8						
	54"	84"	102"	53.0	87.0		54"	84"	120"	30.4	52.6						
	30"		'	62.8	87.0		30"		'	35.1	60.8						
	33"			60.7	87.0		33"			34.0	58.8						
72"	36"			58.6	87.0	72"	36" 39"			33.0	57.0						
	39"			56.7	87.0					32.0	55.3						
	42"			54.9	87.0		42"			31.0	53.7						
	48"			51.7	87.0		48"			29.3	50.8						
	54"			48.8	83.9						Δ						

	DOOR MULLION LOAD CAPACITY - PSF AT DOUBLE DOOR WITH TRANSOM									OAD CAPAC OR WITH T			
1	NOMINAI	L DIMS.		WITHOUT REINFORCING	WITH REINFORCING	ı	NOMINAL DIMS.			WITHOUT			
WIDTH	WIDTH	LENGTH	LENGTH	EXT.(+)	EXT.(+)	WIDTH	WIDTH	LENGTH	LENGTH	EXT.(+)			
(W1)	(W2)	(A)	(L)	INT.(-)	INT.(-)	(W1)	(W2)	(A)	(L)	INT.(-)			
	30"						87.0	87.0		30"			55.3
	33"			87.0	87.0		33"			53.3			
60"	36"			87.0	87.0	60"	36"			51.5			
	39"			87.0	87.0		39"			49.7			
	42"			86.6	87.0		42"			48.1			
	48"			80.7	87.0		48"			45.1			
	54"	80"	90"	75.5	87.0		54"	80"	108"	42.5			
	30"			87.0	87.0		30"			49.5			
	33"			87.0	87.0		33"			47.9			
72"	36"			85.1	87.0	72"	36"			46.4			
	39"			82.2	87.0		39"			44.9			
	42"			79.4	87.0		42"			43.6			
	48"			74.4	87.0		48"			41.2			
	54"			70.0	87.0		54"			39.0			
	30"			84.6	87.0		30"			45.9			
l	33"			81.3	87.0		33"			44.3			
60"	36"			78.3	87.0	60"	36"			42.8			
	39"			75.5	87.0		39"			41.4			
	42"			72.9	87.0		42"			40.0			
	48"			68.1	87.0		48"			37.6			
	54"	80"	96"	64.0	87.0		54"	80"	114"	35.5			
l	30"			76.1	87.0		30"			41.0			
	33"			73.4	87.0		33"			39.7			
72"	36"			70.9	87.0	72"	36"			38.5			
	39"			68.6	87.0		39"			37.3			
	42"			66.4	87.0		42"			36.2			
	48"			62.5	87.0		48"			34.3			
	54"			58.9	87.0		54"			32.5			
	30"			67.8	87.0		30"			38.7			
	33"			65.2	87.0		33"			37.3			
60"	36"			62.9	87.0	60"	36"			36.1			
	39"			60.7	87.0		39"			34.9			
	42"			58.7	87.0		42"			33.8			
	48"			55.0	87.0		48"			31.8			
	54"	80"	102"	51.7	87.0		54"	80"	120"	30.0			
	30"			60.7	87.0		30"			34.5			
	33"			58.7	87.0		33"			33.4			
72"	36"			56.8	87.0	72"	36"			32.4			
	39"			55.0	87.0		39"			31.4			
	42"			53.3	87.0		42"			30.5			
	48"			50.2	87.0		48"			28.9			

47.5

82.2

				AD CAPACITY OR WITH TRAI						AD CAPACITY OR WITH TRAI						
1	NOMINAI	L DIMS.		WITHOUT REINFORCING	WITH REINFORCING	NOMINAL DIMS.				WITHOUT REINFORCING	WITH REINFORCING					
WIDTH (W1)	WIDTH (W2)	LENGTH (A)	LENGTH (L)	EXT.(+) INT.(-)	EXT.(+) INT.(-)	WIDTH (W1)	WIDTH (W2)	LENGTH (A)	LENGTH (L)	EXT.(+) INT.(-)	EXT.(+) INT.(-)					
	30"			87.0	87.0		30"			55.3	87.0					
	33"			87.0	87.0		33"			53.3	87.0					
60"	36"			87.0	87.0		36"			51.5	87.0					
00	39"			87.0	87.0	60	39"			49.7	86.1					
	42"			86.6	87.0		42"			48.1	83.2					
	48"			80.7	87.0		48"			45.1	78.1					
	54"	80"	90"	75.5	87.0		54"	80"	100"	42.5	73.6					
	30"	80	90	87.0	87.0		30"	1 80	108"	49.5	85.6					
	33"			87.0	87.0		33"			47.9	82.8					
72 <b>"</b>	36"			85.1	87.0	72"	36"			46.4	80.2					
/2	39"			82.2	87.0	'2	39"			44.9	77.8					
	42"			79.4	87.0		42"			43.6	75.5					
	48"			74.4	87.0	.	48"			41.2	71.2					
	54"			70.0	87.0		54"			39.0	67.5					
	30"			84.6	87.0		30"			45.9	79.5					
	33"			81.3	87.0		33"			44.3	76.7					
60"	36"			78.3	87.0	60"	36"			42.8	74.1					
60	39"								75.5	87.0	60	39"			41.4	71.6
	42"						72.9	87.0		42"			40.0	69.3		
	48"			68.1	87.0		48"			37.6	65.1					
	54"	"		64.0	87.0		54"			35.5	61.4					
	30"	80"	96"	76.1	87.0		30"	80"	114"	41.0	71.0					
	33"						73.4	87.0		33"			39.7	68.7		
72"	36"				70.9	87.0	72"	36"			38.5	66.6				
12	39"			68.6	87.0	/2	39"			37.3	64.6					
	42"			66.4	87.0		42"			36.2	62.7					
	48"			62.5	87.0		48"			34.3	59.3					
	54"			58.9	87.0		54"			32.5	56.2					
	30"			67.8	87.0		30"			38.7	66.9					
	33"			65.2	87.0		33"			37.3	64.6					
60"	36"			62.9	87.0	60"	36"			36.1	62.4					
60"	39"			60.7	87.0	60"	39"			34.9	60.4					
	42"			58.7	87.0		42"			33.8	58.5					
	48"			55.0	87.0		48"			31.8	55.0					
	54"		51.7 87.0 54"			465"	30.0	51.9								
	30"	80″		80"	120"	34.5	59.7									
	33"			58.7	87.0		33"			33.4	57.8					
70"	36"			56.8	87.0	70"	36"			32.4	56.0					
72"	1	l	I			72"	1	I	l							



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PRODUCT:

#### Resistor **3100 ALUMINUM**

STOREFRONT WALL-LMI



REVN DATE/REMARKS

REV4 03.09.2022 UPDATE INTERLAYER


ENGINEER:

# MCY ENGINEERING, INC.

GLAZING CONSULTANT

12781 Miramar Parkway #301 Miramar. FL 33027 P: 305-271-0117 Email: mcy@mcyengineering

www.MCYEngineering.com

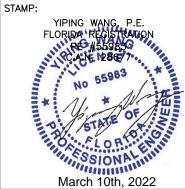


PRODUCT CONTROL APPROVAL:

PRODUCT REVISED
as complying with the Florida
Building Code NOA-No. 21-1216.10

Expiration Date 03/31/2025

By Manuel Perez Miami-Dade Product Confroi

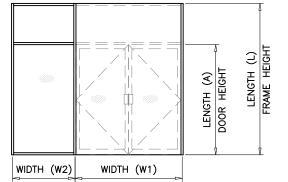


54.4

52.9

50.0

	AN		AD CAPACI +) & INT.(-		,	
NOMIN	AL DIMS.	ANO	CHORS TYPE	'A'	TYPE 'B	, % ,C,
WIDTH (W)	FRAME HEIGHT	'A2'	'A3'	'A4'	'B1'/'C1'	'B2'/'C2'
24"		100.0	100.0	100.0	100.0	100.0
30"		100.0	100.0	100.0	100.0	100.0
36"		100.0	100.0	100.0	100.0	100.0
42"		100.0	100.0	100.0	100.0	100.0
48"	66"	100.0	100.0	100.0	100.0	100.0
54 <b>"</b>		95.4	100.0	100.0	95.8	100.0
60"		85.8	100.0	100.0	86.2	100.0
66"		78.0	100.0	100.0	78.3	100.0
72"		71.5	100.0	100.0	71.8	100.0
24"		100.0	100.0	100.0	100.0	100.0
30"		100.0	100.0	100.0	100.0	100.0
36"		100.0	100.0	100.0	100.0	100.0
42"		100.0	100.0	100.0	100.0	100.0
48"	72"	98.3	100.0	100.0	98.8	100.0
54"		87.4	100.0	100.0	87.8	100.0
60"		78.7	100.0	100.0	79.0	100.0
66"		71.5	100.0	100.0	71.8	100.0
72"		65.6	91.8	100.0	65.8	100.0
24"		100.0	100.0	100.0	100.0	100.0
30"		100.0	100.0	100.0	100.0	100.0
36"		100.0	100.0	100.0	100.0	100.0
42"		100.0	100.0	100.0	100.0	100.0
48"	78"	90.8	100.0	100.0	91.2	100.0
54"		80.7	100.0	100.0	81.0	100.0
60"		72.6	100.0	100.0	72.9	100.0
66"		66.0	92.4	100.0	66.3	100.0
72"		60.5	84.7	100.0	60.8	100.0
24"		100.0	100.0	100.0	100.0	100.0
30"		100.0	100.0	100.0	100.0	100.0
36"		100.0	100.0	100.0	100.0	100.0
42"		96.3	100.0	100.0	96.7	100.0
48"	84"	84.3	100.0	100.0	84.6	100.0
54 <b>"</b>		74.9	100.0	100.0	75.2	100.0
60"		67.4	94.4	100.0	67.7	100.0
66"		61.3	85.8	100.0	61.6	100.0
72"		56.2	78.7	100.0	56.4	94.0
24"		100.0	100.0	100.0	100.0	100.0
30"		100.0	100.0	100.0	100.0	100.0
36"		100.0	100.0	100.0	100.0	100.0
42"		89.9	100.0	100.0	90.3	100.0
48"	90"	78.7	100.0	100.0	79.0	100.0
54"		69.9	97.9	100.0	70.2	100.0
60 <b>"</b>		62.9	88.1	100.0	63.2	100.0
66"		57.2	80.1	100.0	57.5	95.8
72"		52.4	73.4	94.4	52.7	87.8
24"		100.0	100.0	100.0	100.0	100.0
30"		100.0	100.0	100.0	100.0	100.0
36"		98.3	100.0	100.0	98.8	100.0
42"	96"	84.3	100.0	100.0	84.6	100.0
48"	"	73.8	100.0	100.0	74.1	100.0
54"		65.6	91.8	100.0	65.8	100.0
60 <b>"</b>		59.0	82.6	100.0	59.3	98.8
66"		53.6	75.1	96.5	53.9	89.8

NOMINAL DIMS. ANCHORS TYPE 'A' TYPE 'B' & 'C'									
WIDTH (W)	FRAME HEIGHT	'A2'	'A3'	'A4'	'B1'/'C1'	'B2'/'			
24"		100.0	100.0	100.0	100.0	100.0			
30"		100.0	100.0	100.0	100.0	100.0			
36"		92.5	100.0	100.0	92.9	100.0			
42"	100"	79.3	100.0	100.0	79.7	100.0			
48"	102"	69.4	97.2	100.0	69.7	100.0			
54"		61.7	86.4	100.0	62.0	100.0			
60"		55.5	77.7	100.0	55.8	92.9			
24"		100.0	100.0	100.0	100.0	100.0			
30"		100.0	100.0	100.0	100.0	100.0			
36"		87.4	100.0	100.0	87.8	100.0			
42"	108"	74.9	100.0	100.0	75.2	100.0			
48"		65.6	91.8	100.0	65.8	100.0			
54"		58.3	81.6	100.0	58.5	97.5			
60"		52.4	73.4	94.4	52.7	87.8			
24"		100.0	100.0	100.0	100.0	100.0			
30"		99.4	100.0	100.0	99.8	100.0			
36"		82.8	100.0	100.0	83.2	100.0			
42"	114"	71.0	99.4	100.0	71.3	100.0			
48"		62.1	86.9	100.0	62.4	100.0			
54"		55.2	77.3	99.4	55.4	92.4			
24"		100.0	100.0	100.0	100.0	100.0			
30"		94.4	100.0	100.0	94.8	100.0			
36"		78.7	100.0	100.0	79.0	100.0			
42"	120"	67.4	94.4	100.0	67.7	100.0			
48"	ŀ	59.0	82.6	100.0	59.3	98.8			
54 <b>"</b>		52.4	73.4	94.4	52.7	87.8			
24"		60.0	60.0	60.0	60.0	60.0			
30"		60.0	60.0	60.0	60.0	60.0			
36 <b>"</b>		60.0	60.0	60.0	60.0	60.0			
42"	126"	60.0	60.0	60.0	60.0	60.0			
42 48"		56.2	60.0	60.0	56.4	60.0			
54 <b>"</b>		49.9	60.0	60.0	50.2	60.0			
24"		60.0	60.0	60.0	60.0	60.0			
24 30"		60.0	60.0	60.0	60.0	60.0			
36"	132"	60.0	60.0	60.0	60.0	60.0			
42"	132	60.0	60.0	60.0	60.0	60.0			
48"		53.6	60.0	60.0	53.9	60.0			
24"		60.0	60.0	60.0	60.0	60.0			
	-					<b>-</b>			
30"	170"	60.0	60.0	60.0	60.0	60.0			
36"	138"	60.0	60.0	60.0	60.0	60.0			
42"		58.6	60.0	60.0	58.9	60.0			
48"		51.3	60.0	60.0	51.5	60.0			
24"		60.0	60.0	60.0	60.0	60.0			
30"		60.0	60.0	60.0	60.0	60.0			
36"	144"	60.0	60.0	60.0	60.0	60.0			
42"		56.2	60.0	60.0	56.4 49.4	60.0 60.0			

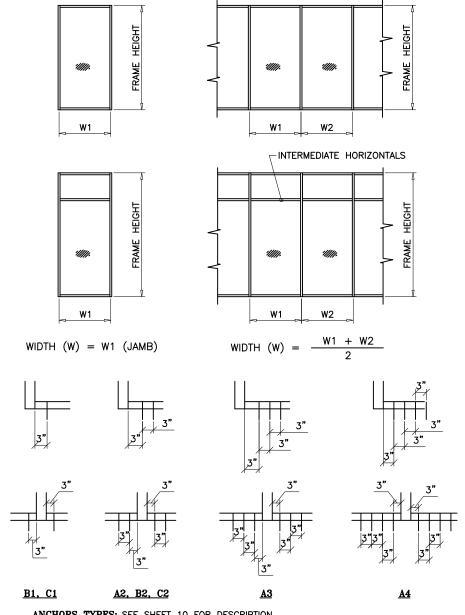

ANCHORS TYPES: SEE SHEET 10 FOR DESCRIPTION

 $B1 = (\mbox{1})$  anchor type 'B' at each side of mullion or Jamb  $C1 = (\mbox{1})$  anchor type 'C' at each side of mullion or Jamb

A2=(2) ANCHORS TYPE 'A' AT EACH SIDE OF MULLION OR JAMB B2=(2) ANCHORS TYPE 'B' AT EACH SIDE OF MULLION OR JAMB C2=(2) ANCHORS TYPE 'C' AT EACH SIDE OF MULLION OR JAMB

A3 = (3) ANCHORS TYPE 'A' AT EACH SIDE OF MULLION OR JAMB

A4 = (4) ANCHORS TYPE 'A' AT EACH SIDE OF MULLION OR JAMB

MAXIMUM SPACING FOR HEAD AND SILL ANCHORS NOT TO EXCEED 24" O.C.

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PRODUCT:

#### Resistor **3100 ALUMINUM**

STOREFRONT WALL-LMI



REVN DATE/REMARKS REV4 03.09.2022 UPDATE INTERLAYER

ENGINEER:



GLAZING CONSULTANT

12781 Miramar Parkway #301 Miramar. FL 33027 P: 305-271-0117

Email: mcy@mcyengineering www.MCYEngineering.com

STAMP: YIPING WANG, P.E. FLORIDA REGISTRATION RE #55983 "INSSION POR


March 10th, 2022

PRODUCT CONTROL APPROVAL:

**PRODUCT REVISED** as complying with the Florida Building Code NOA-No. 21-1216.10

Expiration Date 03/31/2025

By Manuel Perez Miami-Dade Product Confrol

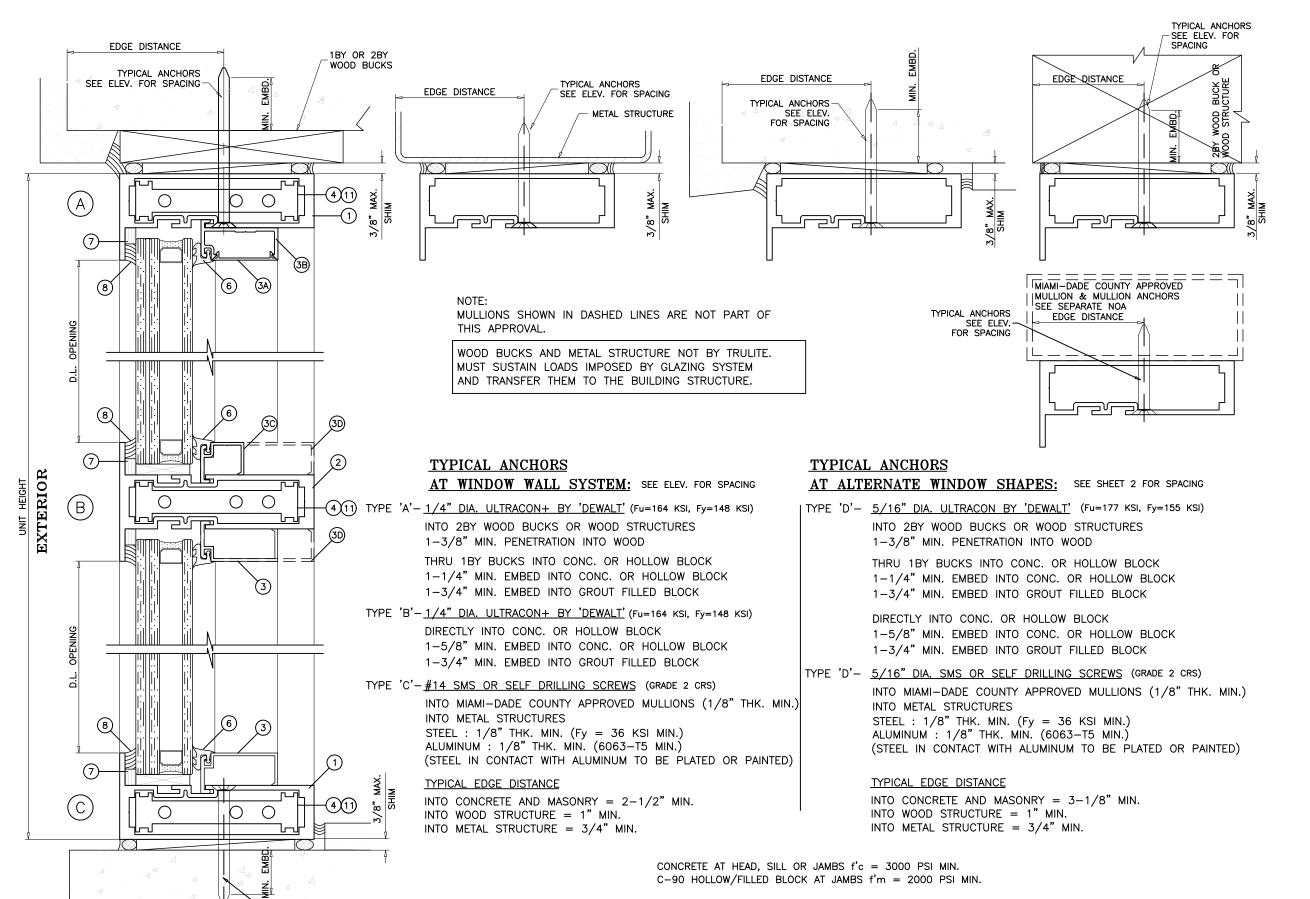

EDGE DISTANCE

TYPICAL ANCHORS SEE ELEV. FOR SPACING **♦ Trulite**GLASS & ALUMINUM SOLUTIONS

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403 WESTPARK COURT, Suite 201 PEACHTREE CITY, GA 30269 p. 800-432-8132

PRODUCT:

# Resistor 3100 ALUMINUM

STOREFRONT WALL-LMI



REVN DATE/REMARKS

REV4 03.09.2022 UPDATE INTERLAYER

ENGINEER:

### MCY ENGINEERING, INC.

GLAZING CONSULTANT

12781 Miramar Parkway #301 Miramar. FL 33027 P: 305-271-0117 Email: mcy@mcyengineering

www.MCYEngineering.com

STAMP:




PRODUCT CONTROL APPROVAL:


PRODUCT REVISED
as complying with the Florida
Building Code
NOA-No. 21-1216.10


Expiration Date 03/31/2025

By *Manuel Perez*Miami-Dade Product Conyrol

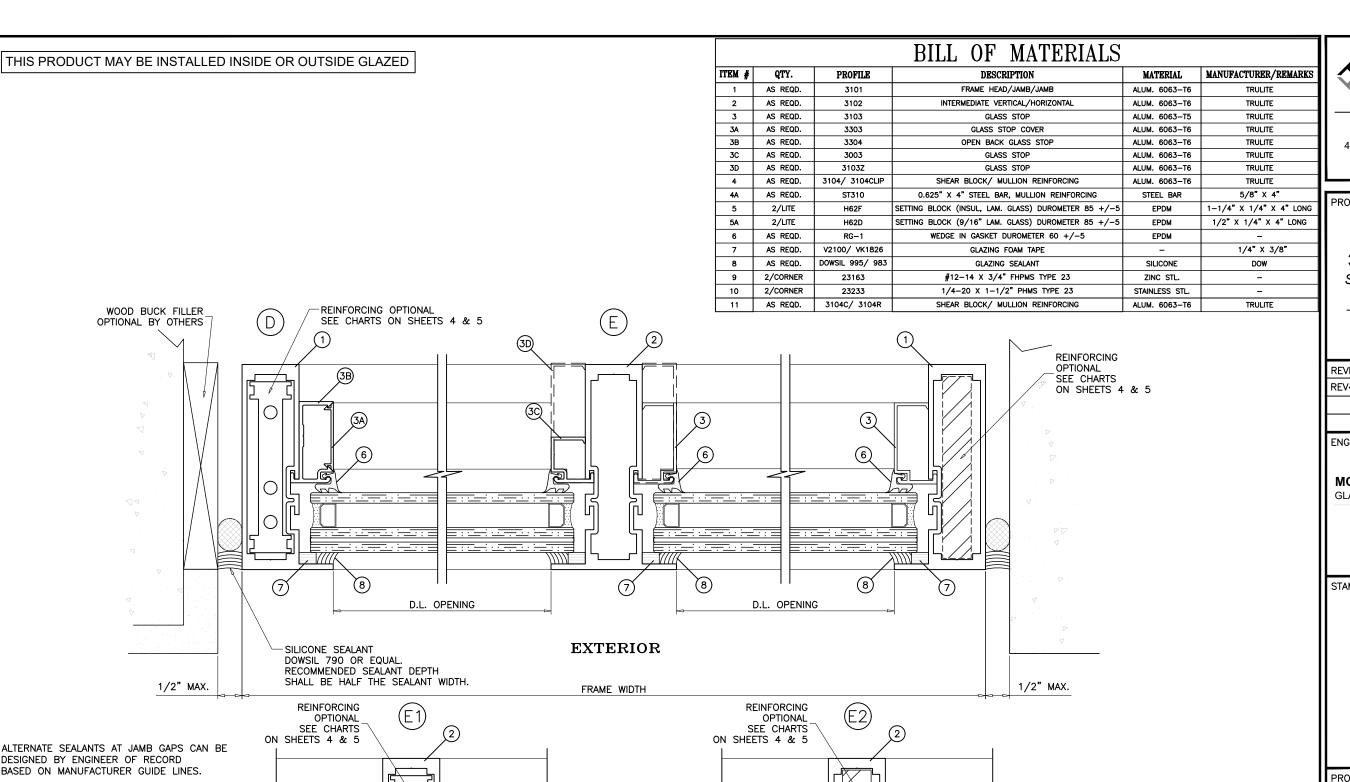

ALTERNATE SEALANTS AT JAMB GAPS CAN BE DESIGNED BY ENGINEER OF RECORD BASED ON MANUFACTURER GUIDE LINES.

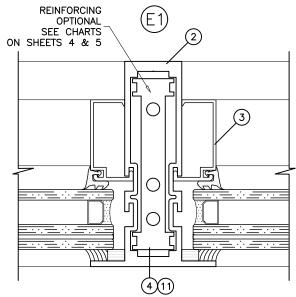

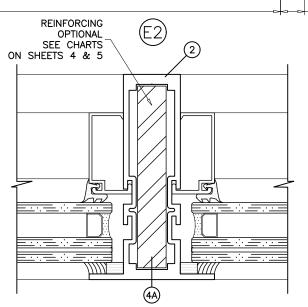



http://www.trulite.com

403 WESTPARK COURT, Suite 201 PEACHTREE CITY, GA 30269 p. 800-432-8132

PRODUCT:

#### Resistor 3100 ALUMINUM

STOREFRONT WALL-LMI



REVN DATE/REMARKS REV4 03.09.2022 UPDATE INTERLAYER

ENGINEER:

### MCY ENGINEERING, INC.

**GLAZING CONSULTANT** 

12781 Miramar Parkway #301 Miramar. FL 33027 P: 305-271-0117 Email: mcy@mcyengineering www.MCYEngineering.com

STAMP:





PRODUCT CONTROL APPROVAL:

**PRODUCT REVISED** as complying with the Florida Building Code NOA-No. 21-1216.10

Expiration Date 03/31/2025

By Manuel Perez Miami-Dade Product Confrol

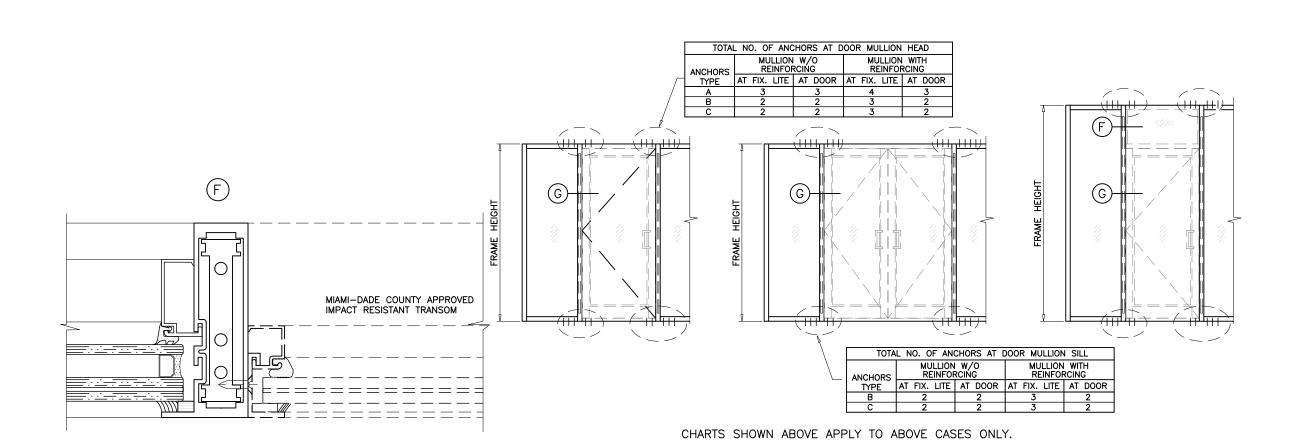

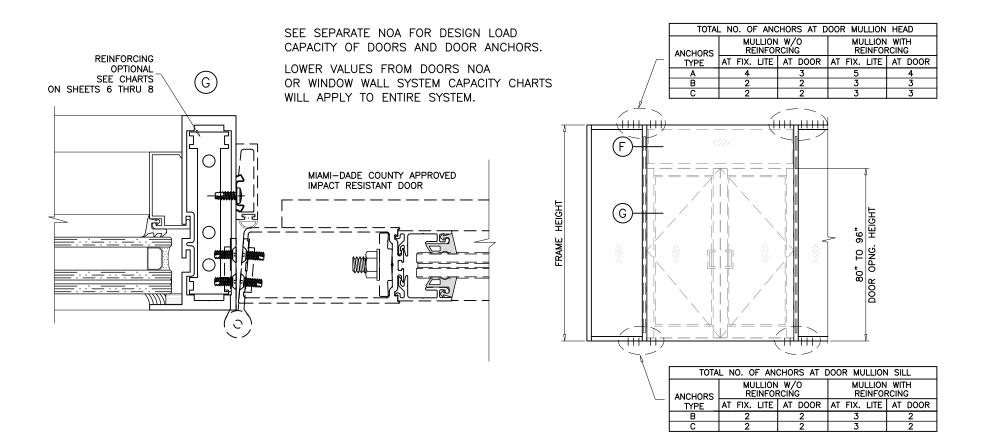



http://www.trulite.com

403 WESTPARK COURT, Suite 201 PEACHTREE CITY, GA 30269 p. 800-432-8132

PRODUCT:

#### Resistor 3100 ALUMINUM

STOREFRONT WALL-LMI



REVN DATE/REMARKS

REV4 03.09.2022 UPDATE INTERLAYER

ENGINEER:

### MCY ENGINEERING, INC.

GLAZING CONSULTANT

12781 Miramar Parkway #301 Miramar. FL 33027 P: 305-271-0117

Email: mcy@mcyengineering www.MCYEngineering.com

STAMP:




PRODUCT CONTROL APPROVAL:

PRODUCT REVISED
as complying with the Florida
Building Code
NOA-No. 21-1216.10

Expiration Date 03/31/2025

By *Manuel Perez*Miami-Dade Product Control

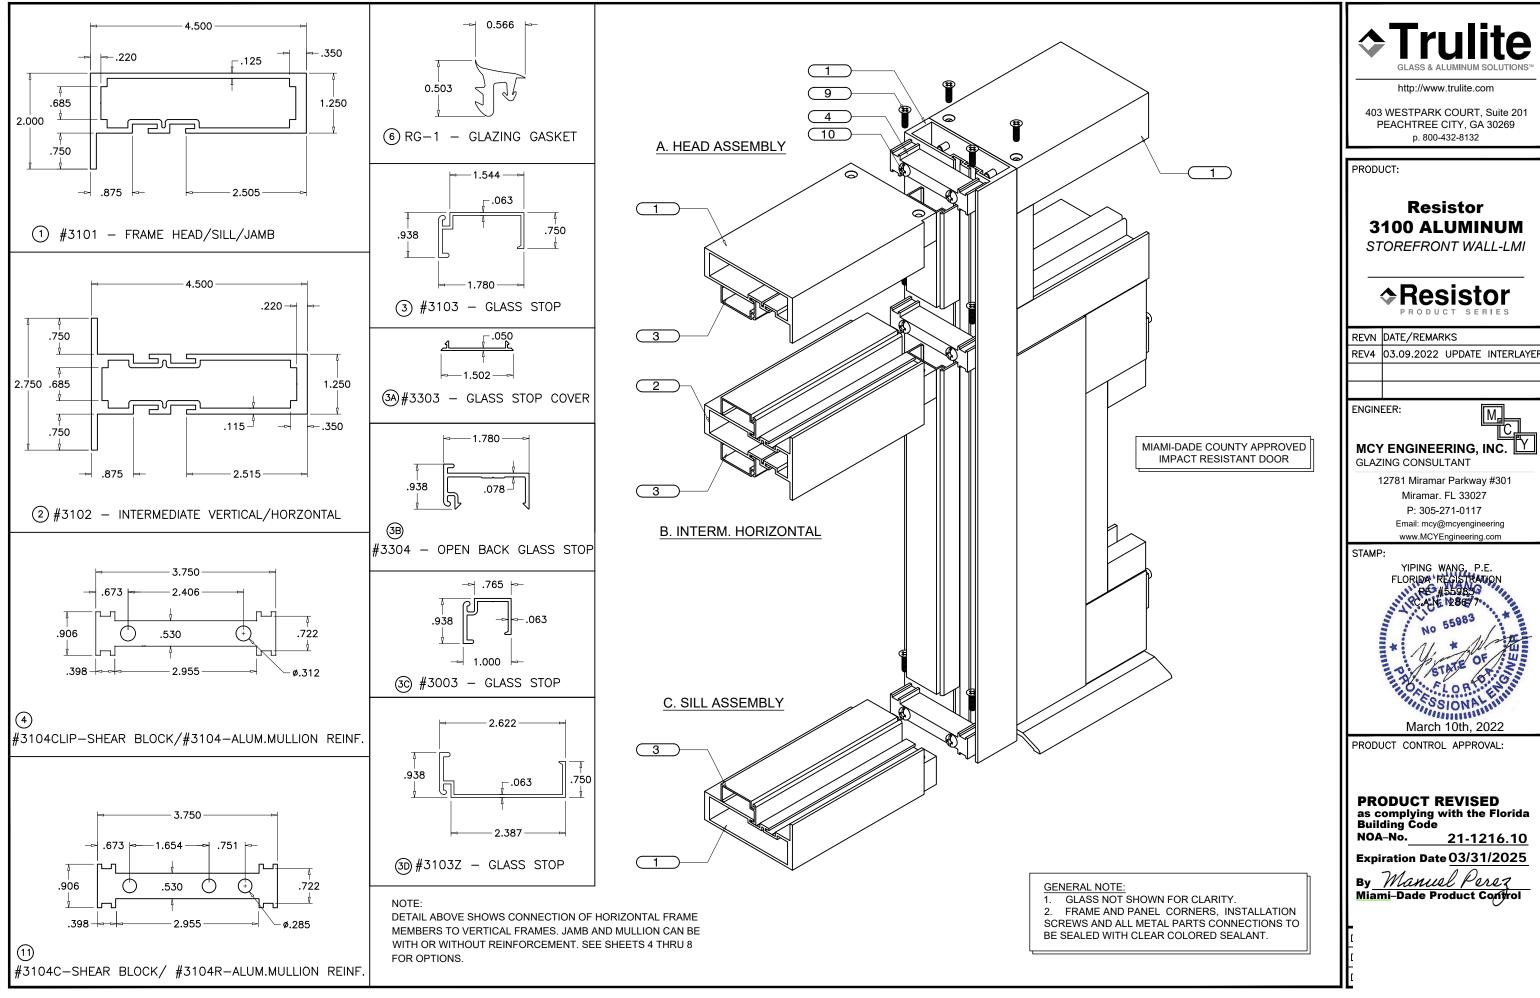



http://www.trulite.com

403 WESTPARK COURT, Suite 201 PEACHTREE CITY, GA 30269

### **3100 ALUMINUM**

STOREFRONT WALL-LMI



### MCY ENGINEERING, INC.

12781 Miramar Parkway #301 Miramar. FL 33027 P: 305-271-0117

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WWW. SION CO.

PRODUCT REVISED as complying with the Florida Building Code

By Manuel Perez Miami-Dade Product Confrol