SITE PLAN

THE EDISON PEMBROKE PINES

PHASE 2

CITY OF PEMBROKE PINES BROWARD COUNTY, FLORIDA SECTION 15/22, TOWNSHIP 51, RANGE 40





612 SW 4th Ave., Fort Lauderdale, FL 33315 | LCC 000237 YEL: 954-764-8858 | EHAIL: HJohnson earchalt.net

LEGAL DESCRIPTION:

SAID LAND SITUATED IN THE CITY OF PEMBROKE PINES, BROWARD COUNTY, FLORIDA, AND CONTAIN 24.58 ACRES.





DWG NO:	DRAWING TITLE
SP-0	SITE PLAN - COVER SHEET
SP-1	SITE PLAN
SP-2	SITE PLAN
SP-3	SITE PLAN
SP-4	SITE PLAN DETAILS
EX-E	CONCEPTUAL FINISH BOARD
A-2.0	REFUSE VEHICLE CIRCULATION DIAGRAM
A-2.1	LEVEL 1
A-2.2 A-2.3	LEVEL 2
A-2.3 A-2.4	LEVEL 3 LEVEL 4-6
A-2.4	LEVEL 7
A-3.1	BUILDING ELEVATIONS
A-3.2	BUILDING ELEVATIONS
A-3.3	SECTION DIAGRAMS
A-3.4	RENDERINGS
A-4.1	UNIT PLANS
A-4.2	UNIT PLANS
	OVERALL LANDSCAPE PLAN
	LANDSCAPE PLAN LANDSCAPE PLAN
L-202	
	LANDSCAPE PLANT SCHEDULE AND CALCS LANDSCAPE NOTES AND DETAILS
L-210	TREE DISPOSITION PLAN
	OVERALL DETAILS LAYOUT PLAN
L-501	PAVING AND DETAILS PLAN
	PAVING AND DETAILS PLAN
L-503	SITE DETAILS
L-504	SITE DETAILS
	SITE DETAILS
L-506	SITE DETAILS
	SITE DETAILS
L-508	SITE DETAILS
L-509	SITE DETAILS
	ELECTRICAL SITE PLAN - AREA 1
E012	ELECTRICAL SITE PLAN - AREA 2
E013	ELECTRICAL SITE PLAN - AREA 3
E801	LIGHTING FIXTURE CUTSHEETS
	PHOTOMETRIC GARAGE LEVEL 1
	PHOTOMETRIC GARAGE LEVEL 2 PHOTOMETRIC GARAGE LEVEL 3
	PHOTOMETRIC GARAGE LEVEL 4
	PHOTOMETRIC GARAGE LEVEL 5
	CIVIL COVER SHEET
C-1	GENERAL NOTES & SPECIFICATIONS
PG-1	PAVING AND GRADING PLAN
PG-2	PAVING AND GRADING PLAN PAVING AND GRADING DETAILS
PG-3 D-1	DRAINAGE PLAN - PHASE 2A
D-2	DRAINAGE PLAN
D-3	DRAINAGE PLAN
D-4	DRAINAGE DETAILS
D-5	DRAINAGE DETAILS
WS-1	WATER AND SANITARY SEWER PLAN - PHASE 2A
WS-2	WATER AND SANITARY SEWER PLAN
WS-3 WS-4	WATER AND SANITARY SEWER PLAN
WS-4 WS-5	WATER AND SANITARY SEWER DETAILS WATER AND SANITARY SEWER DETAILS
PMS-1	PAVEMENT MARKING AND SIGNAGE PLAN
1 100 -1	
PMS-2	PAVEMENT MARKING AND SIGNAGE DETAILS
PMS-2 PMS-3	
PMS-3	
PMS-3 FA-1	FIRE ACCESS PLAN
PMS-3 FA-1 FA-2	




Engineering, Botek

RTF PROJECT # 16-1204.3

PROJECT DATE: 08-06-21

SP-0

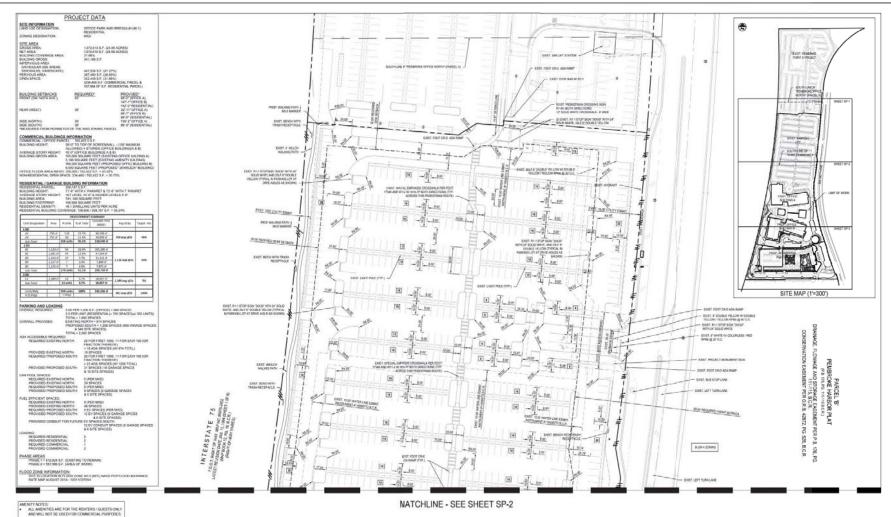



BTE PROJECT # 16-1204.3


THE EDISON PEMBROKE PINES
PHASE 2
PEMBROKE PINES, FL 33027


Engineering, Inc. Botek Thurlow

PROJECT DATE: 08-06-21

SHEET ∦:

SP-1

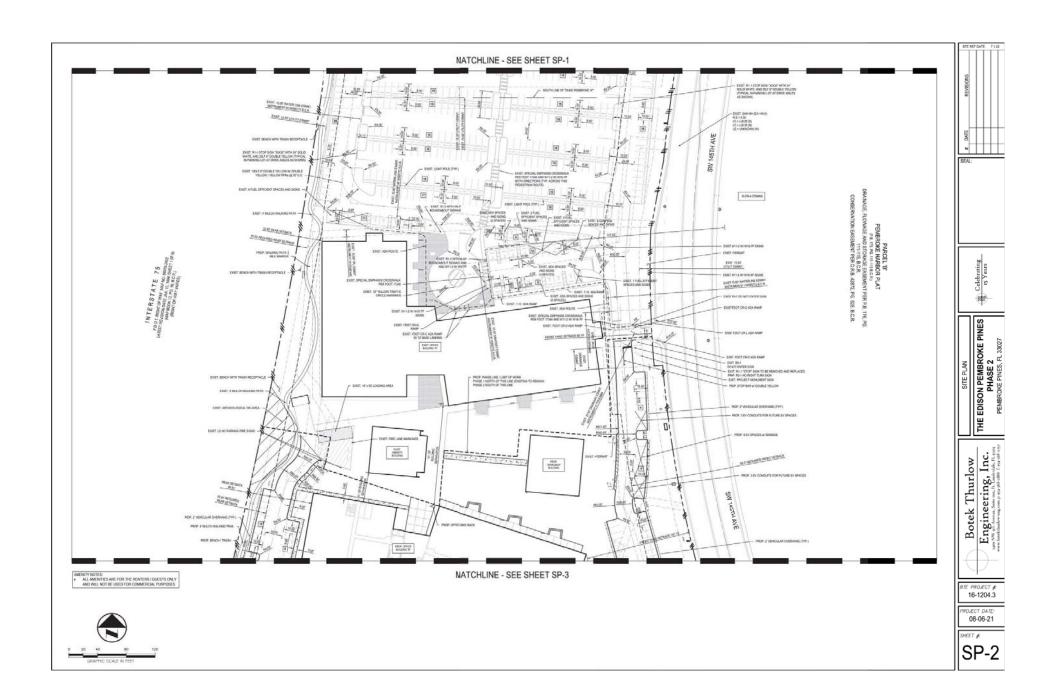

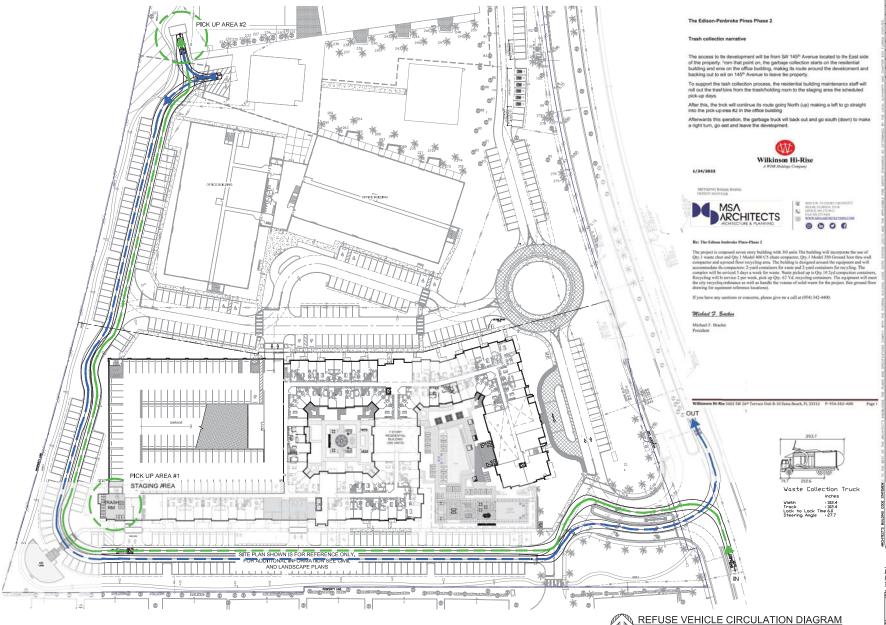

THE EDISON-PEMBROKE
AACOOMS TO THE EDISON-PEMBROKE
PHASE-2
SUE 1913 OF THE EDISON-PEMBROKE
PLOSTED AT THE EDISON-PEMBROKE
PL

PINES

BY

DRAWN
DATE 09/17/2021
SCALE AS SHOWN
JOB NO. 2059.PRJ
SHEET TITLE:
REFUSE VEHICLE


CIRCULATION DIAGRAM SHEET NUMBER:

A-2.0

DRC RESUBMITTAL #2 07/01/2022

NORTH

SCALE: 1"=40'-0"

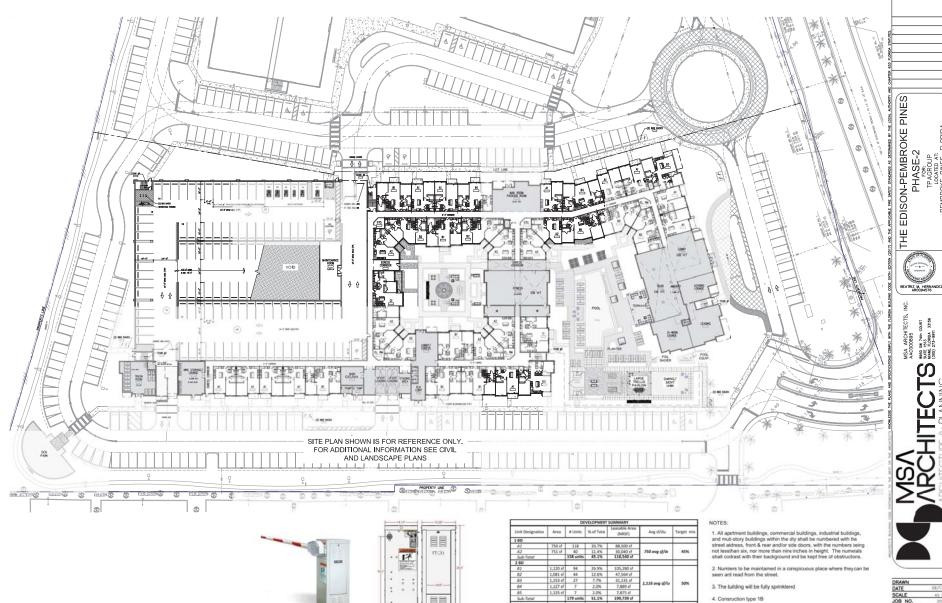

TYPICAL ARM BARRIER GATE DETAILS

NOTE: FINAL ARM GATE TBD AT THE CONSTRUCTION DOCUMENT PHASE

1,389 avg st/lu

961 ovg sf/dv 100%

5%

5. Building is not light-frame type construction




SCALE: 1"=30'-0"

NORTH DRC RESUBMITTAL #2 07/01/2022

BY

SHEET NUMBER:

A-2.1

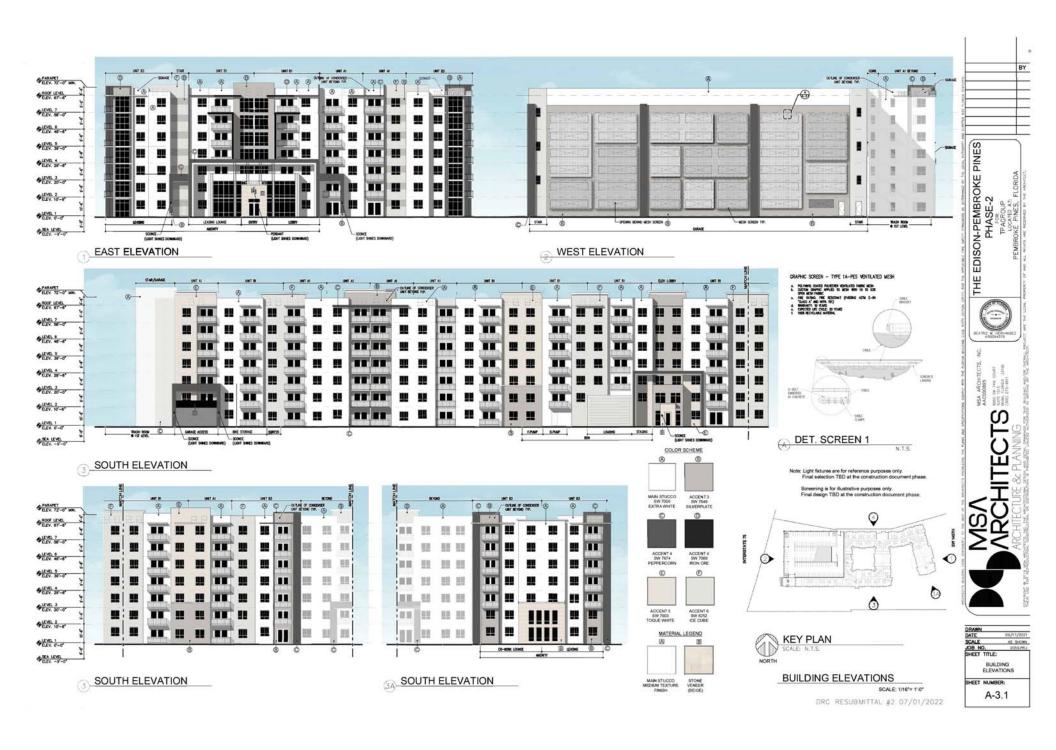






1 DAYLIGHT RENDERING



1 DUSK RENDERING

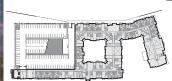




RENDERINGS

[DRC RESUBMITTAL #2 07/01/2022

THE EDISON-PEMBROKE PINES PHASE-2

RENDERINGS

SHEET NUMBER: A-3.4

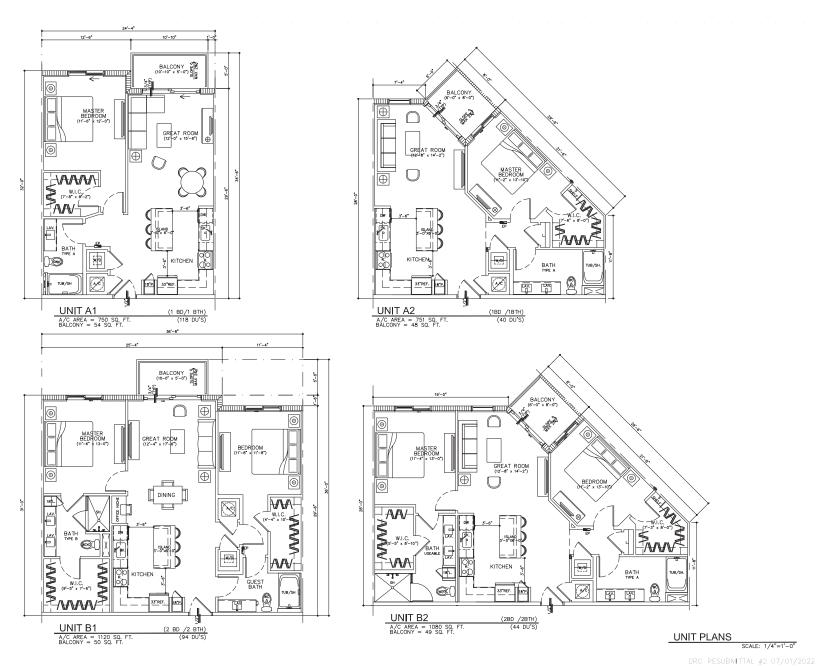

DRAWN DATE. As JOHN N. 2009-PR. TITLE: UNIT PLANS

SHEET TITLE:

UNIT PLANS

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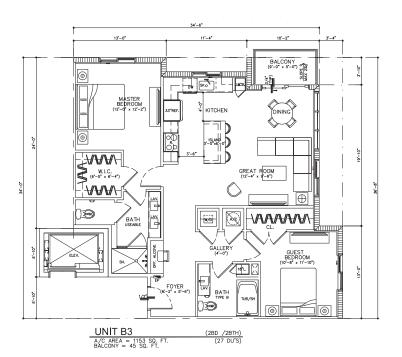
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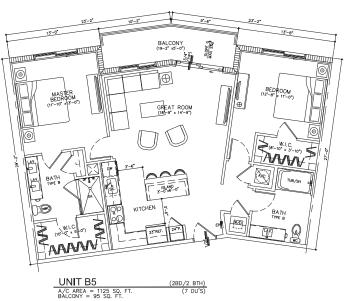
UNIT PLANS


SHEET TITLE:

UNIT

THE EDISON-PEMBROKE PINES PHASE-2





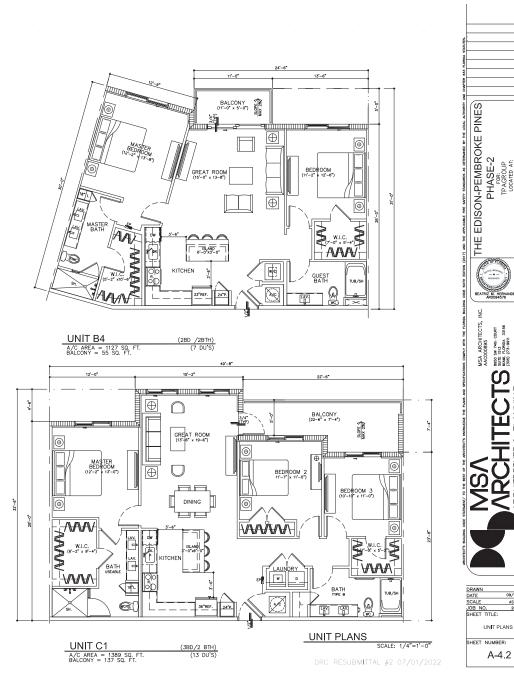


09/17/2021 AS SHOWN

UNIT PLANS

A-4.2



MASSING MODEL - VIEW FROM ACROSS THE STREET FACING NORTH WEST.

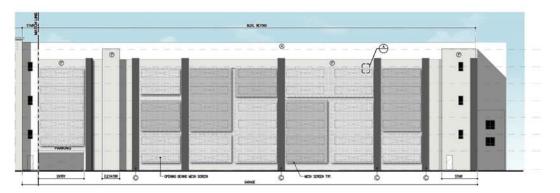

TYPICAL GARAGE ELEVATION SCALE: 1/16"= 1'-0" MATERIAL EXAMPLES




VERTICAL PICKET RAILING (SILVER)



LIME STONE VENEER COLOR: BEIGE LIME STONE (OR APPROVED EQUAL).




SCORE LINES

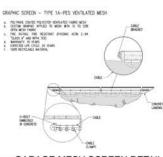

GARAGE MESH SCREEN DETAIL

COLOR SCHEME

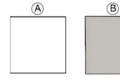

MAIN STUCCO SW 7006 **EXTRA WHITE**

ACCENT 3 SW 7649 SILVERPLATE



(D)

ACCENT 4 SW 7674 PEPPERCORN

ACCENT 4 SW 7069 IRON ORE




F

ACCENT 5 SW 7003 TOQUE WHITE

ACCENT 6 SW 6252 ICE CUBE

MATERIAL LEGEND

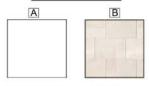

MAIN STUCCO MEDIUM TEXTURE **FINISH**


STONE VENEER (BEIGE)


CONCEPTUAL SAMPLE BOARD



PINES



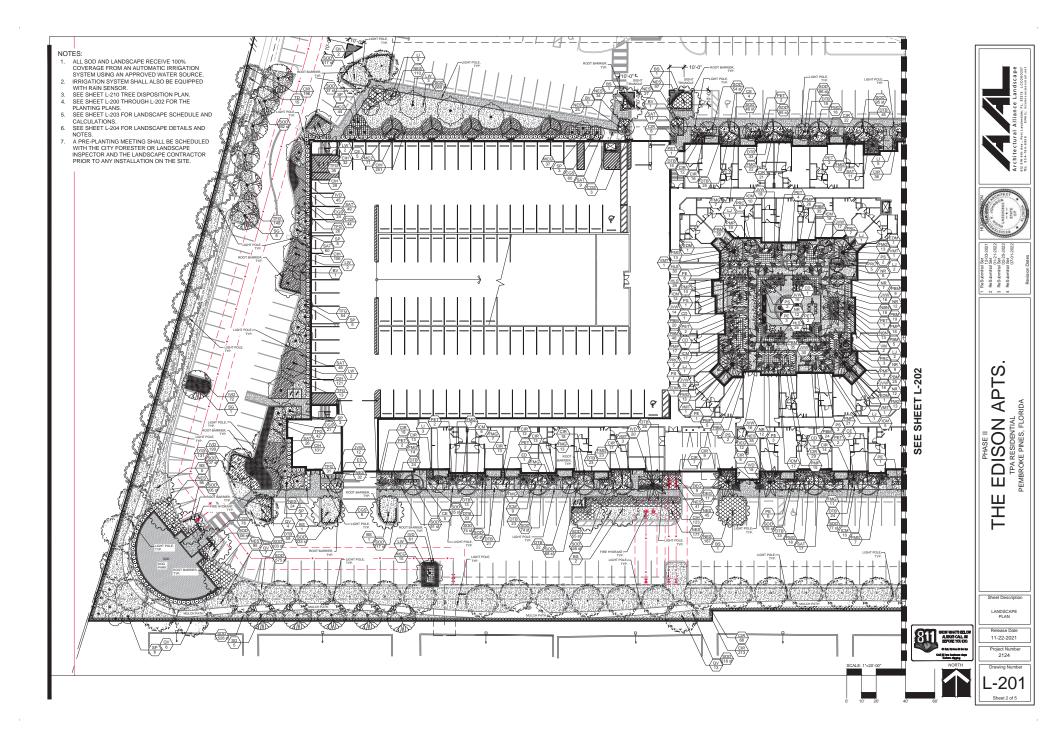

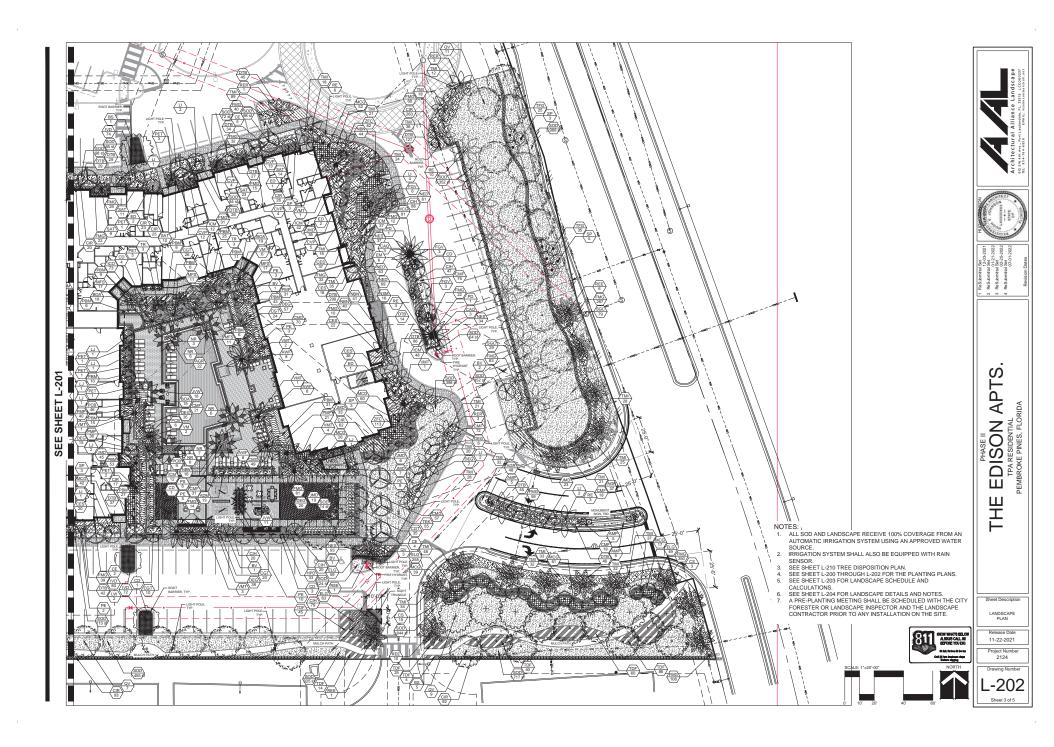

LANDSCAPE CALCULATIONS - MULTIFAMILY

			REQUIRED	PROVIDED
TREE REQUIREMENTS				
ADJACENT TO RIGHT-OF-WAY				
1 TREE PER SO LF				
EAST PERIMETER - SW 145TH AVE	330	/50	7	7
ADJACENT TO PERIMETER				
1 TREE PER 50 LF				
NORTH PERIMETER (INTERNAL BOUNDARY)	0	/50	0	0
SOUTH PERIMETER	993	/50	20	20
WEST PERIMETER	394	/50	8	8
MULTIFAMILY STRUCTURE				
TREES				
1.5 TREE PER UNIT GROUND FLOOR	34	x1.5	51	
1 TREE PER UNIT 2ND FLOOR	49	x1.0	49	
.5 TREE PER UNIT REST OF UNITS	267	x0.5	134	
			234	242
SHRUBS				
25 SHRUBS PER UNIT GROUND FLOOR	34	x25	850	
5 SHRUBS PER UNIT 2ND FLOOR	49	x5	245	
5 SHRUBS PER UNIT 3RD FLOOR	54	x5	270	
0 SHRUBS ADDITIONAL FLOORS	213	x0	0	
			1365	
INTERIOR PARKING AREA				
1 TREE PER 5 SPACES - 172 SPACES	172	/5	34	34
1 TREE FOR EACH 100 SF OF INTERIOR LDSC	7333 sf	/100	73	73
100 SF OF LDSC FOR EVERY 10 SPACES OVER 50	SPACES			
1 SF OF LDSC FOR EVERY 200SF OF PAVED ARE	A OVER 50,	000SF		
TOTAL NUMBER OF REQUIRED TREES			376	384

Royal and Date Palms each count as 1 Tree	42		42
All other Palms count as 3 to 1	160	/3	53
40% - OF TREES TO BE LARGE CAT 1	303	40%	91
50%- OF TREES TO BE NATIVE	276	/467	59%
50%- OF SHRUBS TO BE NATIVE	7.672	/14.994	51%

Total Number of Plants
Total Native Plants (min. 50%)
Total Drought-tolerant Plants (min. 50%) 15,500 7,948 15,476

•••	
1.	AL

- ALL SOD AND LANDSCAPE RECEIVE 100% COVERAGE FROM AN AUTOMATIC IRRIGATION SYSTEM USING AN APPROVED WATER SOURCE.
- IRRIGATION SYSTEM SHALL ALSO BE EQUIPPED WITH RAIN SENSOR.

- SENSOR.
 SEE SHEET L-210 TREE DISPOSITION PLAN.
 SEE SHEET L-200 THROUGH L-202 FOR THE PLANTING PLANS.
 SEE SHEET L-203 FOR LANDSCAPE SCHEDULE AND
 CALCULATIONS.
 SEE SHEET L-204 FOR LANDSCAPE DETAILS AND NOTES.
 A PRE-PLANTING MEETING SHALL BE SCHEDULED WITH THE CITY
 FORESTER OR LANDSCAPE INSPECTOR AND THE LANDSCAPE
 CONTRACTOR PRIOR TO ANY INSTALLATION ON THE SITE.

PLANT SCHE	DULE	TPA EI	DISON APTS BOTHNICAL HAMB	COMMON NAME	CONT	OBH	1028	NATIVE:	DROUGHT	
80000000000000000000000000000000000000	BV BV		BUTWIEL HABI	VERANCOO	rossa	2' CAL	12 HT.X LEPK	NO NO	HEH	
*										
<u> </u>	83	18	BURGERA SMARUBA	GLANIC LANIC	FORMS	F CAL	IE OA, F BPO, E CT.	VEE	HIGH	
\odot	CD	16	COCCOLORA DIVERSIFICIA	PIGEON PLUM	FORMS	3 IFCAL	12 HT. X E SPR., S	van.	нан	
Ã	CII	27	CONOCHIPUS ERECTUS	BUTTONWOOD	ronas	T CAL	12' HT X E BPK, E' CT	1913	нан	
$\stackrel{\sim}{\sim}$				APPARES IL JUSTINEY THE	rosas	POAL	17 HT. X E SPR., STD.			\vdash
<u> </u>	10		BLABOCARPUS DE OPRINS			_		NO CM	HISH	
8	ш	15	GEGETRUM JAPONICUM	THEE LIQUETRUM	FORMS	MULTITRUPK	E-10 DA, HERDY	NO	MIDUM	
\odot	uw	12	LYSEOMA LATISLIQUUM	WLD TAMAKRO	FORMS	IYOM.	NE HE KE SPR	vez	нан	
$\stackrel{\sim}{\sim}$				LIVE DAK HON KIDE	roma			van.		\vdash
<u> </u>	OV.	0	QUENCUS VINSINANA	L/VE OAK HIGH REE	POSMA	LONT	SE-SE HEX F SPR, F CT	VEE	HISH	
63	10	12	STREET CLAUCA	PANADOS TREE	FORMS	21CAL	1214T X 813PM	ven	нан	
0	10	15	TAIODUM DISTORUM	BALD COPRESS	ronas	ITCAL	ICHT XC SPR	vez	нан	
OVERAG TREES	cope	onv	BOTHNICAL NAME	COMMON NAME	CONT	OBH	NCS	NATIVE	DADUGAT	
0	CII.	10	COMDIA SERESTENA	OKANGE GEIGEN THEE	FORMS	LIFCAL	NE HE X E SPIK.	ven	назн	
⊙		20	LAGINITROMA INDICA TURCANDA	TUBICARDRA CRAPE MYRTLE STANDARD	roma	ITCAL	NEHT X ESPIR, STD	NO.	MID.	
	cone	onv	BOTANICAL NAME	COMMON NAME	CONT	OM	5276	NATIVE	DROUGHT	-
*	ю	,	PHORNIX DACTYLIPERA MEDJOOL	MIDJOOL DATE PALM	FORMS		TO CT, SIXTONED ON HTS, NO HUMBIONIS CUT	NO.	нан	
14047	PS.		PHOENIX DYLVESTRIS	NILO GATE PALM	FORMS		12" CT, SIXTONED OR HTS, NO HUMBIOANE CLT	NO NO		
Full I		17						NO CW	HISH	
*	PET	36	PTYCHOSPERSIA SUSCINIS	ALEXADER PILM	FORMS		14 10 10 GA, TRUPLES	NO	HESH	
***	-		PTYCHOSPERIER ELEGANG	SOLITIONS PALM	ronas		810 HT, 6' SPK.	192	HIGH	
	\vdash	-				_	-	\vdash	\vdash	-
*	*22	18	ROVETONEA ELATA	PLORIDA ROYAL PALM	exerna			VES.		
*	**	20	MOVETOWER BLATA	PLONES NOTINE PALM	FORMS		NF CHE, 28' CA, MATCHED	vez.	HESH	
*	NEK	,	ROVETONEA ELATA	PLONEA ROYAL PALM	RELOCATED			van.	\Box	
	Ë	-				-	-	_	\vdash	-
0	D.	en.	SAN, PALISTTO	CABBAGE PALISETTO	FORMS		SE OF DA, VARY HEIGHTE	VES.	HISH	
₩	TH.	4	THRONAL RADIATA	FLORIDA THATOH FALM	FORMS		E OA, TRIPLE TRUNCS	van.	нан	
*	VMT			MONTEOMERY PILM	roma		19-07 CA., TRIPLE TRUNKS	_		
		-						-		
*	w	10	VEITCHA MONTSOMERYANA	MONTEOMERY PILM	FORMS		20-20 CA, ENGLES, HERVY	NO	MIDUM	
· ·	0000	onv	ROTRINCAL NAME RECHMENMALVA	COMBION NAME PURPLE VASE EROMELIAD	CONT	ORM	SIZE SENT X SCIPE	NATIVE	DROUGHT	
0	/w-			MID TH COCOPUM			and same		nun	-
0	Lin.	1,000	CLUBA GUTTIFERA	SWALL-CERF CLUSSA			SE HT KSE SPK	1111	00000	_
*	coa	206	CRININ AUGUSTAN GUSEN SMISK	STREEN BROWN CHANNEL			SOA PAL	100	HEH	-
	CAG	4						100	HOH	_
0	IOM	4	BLASCOMPUS DEGPENS WOMPHOUD	SWARD BETTER AND COM			BHF GA, PULL TO BASE BHF GA	NO	HISH	
0	EN/	4						NO	MIDUM	_
0	FOV	12	PURCHARA DIGANTEA VAREGATA	PALSE ASSIVE			DET CIA	NO NO	HISH	
0	NEW	16	NEORECELIA X MOMET	MONET BROKELIAD			10°OA	NO.	HEH	
Pere	120	24	ACALYPIA WEXERIANA FINE DRADON	SEASE ACKLISHA			SECHT KSIC BPK	NO CM	LOW	37 oz.
, , , , , ,	BGA	86	BESONA ODORATA 'ALBA'	GANE WHITE CHINE REGIONA			12"HT, 12" BPK.	140	MIDUM	Was.
المركبات إقباق	car	117	CLUBA GUTTIPERA	SWALL-LEW CLUSIA			SENT X SEEPS	vez	нан	37 oz.
	CIP	36	CODINEUM VARIBORTUM PRITEX	BRAVO CROTON			MINE X MINE	NO.	нан	25°04.
	CHI	136	COVOCAMPUS ERECTUS SERICEUS	SEVER BUTTON WOOD			SONIT X 24°2PK	ves	нан	2Fee
	DEG	210	DURANTA ERECTA: GOLD MOUND	GOLD MOUND DURANTA			SENT X SESPE	vez	нан	25.00
	HPD	20	HAMELIA PAZENE COMPACTA:	DANNER SCANLET BUSH			20" HT 3.20" SPR	vez	HESH	Mar.
88888	CM	208	DOM COCCNE WAS SARET	MALI SURGET DONA			SOCIAL SOCIAL	192	MIDSM	25.00
	-	n	KORA COCCINER OKANGERED	NORA.			MAG X MAN	un.	MATERIAL STREET	25.00
	M70		NAME AND ADDRESS OF THE OWNER.	PINK MUHLY ORAZI			acht.xacam.	783	weren.	25.00
			SPRICANTHEE PRAGRANG COMPACTA	COMPACT SIMPSON'S STOPPER			SE HT KSE SPK	van.		25.00
	_		PHILODENDRON X BURLE WAXX	Del CONTROL DE LA CONTROL DE L			SENT SEPTE	-		25.00
		Ĕ-	PHLODINDRON X WUNC CONDO	ROJO COVOD PHILODENDRON	-		DOT HT. IL DOT BEFO.	Ľ-		37 as.
	-			E LABORO			DO HT. X DO SPR.	- T	-manufil arms	7 84
	Ĕ-	F			-		SOF HET, AL SOF SIPHS.	<u>~</u>	- Aur	
	707	266	PODDOMPUS SINCHOPHYLLUS	PODDCHIPLIS GOLD CAPILLA AMBORICOLA			30" HT. X 30" SPR. 30" HT. X 30" SPR.	NO THE	HIGH	Han Han
	40C	-M				-		100	MICH	_
	BAT	295	SO-EPPLEKA-MEGRICOLA TRABITE	SCHEPTLERA KING S WINTLE			20" HT. S. 20" SIPE.	NO CM	HEH	25° a.a. 25° a.a.
	CER.	-				-		100	MOUN	_
	tor	274	TRIPEACUM EACTILODES	PAROMATORIE GRAZE	-	<u> </u>	307HT X 307BPM	vez vez	MIDUM	37 ea.
	tro	406 700	TRIPRACIAN FLORIDANA	PLONES GRAMA GRAZE	COMP	7894	20" HT. X 20" SPR.	VEE	HIGH	SF on.
	ADK	107	ARACHE GLABRATA	LANCE LEAF PERSONAL PENSUT			CHET IS THE	NO CM	HESH	U'ee.
	ADM	19	ASPIRAGUS DENSPLORUS WHERE	MYERE ASPIRAGUE			NEWEX NEWS	NO	MIDUM	16° a.e.
	CMS	129	CARGEA MICROCARPIA TREEN CARPET	GREEN CARPET NATAL PLUS			EHEX 12 1910.	NO NO	назн	16° a.e.
	_	206	CARMONA MICROPHYLLA	PURGEN TEA			NEWS X NEWS	NO CM	нан	27 04.
nana ka	CMP		OHYSOBALANUS ICACO HORIZONTALIS	HORIZOATAL COCOPLUM			12747 X 1678PR (I)	vez	нан	20° e.s.
	сы	1,016					NEWS X NEWS SPEE	NO CM	MIDUM	Was.
	сы	1,016	DANIELLA TRIMANICA	BLUEBBRRY PLAX LILY					_	Was.
3,032,0	сы	1,016		SCHERRY FLAX LLY COLDEN CREEPER			12" HT. X 12" SPR	vez.	нен 1	
3,032,0	сы	1,016 1,006 629	DANELLA TREMANICA				12" HT. X 12" SPR.	VEE NO	HIGH	25.00
2,000,00	сы	1,015	DANBILLA TARMANICA ERNOCERALITIONALE PICUE MICHOCARPA "ORIEN ISLAND"	OCIDEN CREEPER ORIEN ISLAND FICUS			SECRET X SECURITY.	NO	HEH	20" 0.6.
3,032,0	сы	1,696 1,696 639 1,611 80	DAMBILIA TRIMANICA ERNOCEIA LITTORALIS	GOLDEN CREEPER				VES NO VES	HIGH HIGH HIGH	
25.25.2 WWW.	CH ETB ELG PAG HLE	1,646 1,646 639 1,611 80	DANBLIA TARRANDICA BENCORA LITTORALIS PICUS MICHICAPA DEREN IBLADO VAMENOCIALIS LATPICIA LEX VOMETORIA STORES DIRAPF	GOLDIN CHEEPER GREEN GLING PICHE BPDEK GLY DAWET TREPON HOLLY			12" MT. X 12" 3896. 12" MT. X 12" 3896. 12" MT. X 12" 3896.	NO	HEH HEH HEH	35° a.a. 16° a.a.
25.25.2 WWW.	CH ETB ELG PAG HLE	1,646 1,646 239 1,671 80 801	DANBILLA TARMANICA ERNOCERALITIONALE PICUE MICHOCARPA "ORIEN ISLAND"	OCIDEN CREEPER ORIEN ISLAND FICUS			16" MT. X 16" 20"E. 12" MT. X 12" 20"E. 16" MT. X 10" 20"E. 16" MT. X 10" 20"E.	NO	HIGH HIGH HIGH MIGH	20" 0.6.
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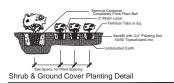
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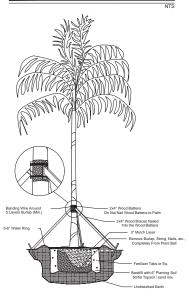
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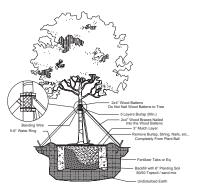
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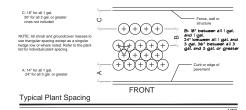




Palm Planting Detail



Large Tree Planting Detail






NOTE:

PROVIDE ROOT BARRIERS AS REQUIRED ON ALL TREES IN CONFLICT WITH MINIMUM CLEARANCE WITH UTILITIES.

MINIMUM CLEARANCE OF 5' FT FOR PALMS AND SMALL TREES AND 10' FT FOR LARGE TREES WITH INTRUSIVE

ROOT SYSTEMS PER CITY OF FORT LAUDERDALE REQUIREMENTS. SEE TYPICAL DETAIL BELOW.

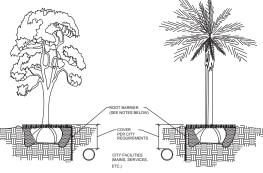

- ALL ROOT BARRIERS SHALL BE INSTALLED IN ACCORDANCE WITH MANUFACTURERS WRITTEN INSTRUCTIONS.

Typical Root Barrier Detail

CLEARANCES FOR ANY AND ALL UNDERGROUND UTILITIES MUST BE COORDINATED WITH THE LOCAL COVERING AGENCY AMED/OR THE INDIVIDUAL UTILITIES AND/OR U.N.C.L.E. PLANT MATERIAL TO BE SPECIFIED ON THE PLANS 24" X 24", 2" O.C. OR LARGER PER THE LOCAL REQUIREMENTS GUARITY TO BE PER THE SIZE OF THE 3" IN. APPROVED RECYCLED MULCH FOR ALL PLANTING AREAS. PROVIDE OPENING FOR ACCESS ON ON SIDE OR AS REQUIRED BY THE UTILITY. MECHANICAL EQUIPMENT SCREENING DETAIL

SPECIAL INSTRUCTIONS:

- GENERAL SITE AND BERM GRADING TO +/- 1 INCH (1") SHALL BE PROVIDED BY THE GENERAL CONTRACTOR. ALL FINISHED SITE GRADING AND FINAL DECORATIVE BERM SHAPING SHALL BE PROVIDED BY THE LANDSCAPE CONTRACTOR
- ALL SOD AREAS AS INDICATED ON THE PLANTING PLAN SHALL RECEIVE STENOTAPHRUM SECUNDATUM, ST. AUGUSTINE 'PALMETTO' SOLID SOD. IT SHALL BE THE RESPONSIBILITY OF THE LANDSCAPE CONTRACTOR TO INCLUDE IN THE BID, THE REPAIR OF ANY SOD WHICH MAY BE DAMAGED FROM THE LANDSCAPE INSTALLATION OPERATIONS.

NOTES:

- ALL SOD AND LANDSCAPE RECEIVE 100% COVERAGE FROM AN AUTOMATIC IRRIGATION SYSTEM USING AN APPROVED WATER SOURCE.
- 2. IRRIGATION SYSTEM SHALL ALSO BE EQUIPPED WITH RAIN SENSOR.
- SEE SHEET I -210 TREE DISPOSITION PLAN.
- SEE SHEET L-200 THROUGH L-202 FOR THE PLANTING PLANS.
 SEE SHEET L-203 FOR LANDSCAPE SCHEDULE AND
- SEE SHEET L-204 FOR LANDSCAPE DETAILS AND NOTES.
- A PRE-PLANTING MEETING SHALL BE SCHEDULED WITH THE CITY FORESTER OR LANDSCAPE INSPECTOR AND THE LANDSCAPE CONTRACTOR PRIOR TO ANY INSTALLATION ON THE SITE

GENERAL PLANTING REQUIREMENTS

All sizes shown for plant material on the plans are to be considered Minimum. All plant material must meet or exceed these minimum requirements for both height and spread. Any other requirements for specific shape or effect as noted on the plan(s) will also be required for final acceptance.

All plant material furnished by the landscape contractor shall be Florida #1 or better as established by "Grades and Standards for Florida Nursery Plants" and "Grades and Standards for Florida Nursery Trees". All material shall be installed as per CSI specifications.

All plant material as included herein shall be warrantied by the landscape contractor for a minimum period as follows: All trees and palms for 12 months, all shrubs, vines, groundcovers and miscellaneous planting materials for 90 days, and all lawn areas for 60 days after final acceptance by the owner or owner's representative.

All plant material shall be planted in planting soil that is delivered to the site in a clean loose and friable condition. All soil shall have a well drained characteristic. Soil must be free of all rocks, sticks, and objectionable material including weeds and weed seeds as per CSI

Twelve inches (12") of planting soil 50/50 sand/topsoil mix is required around and beneath the root ball of all trees and palms, and 1 cubic yard per 50 bedding or groundcover plants.

All landscape areas shall be covered with Eucalyptus or sterilized seed free Melaleuca mulch to a minimum depth of three inches (3") of cover when settled. A four-inch clear space must be left for air between plant bases and the mulch. Cypress bark mulch shall not be used.

All plant material shall be thoroughly watered in at the time of planting; no dry planting permitted.

All plant materials shall be planted such that the top of the plant ball is flush with the surrounding grade.

All landscape and lawn areas shall be irrigated by a fully automatic sprinkler system adjusted to provide 100% coverage of all landscape areas. All heads shall be adjusted to 100% overlap as manufacturers specifications and performance standards utilizing a rust free water source. Each system shall be installed with a rain sensor.

It is the sole responsibility of the landscape contractor to insure that all new plantings receive adequate water during the installation and during all plant warranty periods. Deep watering of all new trees and palms and any supplemental watering that may be required to augment natural rainfall and site irrigation is mandatory to insure proper plant development and shall be provided as a part of this contract.

All plant material shall be installed with fertilizer, which shall be State approved as a complete fertilizer containing the required minimum of trace elements in addition to N-P-K, of which 50% of the nitrogen shall be derived from an organic source as per CSI specifications.

Contractors are responsible for coordinating with the owners and appropriate public agencies to assist in locating and verifying all underground utilities prior to excavation.

All ideas, designs and plans indicated or represented by this drawing are owned by and are the exclusive property of AAL.

The plan takes precedence over the plant list.











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Sheet Description LANDSCAPE NOTES AND DETAILS

Release Date 11-22-2021

Project Number

Drawing Number L-204

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